


LA COUNTY

The LA County ADU is a one-bedroom, onebathroom ADU designed with a classic Spanish architectural style. The exterior features a lightcolored stucco finish, creating a warm and traditional aesthetic. A simple gable roof, with a shallow slope, provides shelter and complements the overall design.

Inside, this plan boasts a simple L-shaped layout designed for comfortable living. The living and dining areas are merged into a single room, creating a versatile space. The bedroom is thoughtfully located on one side of the plan, offering a private and quiet retreat. The kitchen and bathroom are strategically placed between the living area and the bedroom, creating separation and enhancing functionality.

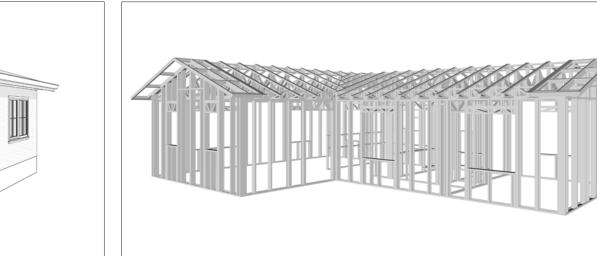

Materials Shopping List

Please print and take this Materials Shopping List to your favorite Home Depot and ask for assistance in selecting the materials, fixtures and fittings to complete your new home.

Record your selection and the price of the item. Then do the math to determine the cost for your selections and the total cost of finishing your home.



To Go To Materials Shopping List



FLOOR PLAN





42' - 2" DINING ROOM 102 SF KITCHEN 96 SF BEDROOM 143 SF LIVING ROOM 248 SF GROUND FLOOR PLAN

TABLE OF CONTENTS

RENDERINGS	ABOUT THE HOME -	•
1	RENDERINGS -	— O:
FLOOR PLAN	SCHEMATIC FLOOR PLAN	─ 0 :
ABOUT 1	ABOUT FrameUpNow	
DESCRIPTIONS 2	BOM (Bill Of Materials) STRUCTURAL ARCHITECTURAL MECHANICAL ELECTRICAL PLUMBING	O2 O2 O2 O2 O2
MATERIALS LIST 2	MATERIALS LIST PREVIEW	O 2
HOW TO BUILD	CONSTRUCTION STEPS -	O2
ARCHITECTURAL	COVER SHEET -	—— O:

FLOOR PLAN + DIMENSION PLAN +

FOUNDATION PLAN STRUCTURAL FLOOR PLAN -WALL FRAME LAYOUT ROOF TRUSS LAYOUT ROOF PLAN + ARCHITECTURAL ELEVATIONS -ARCHITECTURAL ELEVATIONS -ARCHITECTURAL SECTIONS -ARCHITECTURAL DETAILS

ARCHITECTURAL CASEWORK

STRUCTURAL

MECHANICAL

ELECTRICAL

PLUMBING

MATERIALS

SHOPPING LIST

COVER SHEET	—— 16
GENERAL NOTES	17
WALL FRAME LAYOUT	18
WALL PANEL & LAYOUT PLAN	— 19
ROOF TRUSS LAYOUT	 20
STRUCTURAL SECTIONS	21
WALL BRACING LAYOUT	22
HOLD-DOWN PLAN	23
STRUCTURAL DETAILS 1	 24
STRUCTURAL DETAILS 2	25
STRUCTURAL DETAILS 3	—— 26
TRUSS BLOCKING LAYOUT	 27
SHEETROCK BACKING	28
ROOF BRACING LAYOUT	—— 29
COVER SHEET -	30
HVAC PLAN -	31
SCHEDULE -	32
LIGHTING -	33
POWER PLAN	 34
DIMENSION FOR LIGHTING -	35
DIMENSION FOR FITTING -	36
NOTES AND SCHEDULES -	37

WATER SUPPLY & SEWAGE SYSTEM # 38

MATERIALS SHOPPING LIST

ABOUT



FrameUpNow is a design and manufacturing company providing precision-engineered home framing solutions. We offer a catalog of Affordable Homes, Tiny Homes, Garages, Shops and Barndominiums. FrameUpNow manufactures cold-formed steel (CFS) also known as Light Gauge Steel (LGS) framing components that conform to our engineered metal house frame plans or can be purchased as DIY skeleton kits.

The CFS/LGS framing is lightweight, easily assembled, and does not require heavy equipment or specialized labor, enabling homeowners to erect the frame themselves in just a few days. Unlike wood, the steel framing is impervious termites and bores, warping, expansion, and fire.

Our home plans come complete with a structural engineered stamp for permit approvals. Customers receive a full BOM also known as a Materials Shopping List to purchase finish materials from a Building Materials retailer. FrameUpNow prides itself on the quality and efficiency of our precision-engineered home framing solutions for construction professionals and DIY homeowners.



KEY PLAN

NO.	DESCRIPTION	DATE

NOTE:

LEGEND:

PROJECT

LA County-800-1Bd1Ba-550

DRAWING NAME

INTRODUCTION

CLIENT NAME:
PROJECT NUMBER:
DATE:
DESIGNED BY:
DRAWN BY:
CHECKED BY:

I101

SCALE:

DISCLAIMER

DISCLAIMER: This documentation and all it's contents are the intellectual property of FrameUpNow. It is provided solely for marketing the services of FrameUpNow. The preliminary information is not approved for actual construction use and is not warranted to be complete or accurate. Unauthorized copying, distribution, or application of these proprietary materials, in any form or format, is strictly prohibited. FrameUpNow assumes no liability for any issues arising from improper use of this marketing content.

DESCRIPTIONS

MATERIALS LIST

The BOM (Bill Of Materials) package, known as the Materials Shopping List document, provides:

Comprehensive Inventory: Detailed lists of essential materials sourced from architectural, mechanical, HVAC, electrical, and plumbing design drawing sets.

Precise Curation: Each item meticulously selected and organized for accuracy and efficiency in project planning.

Customizable Options: Customers can modify listed items to their preferences and calculate costs accordingly, ensuring alignment with personal project needs and budget.

Dedicated Space for Details: Includes tables for customers to note Home Depot SKU numbers or product descriptions for selected items,

facilitating seamless purchasing and coordination with suppliers.

Customer Convenience: Take the list to Home Depot or preferred suppliers for accurate pricing, helping align the total home budget with personal financial plans.

Simplify your construction journey with our Materials Shopping List document, where detailed preparation meets streamlined implementation for your dream home.

STRUCTURAL

The structural drawings package provides an exhaustive set of detailed plans essential for the precise assembly of your building. This comprehensive package includes:

Framing Plans: Detailed layouts for all framing components. Truss Layouts: Clear instructions for truss placement and

Panel Length Plans: Specifications for panel dimensions. Framing Elevations and Sections: Precise elevation and sectional views for accurate construction.

Truss and Wall Blocking Plans: Plans for truss and wall blocking to ensure structural integrity.

Hold-Down Plan: Detailed hold-down requirements for stability. Snap Sheet: Reference sheet for quick identification of components

Structural Details and Bracing Plans: Complete details and bracing plans for all structural elements.

Accompanying these plans is a comprehensive Bill of Materials (BOM) that lists every necessary building component, from cold formed steel (CFS) frames to fasteners.

ARCHITECTURAL

With the comprehensive architectural package, both builders and DIY homeowners can confidently execute the construction.

The architectural package includes:

Furnished Floor Plans: Complete with furniture layouts for a clear understanding of space utilization.

Detailed Dimension Plans: Ensures precise measurements, from the overall footprint down to the exact placement of windows and

Foundation Plan: Detailed plan to establish a solid foundation.

Wall Framing and Truss Layout: Comprehensive plans for wall framing and truss placement.

Architectural Elevations: Exterior views showcasing the design.

Strategic Building Sections: Critical cross-sectional details for a thorough understanding of the build.

Casework Drawings and Diagrams: Suggested designs for built-in caseworks, such as kitchen cabinets.

MECHANICAL ELECTRICAL

The mechanical package includes everything needed to guide HVAC

Detailed HVAC Floor Plan: Precisely maps out the placement of air handlers, ductwork, and vents throughout the home's layout.

HVAC Sections and Riser Diagrams: Technical drawings offering critical cross-sectional details and piping schematics, ensuring proper integration of the heating and cooling system into the home's structure.

Bill of Materials: A complete list of all necessary HVAC components.

The electrical package includes all the plans and documentation needed to guide the installation of your home's electrical system:

Detailed Power Plan: Precisely maps out the placement of outlets, switches, and other power components throughout the layout.

Comprehensive Lighting Plan: Shows the optimal locations for lighting fixtures, sconces, and other illumination sources to create a well-lit, functional interior.

Dimensioned Electrical Layout: Provides exact dimensions and measurements to ensure proper placement of all electrical elements.

Bill of Materials: A complete list of every component needed, from circuit breakers to wiring.

PLUMBING

The plumbing package includes everything needed to guide the installation of your home's water supply and drainage systems:

Detailed Water Supply System Plan: Precisely maps out the placement of pipes, valves, and plumbing fixtures throughout the

Comprehensive Sewage System Plan: Shows the optimal routing and sizing of drain lines to effectively remove waste and ensure

proper drainage.

Detailed Riser Diagrams: Provide information needed to properly install all vertical plumbing risers and vent stacks.

Bill of Materials: A complete list of every component needed, from pipes to fixtures.


BOM (Bill Of Materials) (Separately Attached)





The Bill of Materials (BOM) is a crucial document that compiles the material requirements from different disciplines into a centralized inventory, enabling efficient procurement, inventory management, and cost estimation for a specified project or

ELECTRICAL BOM



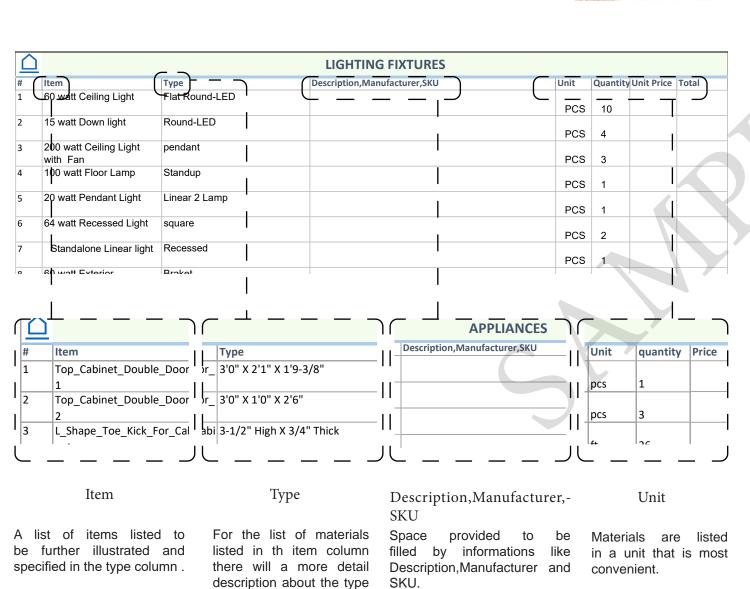

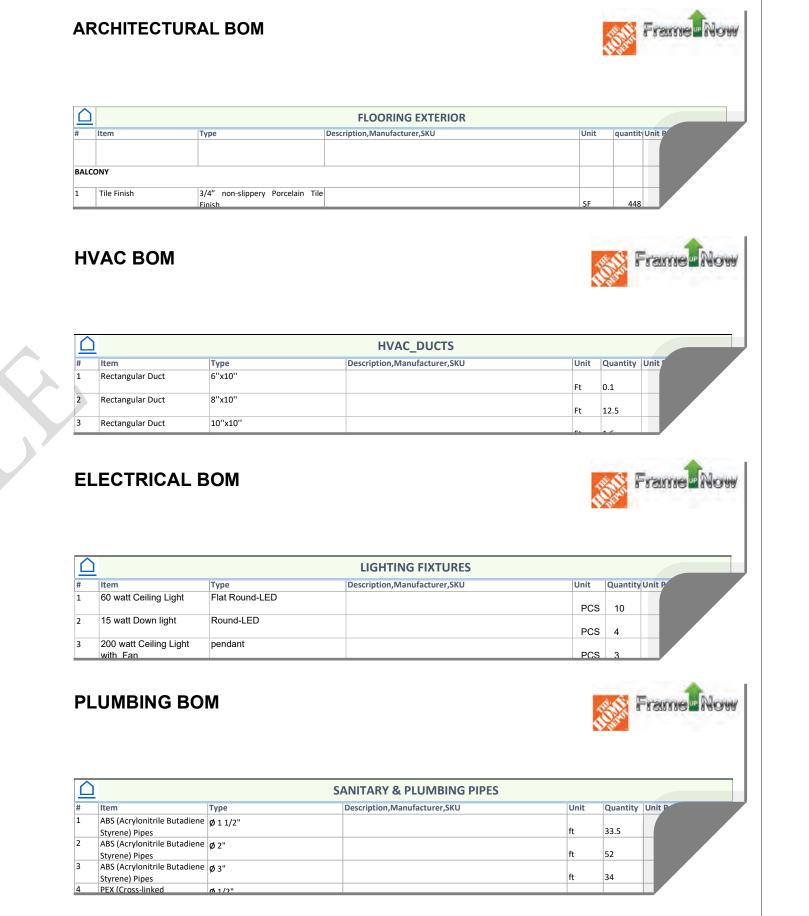

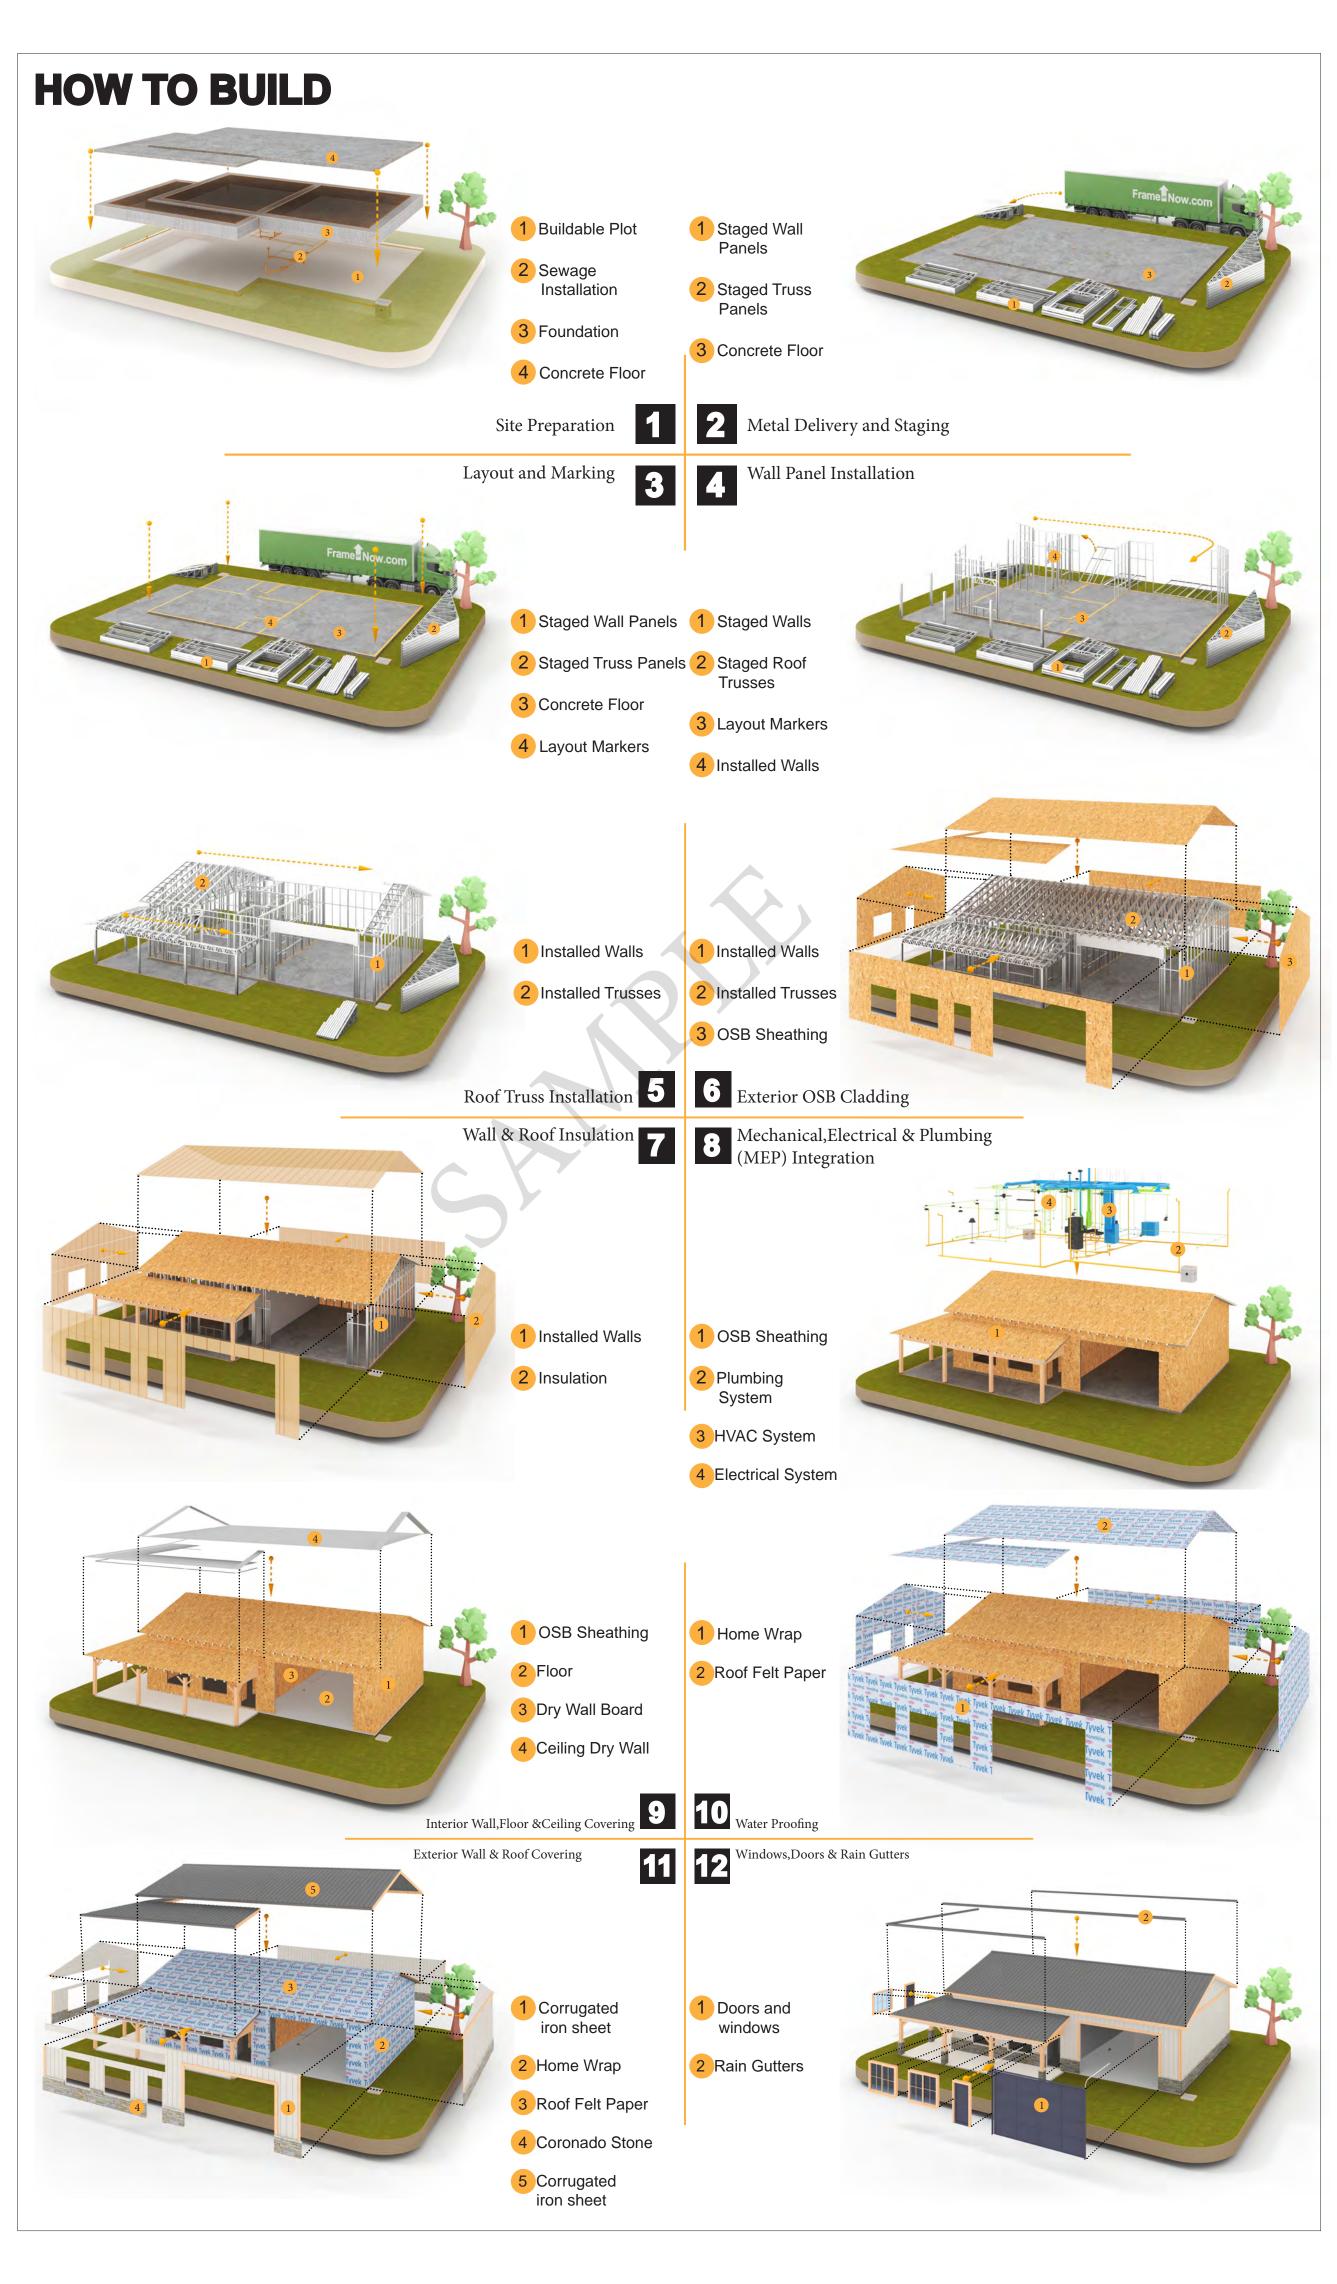



KEY PLAN

NO.	DESCRIPTION	DATE

NOTE:

LEGEND:

PROJECT

LA County-800-1Bd1Ba-550

DRAWING NAME


INTRODUCTION

CLIENT NAME: PROJECT NUMBER: DATE: **DESIGNED BY** DRAWN BY: CHECKED BY:

1102

SCALE:

of the Material.

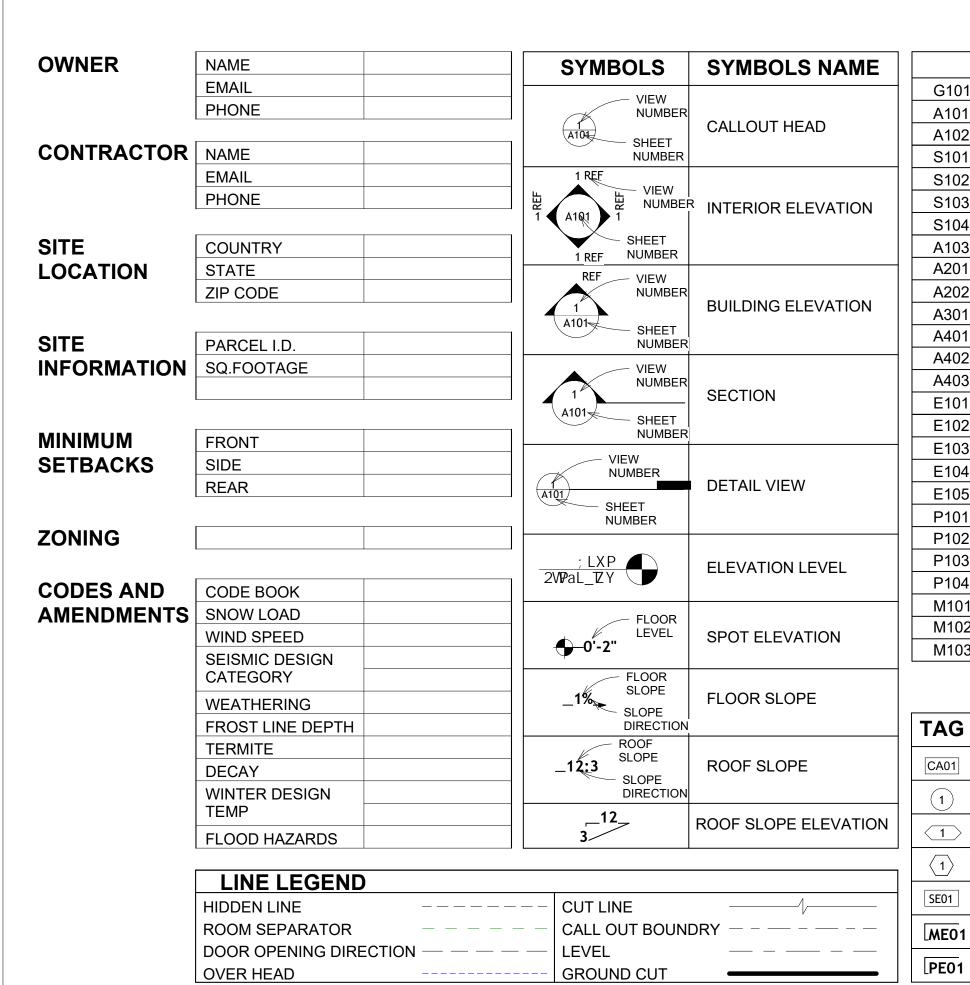

1		
		PAGE INDEX
1	G101	COVER SHEET
	A101	FLOOR PLAN
	A102	DIMENSION PLAN
	S101	FOUNDATION PLAN
	S102	STRUCTURAL FLOOR PLAN
	S103	FRAME LAYOUT
	S104	ROOF TRUSS LAYOUT
	A103	ROOF PLAN
1	A201	ELEVATIONS
	A202	ELEVATIONS
	A301	SECTIONS
	A401	DETAILS
1	A402	CASEWORK DETAILS
	A403	CASEWORK DETAILS
	E101	SCHEDULE
	E102	LIGHTING PLAN
1	E103	POWER PLAN
	E104	DIMENSION PLAN FOR LIGHT FIXTURE
	E105	DIMENSION PLAN FOR FITTING
	P101	COVER SHEET
1	P102	WATER SUPPLY SYSTEM
	P103	SEWAGE SYSTEM
	P104	RISER DIAGRAM
1	M101	HVAC PLAN
	M102	HVAC SECTION
	M103	RISER DIAGRAM
1		

SE01

TAG'S NAME		HOLDDOWN
	SIMP. ABE66	SIMPSON ANCHOR BOLT
CASEWORK TAG	TV	TELEVISION
DOOR TAG	UNO	UNLESS NOTED OTHERW
ELIDAUTURE TAO	W/	WITH
FURNITURE TAG	W/D	WASHER/DRYER
WINDOW TAG	AC	AIR CONDITIONING UNIT
SPECIALTY EQUIPMENT TAG	ACC	AIR COOLED CONDENSER
MECHANICAL FOLIDMENT TAC	ACCU	AIR COOLED CONDSENSING
MECHANICAL EQUIPMENT TAG	AHU	AIR HANDLING UNIT
PLUMBING EQUIPMENT TAG	CC	COOLING COIL
	CD	CEILING DIFFUSER
	CFm	Cubic Feet Per Minute
	CR	CEILING REGISTER
	CU	CONDENSING UNIT
	CW	COLD WATER
	E/A	EXHAUST AIR
	EF	EXHAUST FAN
	ET	EXPANSION TANK
	EX.	EXISTING
	FC	FLEXIBLE CONNECTION
	FCU	FAN COIL UNIT
	FLR.	FLOOR
	HC	HEATING COIL
	HE	AIR TO AIR HEAT EXCHAN
	HV	HEATING AND VENTILATING
	IV	INLET VANES
	MER	MECHANICAL ROOM
	MAX.	MAXIMUM
	MIN.	MINIMUM

S/A SCD SP

RECIPROCATING CHILLER UNIT

SMOKE CONTROL DAMPER

RETURN FAN

STATIC PRESSURE

F.F.E

F.F.L

FTG

HVAC

MAX.

ME

MIN.


O.C

OSB

PSI


PVC

REF

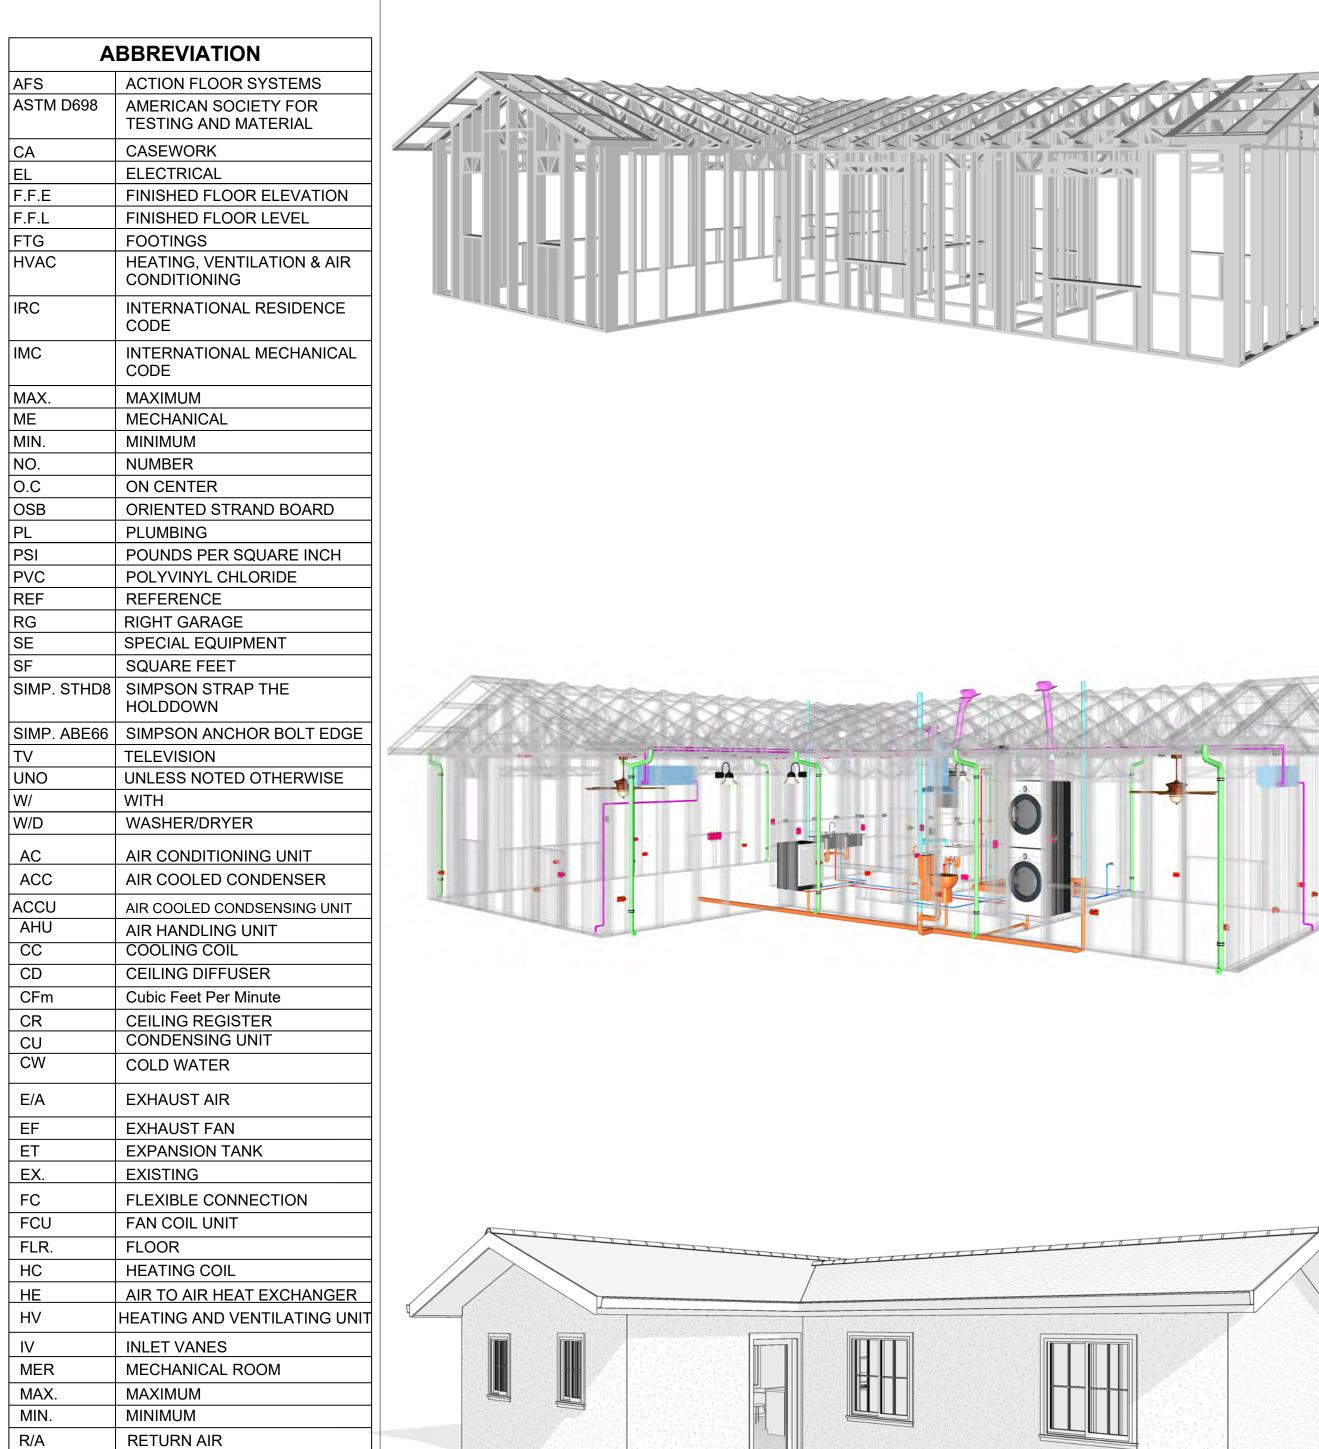

LA County-800-1Bd1Ba 550

SQUARE FOOT	AGE
LIVING	800
TOTAL	800

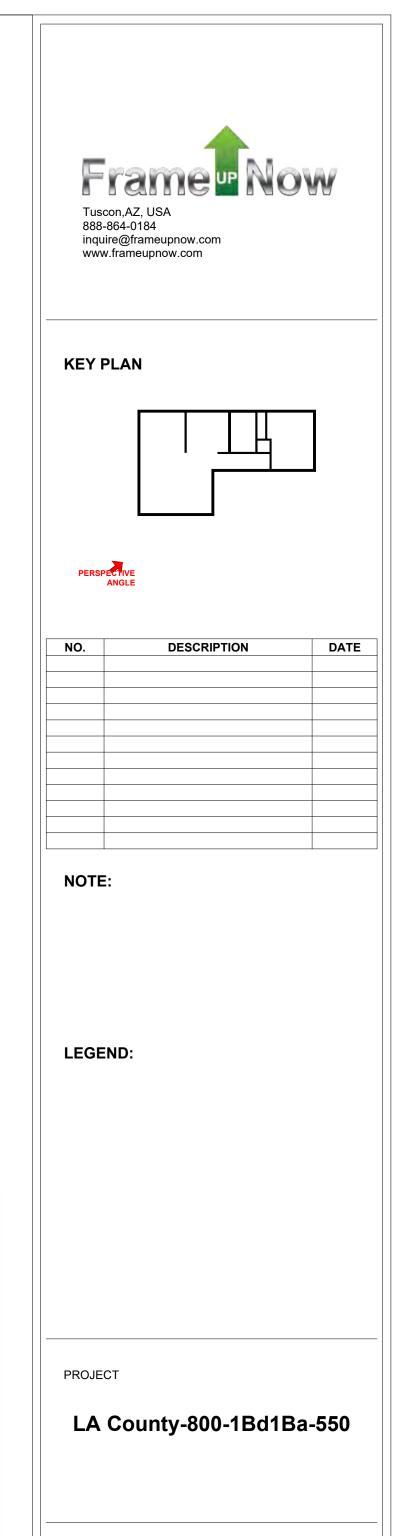

DRAWING NAME **COVER SHEET**

CHECKED BY:

Client Name PROJECT NUMBER: 0061_12 4/10/2025 2:33:17 PM Designer DESIGNED BY: DRAWN BY:

Checker

G101 SCALE: As indicated

GENERAL NOTES

- 1. THIS DRAWING DEPICTS THE ARCHITECTURAL (SPACE LAYOUT, FURNISHING, FLOOR, WALLS, ROOFS, FOUNDATION, WINDOWS AND DOORS) SYSTEMS. IT PROVIDES A VISUAL REPRESENTATION OF THE ARCHITECTURAL LAYOUT AND COMPONENTS.
- THE ARCHITECTURAL DRAWINGS ARE PREPARED TO MEET THE SPECIFIC REQUIREMENTS OF THE BUILDING, AS PER THE PROJECT SPECIFICATIONS AND APPLICABLE CODES AND STANDARDS.
- THE CONSTRUCTION OF THIS HOME SHALL COMPLY WITH THE LATEST EDITION OF THE INTERNATIONAL RESIDENTIAL CODE (IRC), INTERNATIONAL MECHANICAL CODE (IMC), THE INTERNATIONAL PLUMBING STANDARD, THE NATIONAL ELECTRICAL STANDARD AND ALL OTHER APPLICABLE LOCAL, STATE, AND NATIONAL CODES AND REGULATIONS.
- 4. COORDINATION WITH OTHER TRADES HAS BEEN DONE ON A DESIGN LEVEL. THIS DRAWING SHALL BE READ TOGETHER WITH THE ME, EL AND PL DESIGN DRAWINGS TO ENSURE PROPER CONSTRUCTION AND INTEGRATION OF THE BUILDING SYSTEMS.

ABOUT WALLS:

SHOWER WALL COVERING

BATHTUB AND SHOWER SPACES (WALLS AND FLOORS) WITH INSTALLED SHOWER HEADS AND IN SHOWER COMPARTMENTS SHALL BE FINISHED WITH A NON-ABSORBENT SURFACE.

WALL PAINT (INTERNAL)

THE TYPICAL THICKNESS OF LATEX WALL PAINT IS 1/32 OF AN INCH FOR A SINGLE COAT. AND DOUBLE COAT (1/16") SHALL BE APPLIED FOR DURABILITY.

ADHESIVES:

THE ADVISABLE TYPE OF ADHESIVE FOR THIS PROJECT IS **EPOXY ADHESIVES**BECAUSE THEY ARE KNOWN FOR THEIR HIGH STRENGTH, DURABILITY, AND RESISTANCE TO MOISTURE, CHEMICALS AND


REFER TO SHEETS A201 & A202 FOR GENERAL NOTES ON EXTERNAL FINISHING MATERIALS

ABOUT FLOORS:

- 1. THE SPOT ELEVATION INDICATES THE FINISHED FLOOR ELEVATION.
- FINISHED FLOORS PER PLANS.
- 3. FIELD VERIFY FOR DIMENSION DROP 4" FOR SHOWER AND BATHTUB USE.
- 1% SLOPE ON OUTDOOR BALCONIES FOR WATER RUN OFF.
- 2% SLOPE TOWARDS THE SHOWER DRAIN FOR SUFFICIENT DRAINAGE.
- 4" DROP AT THE DOOR LEADING TO EXTERIOR BALCONY FROM THE MAIN LIVING AREA.
- 5% SLOPE FOR GARAGE IS USED, WHICH SHOULD BE CHECKED WITH THE LOCAL GARAGING ZONING LAWS.

	FURNITURE SCHE	DULE
TYPE MARK	TYPE	COUNT
1	KING SIZE BED	1
	25" X 60" DINING	1
3	DINING CHAIR	2
4	25" X 60" DINING 2	1
5	FOUR SIT 85" X 85"	1
3	TV STAND	1
)7	TV	1

		RO	OM FINISH	SCHEDULE			
ROOM NUMBE R	ROOM NAME	FLOOR FINISH	BASE FINISH	WALL FINISH	CEILING FINISH	CEILING HEIGHT	COM MEN TS
01	LIVING ROOM	HARDWOOD	CONCRETE	WALL PAINT	DRY WALL	8' - 0"	
02	DINING ROOM	HARDWOOD	CONCRETE	WALL PAINT	DRY WALL	8' - 0"	
03	KITCHEN	HARDWOOD	CONCRETE	WALL PAINT + CERAMIC	DRY WALL	8' - 0"	
04	BEDROOM	HARDWOOD	CONCRETE	WALL PAINT	DRY WALL	8' - 0"	
05	BATH	VINYL TILES	CONCRETE	CERAMIC TILE	MRD	8' - 0"	
06	CL	HARDWOOD	CONCRETE	WALL PAINT	DRY WALL	8' - 0"	
07	WD	HARDWOOD	CONCRETE	WALL PAINT	DRY WALL	8' - 0"	
08	HALL	HARDWOOD	CONCRETE	WALL PAINT	DRY WALL	8' - 0"	

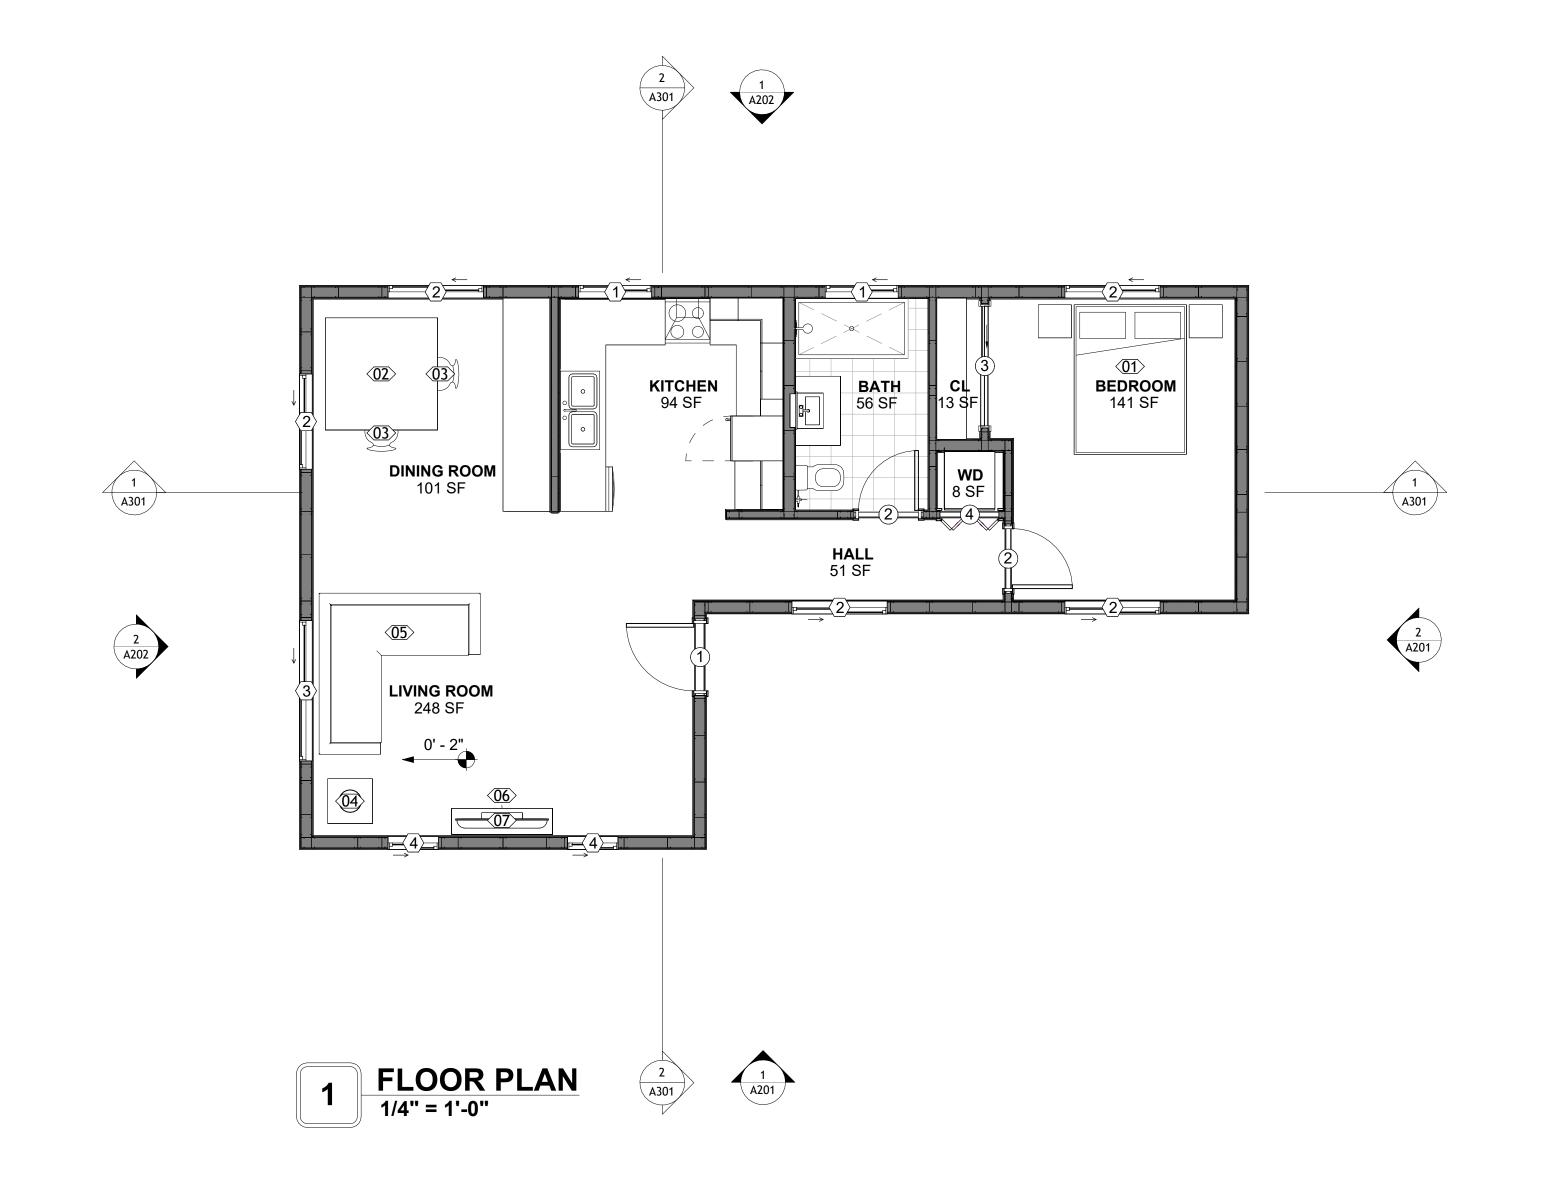



NO.	DESCRIPTION	DATE

NOTE:

LEGEND:

LA County-800-1Bd1Ba-550


DRAWING NAME

FLOOR PLAN

Client Name	CLIENT NAME:
0061_12	PROJECT NUMBER:
4/10/2025 2:33:18 PM	DATE:
Designer	DESIGNED BY:
Author	DRAWN BY:
Checker	CHECKED BY:

SQUARE FOOTAGE 800 TOTAL

A101 SCALE: 1/4" = 1'-0"

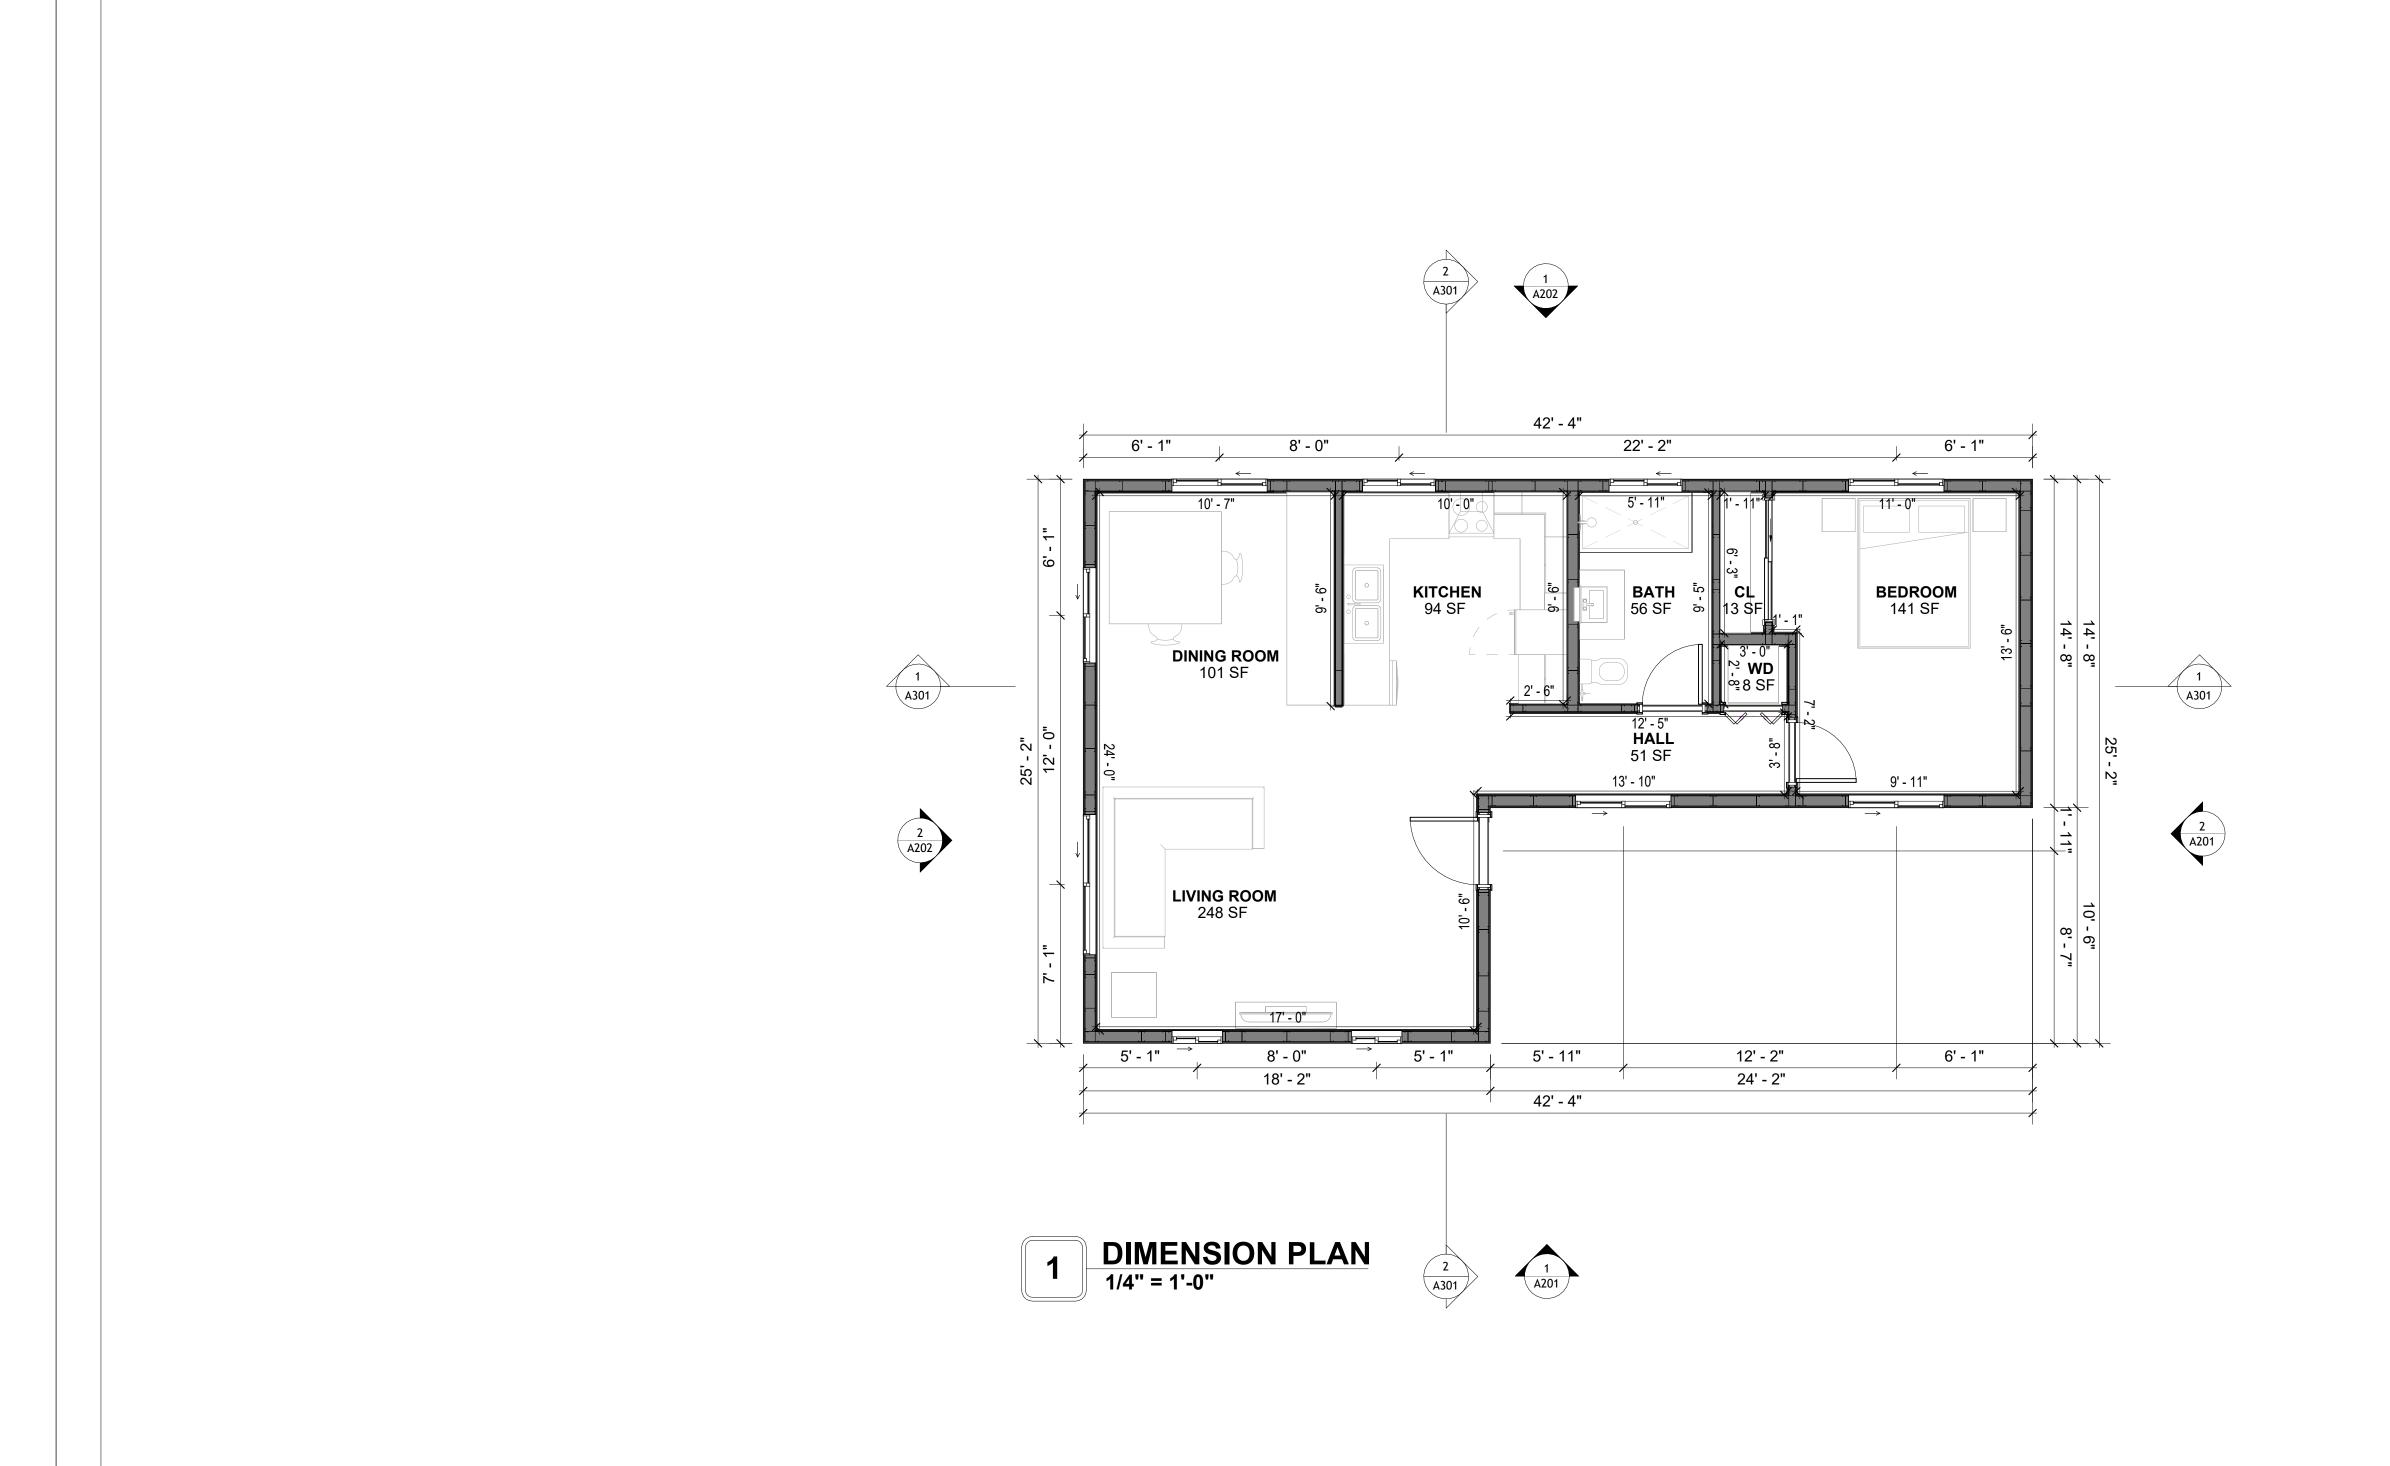

Tuscon,AZ, USA 888-864-0184 inquire@frameupnow.com www.frameupnow.com

KEY PLAN

NO.	DESCRIPTION	DATE

NOTE:

LEGEND:

PROJECT

LA County-800-1Bd1Ba-550

DRAWING NAME

DIMENSION PLAN

	Client Name
:	0061_12
4/	10/2025 2:33:19 PM
	Designer
	Author
	Checker

SQUARE FOOTAGE
LIVING 800
TOTAL 800

A102

SCALE: 1/4" = 1'-0"

DIMENSIONS IN THE ARCHITECTURAL DRAWINGS CONSIDER FINISHING MATERIALS. FOR PRECISE MEASUREMENTS OF THE STRUCTUAL FRAMING, REFER TO THE ATTACHED STRUCTURAL PLAN SET.

FOUNDATION NOTES

TERMITES PRETREATMENT BY LICENSED CONTRACTOR UNDER SLAB AND AROUND FOOTINGS. ALL AREAS BELOW SLABS SHALL BE TREATED NO MORE THAN 24 HOURS PRIOR TO CONCRETE POUR. EVIDENCE OF TREATMENT MUST BE PROVIDED PRIOR TO PLACING OF CONCRETE.

1. **MATERIALS:**

ALL INTERIOR CONCRETE SLABS SHALL BE A MIN. OF 4" THICK CONCRETE OVER 4" COMPACTED AGGREGATE BASE (ASTM D698), FINISH ELEVATIONS AS NOTED ON DRAWINGS, 6" ABOVE ADJACENT GRADE, LEVEL SLABS TO 1/8"-10' MAX.. CONCRETE SLABS SHALL BE 2500# PSI AT 28 DAYS. A 4" ALLOWABLE SLUMP.

2. **PAD PREPARATION:**

- EXCAVATION FOR FOOTING SHALL BE NEAT.

- FOOTINGS SHALL BE POURED IMMEDIATELY AFTER EXCAVATION AND APPROPRIATE INSPECTION.

- ALL REINFORCING STEEL MARKED "CONTINUOUS" SHALL BE LAPPED 36 BAR DIAMETERS AT SPLICES AND AROUND CORNERS OR INTERSECTIONS WITH A STANDARD 90 DEGREE BEND ON CORNER BARS. LAP WIRE MESH ONE FULL MESH AT SIDE AND END LAPS. - ALL HARDWARE TO BE SIMPSON OR EQUIVALENT.

- EXTERIOR FRAME WALL TO BE SECURED WITH 1/2"X10" ANCHOR BOLTS 4'-0" O.C. FOR 1-STORY AND 2'-8" O.C. FOR 2-STORY. BOLTS SHALL BE LOCATED WITHIN 1'-0" OF EACH END PIECE AND SHALL HAVE A MIN. OF TWO BOLTS PER PIECE.

-FOUNDATION ANCHOR STRAPS SHALL BE PERMITTED, ACCORDING TO RESIDENTIAL CODE

2021 - ALL INTERIOR WALLS TO BE SECURED WITH POWER DRIVEN PINS PER MANUFACTURER SPECIFICATION USE PIN SPACING EQUIVALENT TO 1/2" ANCHOR BOLTS.

- ALL CONSTRUCTION TO CONFORM TO THE 2012 IRC - R-10 RIGID INSULATION OUTSIDE OF EXTERIOR FOUNDATION WALLS UNDER LIVING AREA. CONCRETE PAD FOR CONDENSER THICKNESS IS 4" MIN UNLESS OTHERWISE NOTED.

3. CONCRETE CONSTRUCTION:

- THE SLAB SHALL BE UNDERLAIN BY A VAPOR BARRIER/RETARDER IN THE LIVING AREA (TYPICALLY POLYETHYLENE, UNLESS MORE STRINGENT PROTECTION REQUIRED BY THE ARCHITECT, ENGINEER, FLOOR COVERING MANUFACTURER, OR ACCEPTED PRACTICE). UNLESS OTHERWISE REQUIRED, BARRIER MAY BE OMITTED AT GARAGES, PORCHES AND PATIOS WITHOUT FLOOR COVERINGS. IT IS BEYOND THE SCOPE OF THESE PLANS TO DETERMINE THE APPLICABILITY OF THESE MORE STRINGENT REQUIREMENTS. BUILDER SHALL VERIFY PRIOR TO CONSTRUCTION.

4. REINFORCEMENT:

- IF CONSTRUCTED ON ACTIVE SOILS, THE LONG TERM PERFORMANCE OF THE FOUNDATION IS DEPENDENT ON MAINTENANCE BY THE OWNER. THUS THE BUILDER SHALL ADVISE THE OWNER OF THE FOLLOWING:

I. DRAINAGE MUST BE MAINTAINED. WATER SHALL NEVER BE ALLOWED TO POND NEAR THE FOUNDATION.

2. THE SOIL AROUND THE FOUNDATION SHALL BE MAINTAINED IN A RELATIVELY DAMP CONDITION, SUCH AS THAT REQUIRED TO KEEP A LAWN GREEN. IF IT DRIES OUT IT WILL SHRINK. IF IT GETS WET, IT WILL HEAVE UPWARD.

3. SLABS ON THE SHORTER SIDE USES MAIN BARS ARE USED IN THIS DIRECTION ONLY WITH SMALLER DIAMETER DISTRIBUTION BARS ARE PLACED, FORMING A MAT OR GRID. 4. ALL REINFORCEMENT BARS SIZE 10MM OR LARGER IN ACCORDANCE TO ASTM

ANCHOR BOLTS AT ALL EXTERIOR WALLS SHALL BE MINIMUM 1/2 INCH DIAMETER WITH A MAXIMUM SPACING OF 6'-0" ON CENTER, UNLESS NOTED OTHERWISE.

4. ANCHOR BOLTS SHALL BE INSTALLED WITHIN 12 INCHES OF EACH END OF EACH SILL PLATE WITH AT LEAST TWO ANCHOR BOLTS FOR EACH BOLTS FOR EACH SILL PLATE LONGER THAN 12 INCHES.


5. SIMPSONS SILL ANCHORS MAYBE SUBSTITUTED FOR ANCHOR BOLTS AT THE SAME SPACING.

6. EXTERIOR CONCRETE SLABS WHICH ARE NOT PART OF THE MAIN SLAB SHALL BE MINIMUM 4 INCHES THICK WITH NO STEEL REINFORCING BARS REQUIRED, UNLESS NOTED OTHERWISE ON FOUNDATION PLAN.

VERIFY THE FOLLOWING PRIOR TO POURING:

- . ALL HOLDDOWNS, STRAP, AND POST LOCATIONS.
- 2. CONCRETE FINISHES. PANEL RISER LOCATION WHERE APPLICABLE.
- 3. UNDERSLAB MECHANICAL REQUIREMENTS.
- 4. STEM WALL BLOCKOUTS.
- 5. UNDERSLAB ELECTRICAL REQUIREMENTS AND PANEL RISER LOCATION. WHERE APPLICABLE.
- 6. PROVIDE THE FOLLOWING:
- PVC SLEEVES THROUGH FTG IF REQUIRED - 20' #4 COPPER GROUND BAR.
- . SLOPE FINISH GRADE AWAY FROM FOOTING.

NOTE: FIELD VERIFY ALL DIMENSIONS SEE DIMENSIONED ARCHITECTURAL DRAWINGS

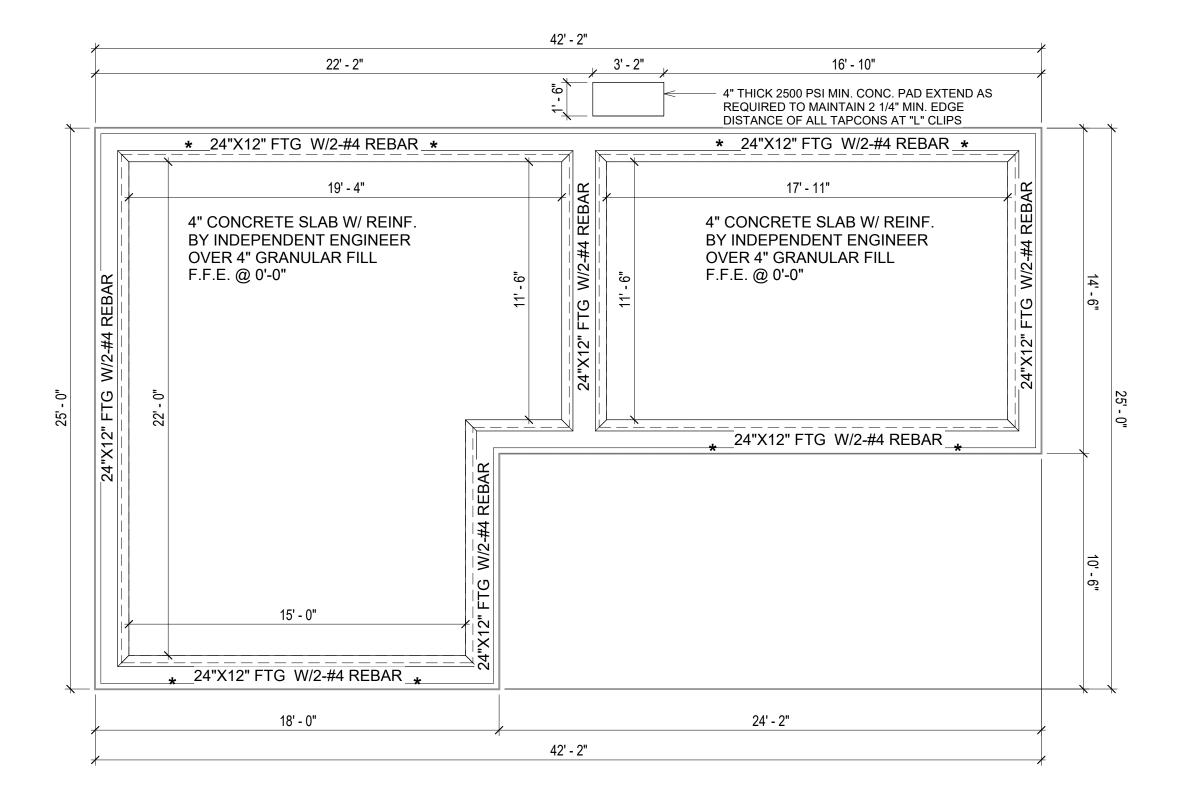





KEY PLAN

NO.	DESCRIPTION	DATE

NOTE:

LEGEND:

PROJECT

LA County-800-1Bd1Ba-550

DRAWING NAME

FOUNDATION PLAN

Client Name	CLIENT NAME:
0061_12	PROJECT NUMBER:
4/10/2025 2:33:20 PN	DATE:
Designer	DESIGNED BY:
Author	DRAWN BY:
Checker	CHECKED BY:

SQUARE FOOTAGE 800 LIVING TOTAL 800 **S101**

SCALE: 1/4" = 1'-0"

GENERAL NOTES

NOTES:

-ALL BEARING WALLS SHOULD HAVE A THICKENED SLAB PER SECTION PER DETAIL A401/5.

A) FOUNDATION PLAN NOTES:

1. CONCRETE SLAB SHALL BE 6" THICK WITH 1/2" DIAMETER TENDONS PER LAYOUT PLAN, CENTERED IN SLAB THICKNESS, OVER APPROVED SUBBASE PER GENERAL STRUCTURE NOTES.

2. TERMITE PROTECTION SHALL BE PROVIDED PER IRC SECTION R318.1
3. NONE TYPICAL ANCHOR BOLT SPACING AT SHEAR WALL AND HOLD DOWN SPECIFICATIONS PER APPROVED ARCHITECTURAL PLANS.

 INSTALL HOLDOWNS BEFORE CONCRETE SLAB POUR.
 EXISTING FILL ON-SITE SHALL BE COMPACTED IN ACCORDANCE WITH THE REQUIREMENTS IN THE GEOTECHNICAL REPORT.

6. ALL FLOOR SLABS ARE REINFORCED ON CONCRETE SLABS.

SPECIAL INSPECTION IS REQUIRED FOR THICKENED FOUNDATION CONSTRUCTION

1. REINFORCEMENT 2. 2300 PSI CONCRETE POUR

B) **REINFORCEMENT FOR CONCRETE**:


ALL REINFORCING SLABS BARS SIZE 10MM OR LARGER SHALL BE DEFORMED IN ACCORDANCE TO ASTM-A706, AND BARS SMALLER THAN 10 MM MAYBE PLAIN.
 UNLESS OTHERWISE NOTED IN PLANS, THE YIELD STRENGTH OF REINFORCING BARS SHALL BE:


A) FOOTING = 40,000 PSI B) NON-LOAD BEARING WALLS AND PARAPETS= 40,000 PSI

- 3. SPLICES SHALL BE SECURELY WIRED TOGETHER AND SHALL LAP OR EXTEND
- 4. GRADE OF STEEL FOR RCC WORKS SHALL BE GRADE 4 10.
- 5. BAR NOTATIONS GIVES INFORMATION
 - A) BAR SIZE
 B) SPACING(IF REQUIRED)
- 6. LAP REINFORCEMENT ONLY AT LOCATION SHOWN IN THE DRAWINGS
- 7. REINFORCEMENT SHALL NOT BE CUT, VENT OR HEATED ON SITE WITHOUT ENGINEERS' APPROVAL.
- C) CONCRETE SLAB NOTES
- 1. ALL SLAB REINFORCEMENT SHALL BE 20MM CLEAR MINIMUM FROM BOTTOM AND FROM TOP OF SLAB.
- 2. REINFORCEMENT IN CONTINUOUS ELEVATED SLAB SHALL BE CUT AS FOLLOWS.

NOTE:

- THIS IS A SCHEMATIC PLAN FOR THE PURPOSE OF LOCATING AND IDENTIFYING FOUNDATION REINFORCING ELEMENTS ONLY. VERIFY ALL DIMENSIONS, DROPS, OFFSETS AND FEATURES WITH THE ARCHITECTURAL PLANS BEFORE FORMING THE FOUNDATION.

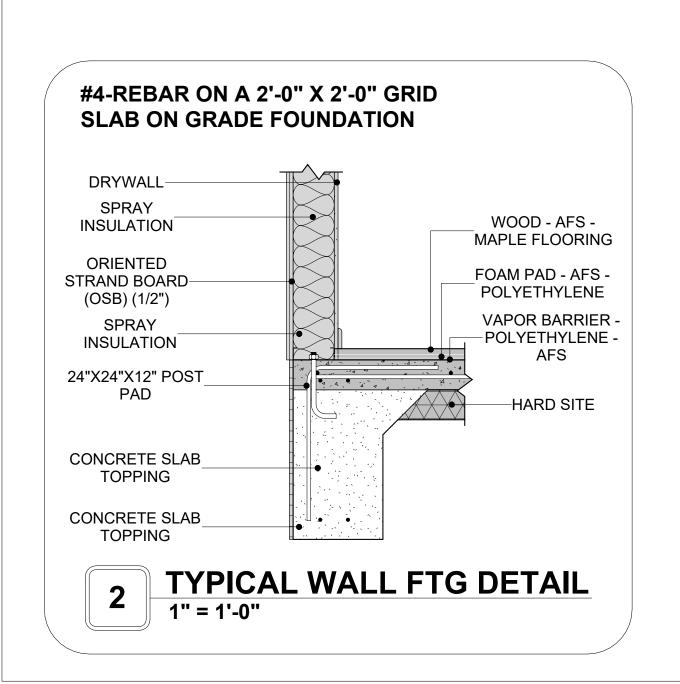

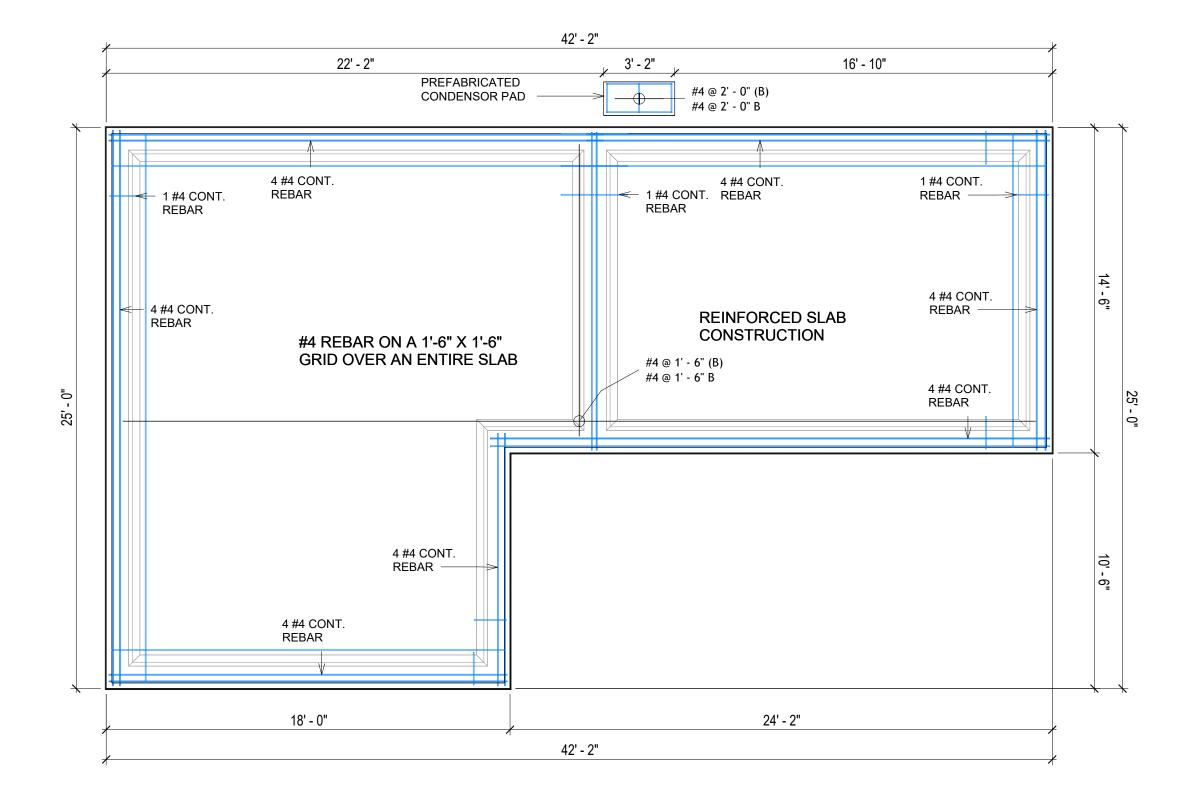

FOUNDATION REBAR PLAN
1/4" = 1'-0"



KEY PLAN

NO.	DESCRIPTION	DATE

NOTE:

LEGEND:

PROJECT

LA County-800-1Bd1Ba-550

DRAWING NAME

STRUCTURAL FLOOR PLAN


CLIENT NAME:	Client Name
PROJECT NUMBER:	0061_12
DATE:	4/10/2025 2:33:21 PM
DESIGNED BY:	Designer
DRAWN BY:	Author
CHECKED BY:	Checker

S102

SCALE: As indicated

ROOF NOTES

- 1. ROOFING COMPOSITION ROOFING PER OWNERS/BUILDERS SPECIFICATIONS INSTALL PER MANUFACTURE SPECIFICATIONS ON 1/2" ORIENTED STRAND BOARD ON PRE-ENGINEERED TRUSS @ 24" O.C. (UNO.)
- 2. 73" OVERHANG AT EAVES (UNO.)
- 3. ENDS OF ALL TRUSSES AND JOISTS TO BE FULLY BLOCKED. PROVIDE SOLID BLOCKING AT ALL RIDGES AND VALLEYS
- 4. SHEATHING TO BE 1/2", 3/8" OSB SHEAR PANEL AND EQUIVALENT. UNDERSIDE OF PORCH TRUSSES TO BE FINISHED WITH MOISTURE RESISTANT DRYWALL, TAPED AND TEXTURED.
- 5. EXPOSED EAVES AND OTHER WEATHER EXPOSED AREAS TO BE SHEATHED WITH EXTERIOR GRADE PLYWOOD.
- 6. ALL MATERIALS THICKNESS AND SIZE ARE THE MINIMUM. Refer TO LOCAL STANDARDS FOR ACTUAL THICKNESS AND LAYERING OF MATERIALS.
- 7. ENGINEERED TRUSS CALCULATIONS TO BE SUBMITTED TO BUILDING
- DEPARTMENT PRIOR TO FABRICATION AND INSTALLATION.
- 8. TRUSS MANUFACTURER TO SPECIFY HANGER CONNECTORS FOR TRUSS COMPONENTS (TYPICAL)
- 9. DESIGNER ASSUMES THAT TRUSSES BEAR ON ALL EXTERIOR PERIMETER WALLS (TYPICAL) OR BEAMS.
- 10. PROVIDE GALVANIZED STEEL FLASHING WITH A LENGTH OF 10 FEET, WIDTH OF 12 INCHES, AND THICKNESS OF 24 GAUGE.

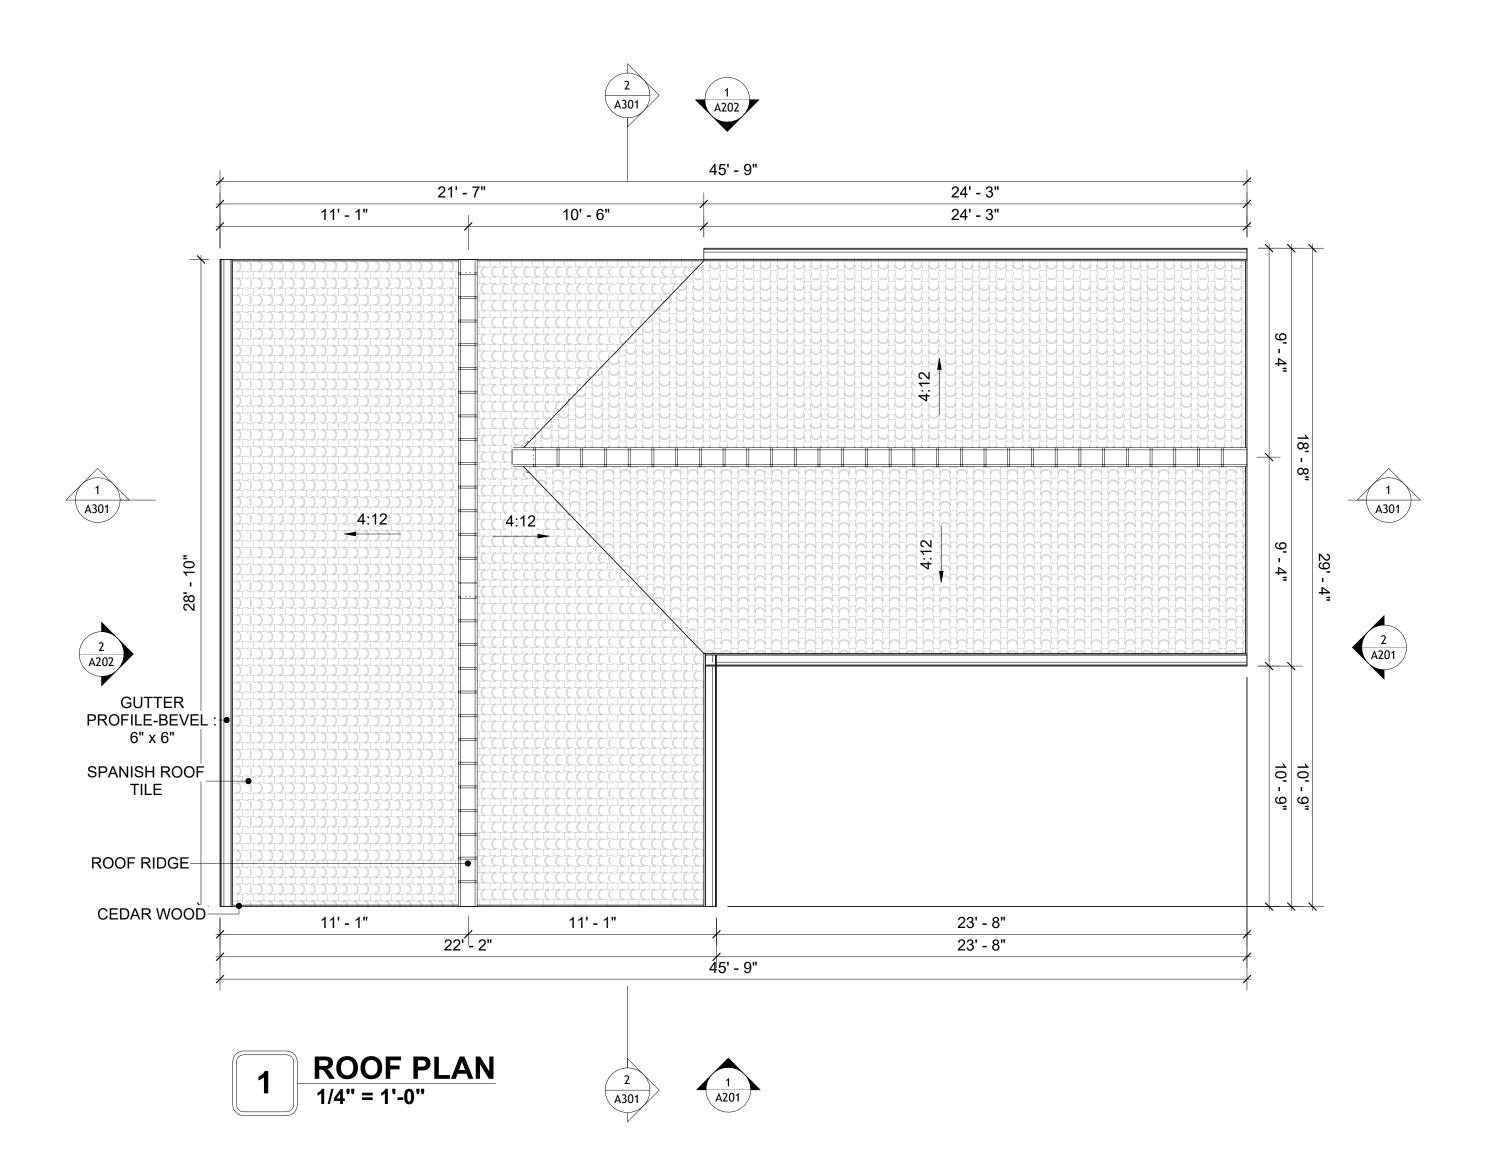



KEY PLAN

NO.	DESCRIPTION	DATE

NOTE:

LEGEND:

PROJE

LA County-800-1Bd1Ba-550

DRAWING NAME

ROOF PLAN

Client Name	CLIENT NAME:
0061_12	PROJECT NUMBER:
4/10/2025 2:33:24 PM	DATE:
Designer	DESIGNED BY:
Author	DRAWN BY:
Checker	CHECKED BY:

 SQUARE FOOTAGE
 A 103

 LIVING
 800

 TOTAL
 800

SCALE: 1/4" = 1'-0"

ABOUT WALL FINISHING

STUCCO FINISH

STUCCO IS A CEMENT-BASED EXTERIOR WALL FINISH THAT OFFERS A DURABLE, WEATHER-RESISTANT, AND CUSTOMIZABLE CLADDING SOLUTION FOR BUILDINGS.

IN THIS SPECIFIC PROJECT, AMERICAN STUCCO SYSTEMS IS USED AS A FINISH MATERIAL BECAUSE IT IS GENERALLY CONSIDERED A WATER-RESISTANT EXTERIOR FINISH AND USES A THREE-COAT APPLICATION PROCESS.

3/8-INCH OF IT IS APPLIED AS AN EXTERNAL WALL FINISH AS IT IS THE MOST COMMON AND WIDELY ACCEPTED STANDARD THICKNESS FOR STUCCO EXTERIOR WALL FINISHES. THIS MULTI-LAYER APPROACH ALSO HELPS CREATE A STRONG, CRACK-RESISTANT STUCCO SURFACE.

THIS STANDARD STUCCO IS APPLIED OVER OSB SHEATHINGS (FOR COLD FORMED STRUCTURE CONSTRUCTION).


IT IS NOT DIRECTLY TROWELED OVER THE OSB BUT OVER A WATER-RESISTANT BARRIER (HOMEWRAP) AND METAL/PLASTIC LATH THAT ARE INSTALLED ON TOP SURFACE OF THE OSB TO PROVIDE AN ADDITIONAL LAYER OF PROTECTION AGAINST MOISTURE INTRUSION.


REGULAR INSPECTION AND PROMPT REPAIR OF ANY CRACKS, CHIPS, OR DAMAGE TO THE STUCCO FINISH IS IMPORTANT. THIS MAINTAINS THE STUCCO'S WATER-RESISTANT PROPERTIES OVER THE BUILDING'S LIFE SPAN.

CEDAR WOOD

CEDAR WOOD REFERS TO THE WOOD FROM VARIOUS SPECIES OF CEDAR TREES, WHICH ARE CONIFEROUS EVERGREEN TREES KNOWN FOR THEIR DISTINCT AROMA AND NATURAL RESISTANCE TO DECAY AND INSECTS.

IN THIS SPECIFIC PROJECT, CEDAR WOOD IS USED A FINISH MATERIAL ON BEAMS AND COLUMNS.

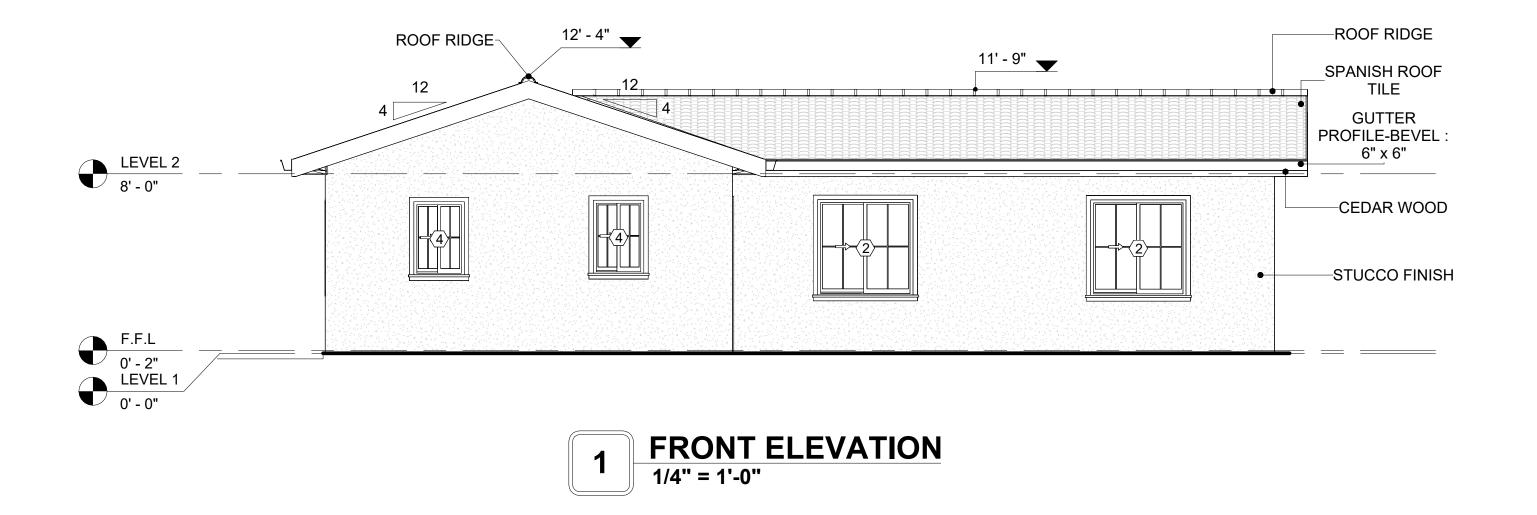


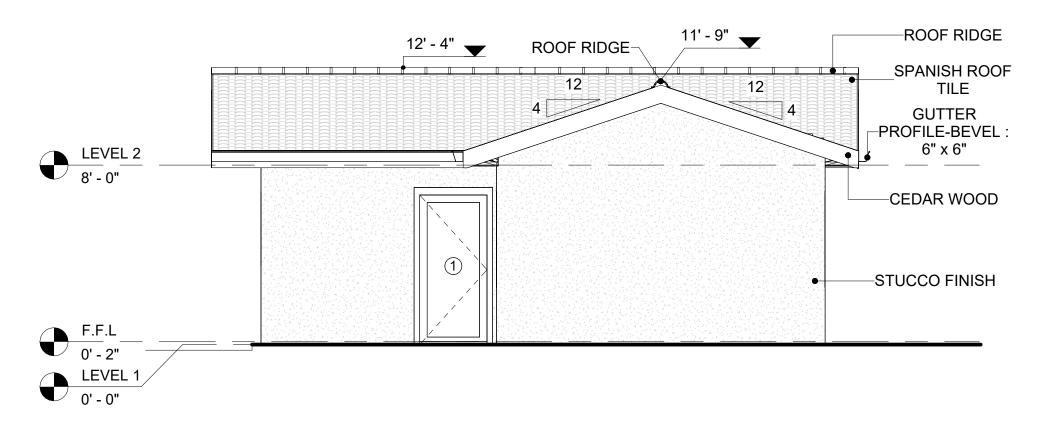

RIGHT SIDE ELEVATION
1/4" = 1'-0"

	DOOR SCHEDULE					
TYPE				SIZE		
MAR K	SUPPLIER	DOOR TYPE	LOCATIO	WIDTH	HEIGHT	COUNT
1	HOME DEPOT	EXTERIOR SINGLE PANEL SWINGING	INTERIOR	3' - 0"	6' - 8"	1
2	HOME DEPOT	EXTERIOR SINGLE PANEL SWINGING	INTERIOR	2' - 8"	6' - 8"	2
3	HOME DEPOT	INTERIOR DOUBLE PANEL SLIDING	INTERIOR	5' - 4"	6' - 8"	1
4	HOME DEPOT	DOOR-BIFOLD_9052	INTERIOR	2' - 6"	6' - 8"	1

WINDOW SCHEDULE					
			SIZE		
TYPE MARK	SUPPLIER	WINDOW TYPE	WIDTH	HEIGHT	COUNT
1	HOME DEPOT	SLIDING	3' - 3"	2' - 3"	2
2	HOME DEPOT	SLIDING	4' - 3"	4' - 3"	5
3	HOME DEPOT	SLIDING	6' - 3"	4' - 3"	1
4	HOME DEPOT	SLIDING	2' - 3"	3' - 3"	2

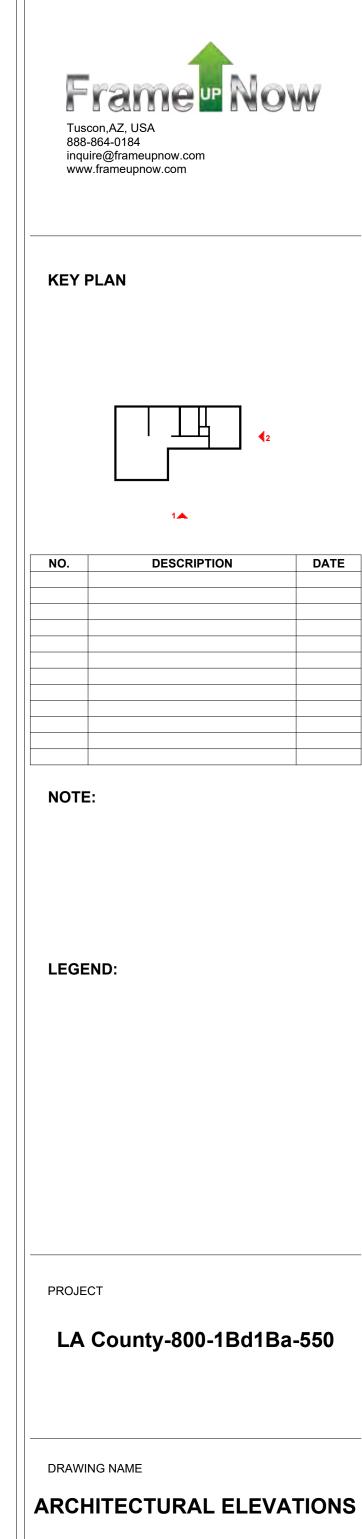

Client Name	CLIENT NAME:
0061_12	PROJECT NUMBER:
4/10/2025 2:33:27 PM	DATE:
Designer	DESIGNED BY:
Author	DRAWN BY:
Checker	CHECKED BY:

A201 SCALE: As indicated

ABOUT WALL FINISHING

STUCCO FINISH

STUCCO IS A CEMENT-BASED EXTERIOR WALL FINISH THAT OFFERS A DURABLE, WEATHER-RESISTANT, AND CUSTOMIZABLE CLADDING SOLUTION FOR BUILDINGS.

IN THIS SPECIFIC PROJECT, AMERICAN STUCCO SYSTEMS IS USED AS A FINISH MATERIAL BECAUSE IT IS GENERALLY CONSIDERED A WATER-RESISTANT EXTERIOR FINISH AND USES A THREE-COAT APPLICATION PROCESS.

3/8-INCH OF IT IS APPLIED AS AN EXTERNAL WALL FINISH AS IT IS THE MOST COMMON AND WIDELY ACCEPTED STANDARD THICKNESS FOR STUCCO EXTERIOR WALL FINISHES. THIS MULTILAYER APPROACH ALSO HELPS CREATE A STRONG, CRACK-RESISTANT STUCCO SURFACE.

THIS STANDARD STUCCO IS APPLIED OVER OSB SHEATHINGS (FOR COLD FORMED STRUCTURE CONSTRUCTION).


IT IS NOT DIRECTLY TROWELED OVER THE OSB BUT OVER A WATER-RESISTANT BARRIER (HOMEWRAP) AND METAL/PLASTIC LATH THAT ARE INSTALLED ON TOP SURFACE OF THE OSB TO PROVIDE AN ADDITIONAL LAYER OF PROTECTION AGAINST MOISTURE INTRUSION.

REGULAR INSPECTION AND PROMPT REPAIR OF ANY CRACKS, CHIPS, OR DAMAGE TO THE STUCCO FINISH IS IMPORTANT. THIS MAINTAINS THE STUCCO'S WATER-RESISTANT PROPERTIES OVER THE BUILDING'S LIFE SPAN.


CEDAR WOOD

CEDAR WOOD REFERS TO THE WOOD FROM VARIOUS SPECIES OF CEDAR TREES, WHICH ARE CONIFEROUS EVERGREEN TREES KNOWN FOR THEIR DISTINCT AROMA AND NATURAL RESISTANCE TO DECAY AND INSECTS.


IN THIS SPECIFIC PROJECT, CEDAR WOOD IS USED A FINISH MATERIAL ON BEAMS AND COLUMNS.

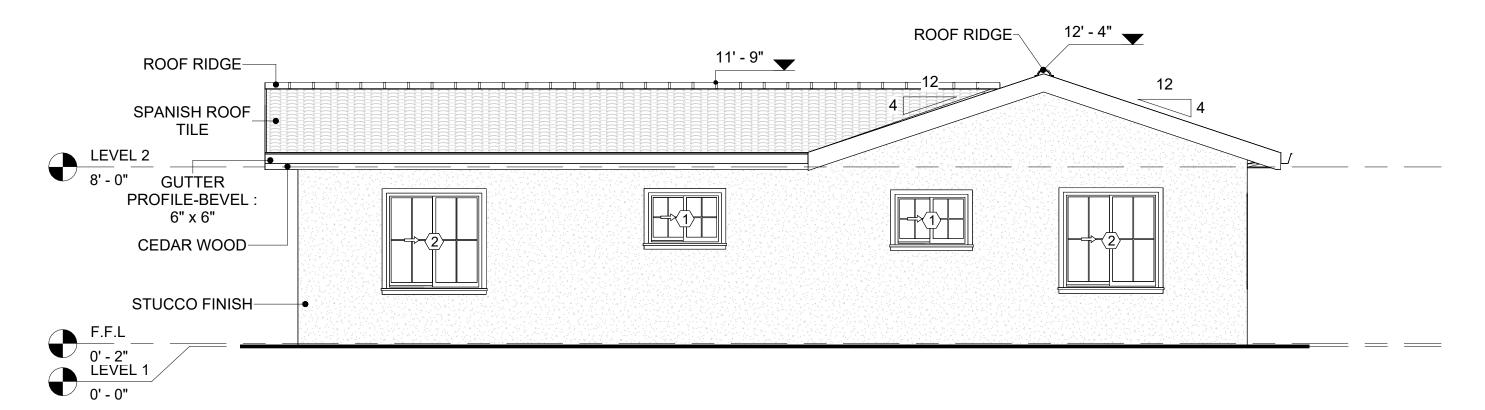

1 REAR ELEVATION
1/4" = 1'-0"

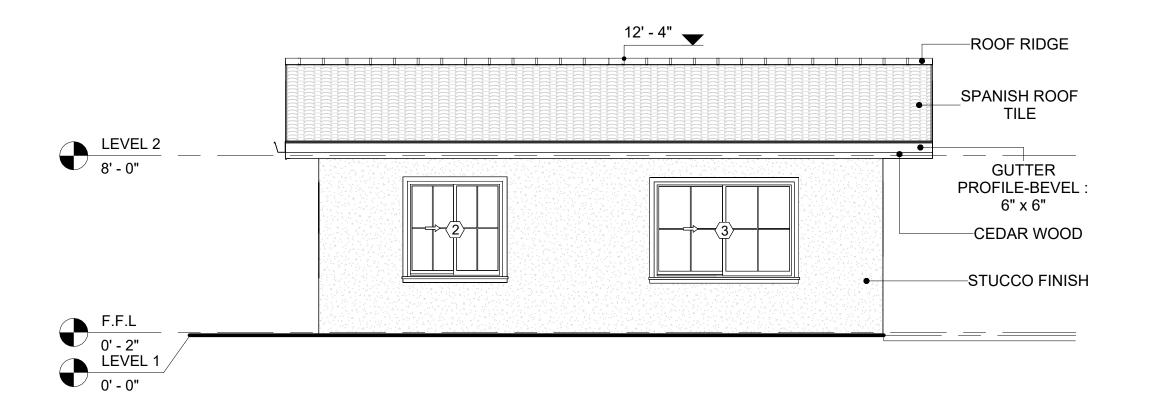

2 LEFT SIDE ELEVATION
1/4" = 1'-0"

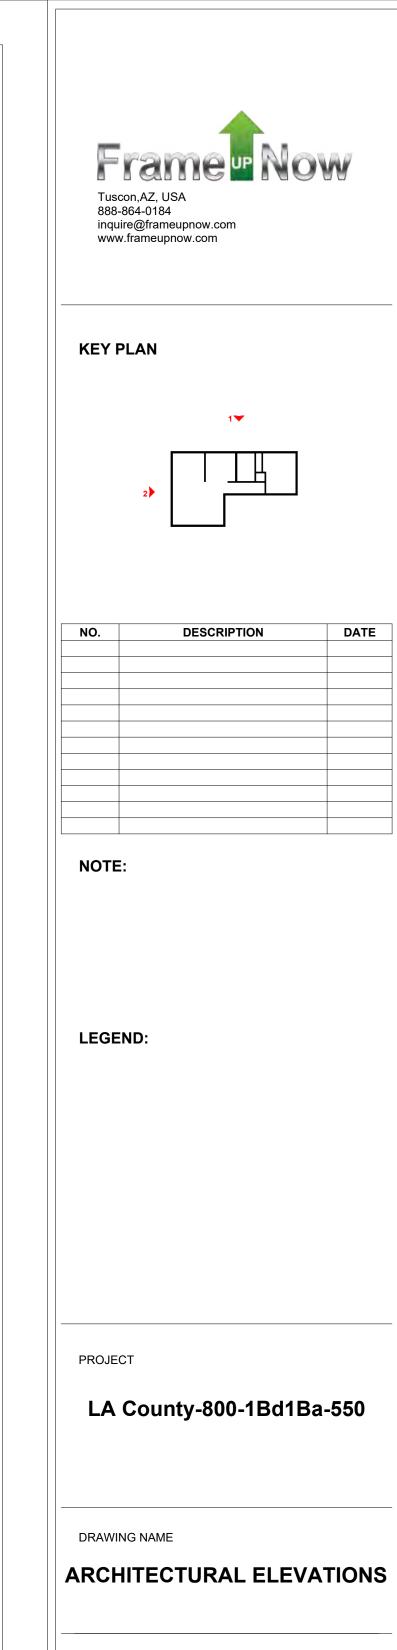


Client Name
0061_12
4/10/2025 2:33:30 PM
Designer
Author


Checker

CHECKED BY:

A202

SCALE: As indicated

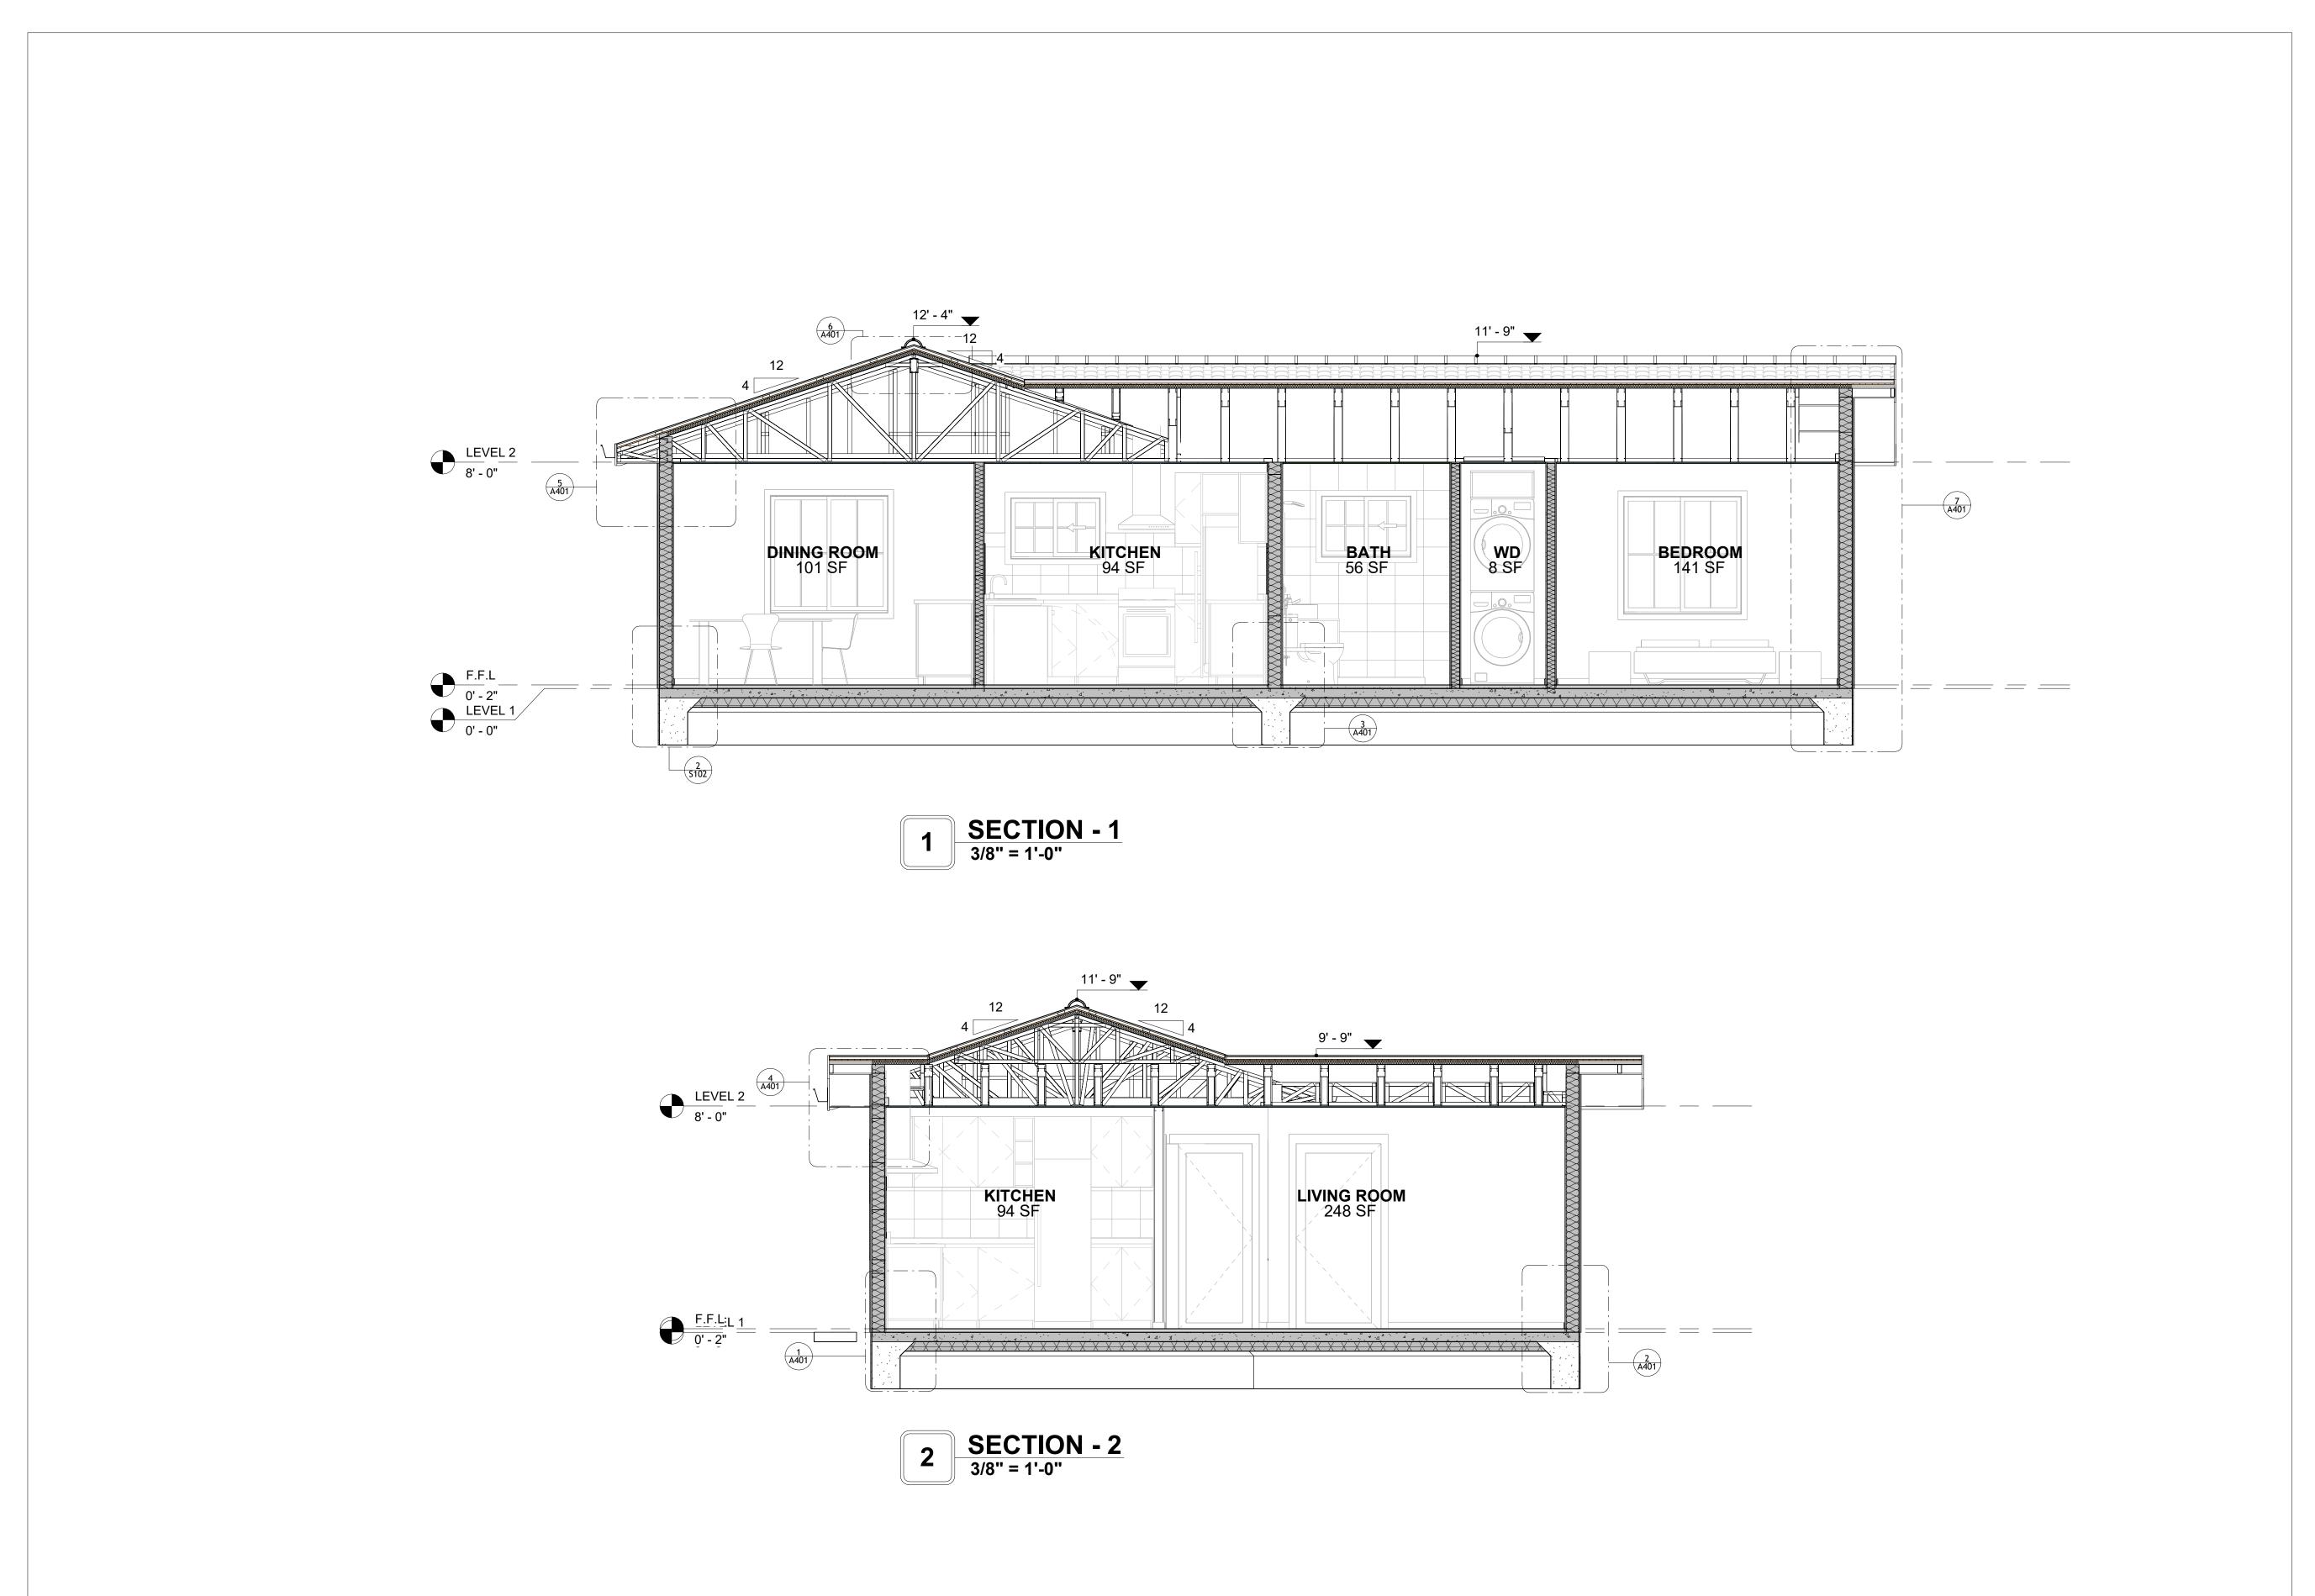

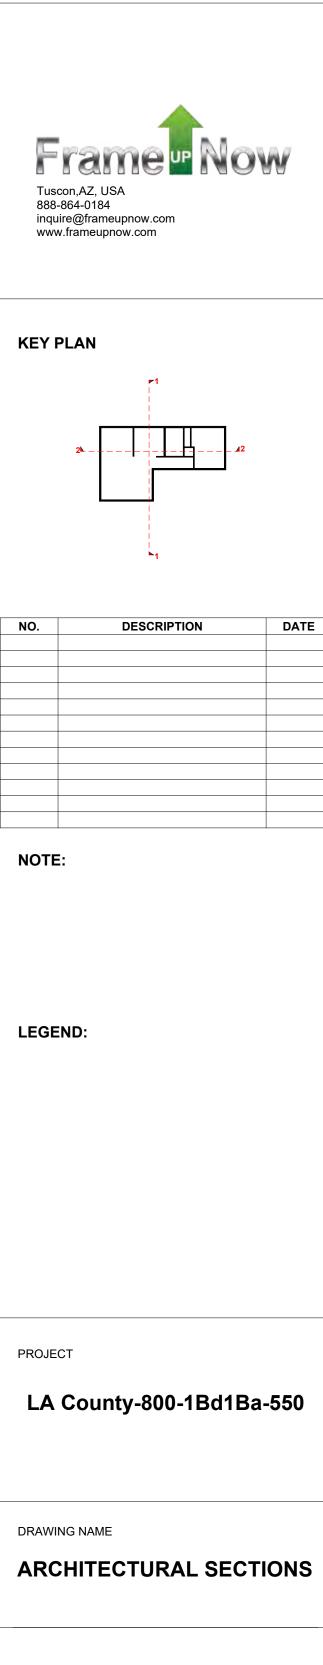


DATE


Client Name CLIENT NAME: PROJECT NUMBER: 0061_12 4/10/2025 2:33:32 PM

Designer DESIGNED BY: DRAWN BY: Author Checker CHECKED BY:

A301

SCALE: As indicated

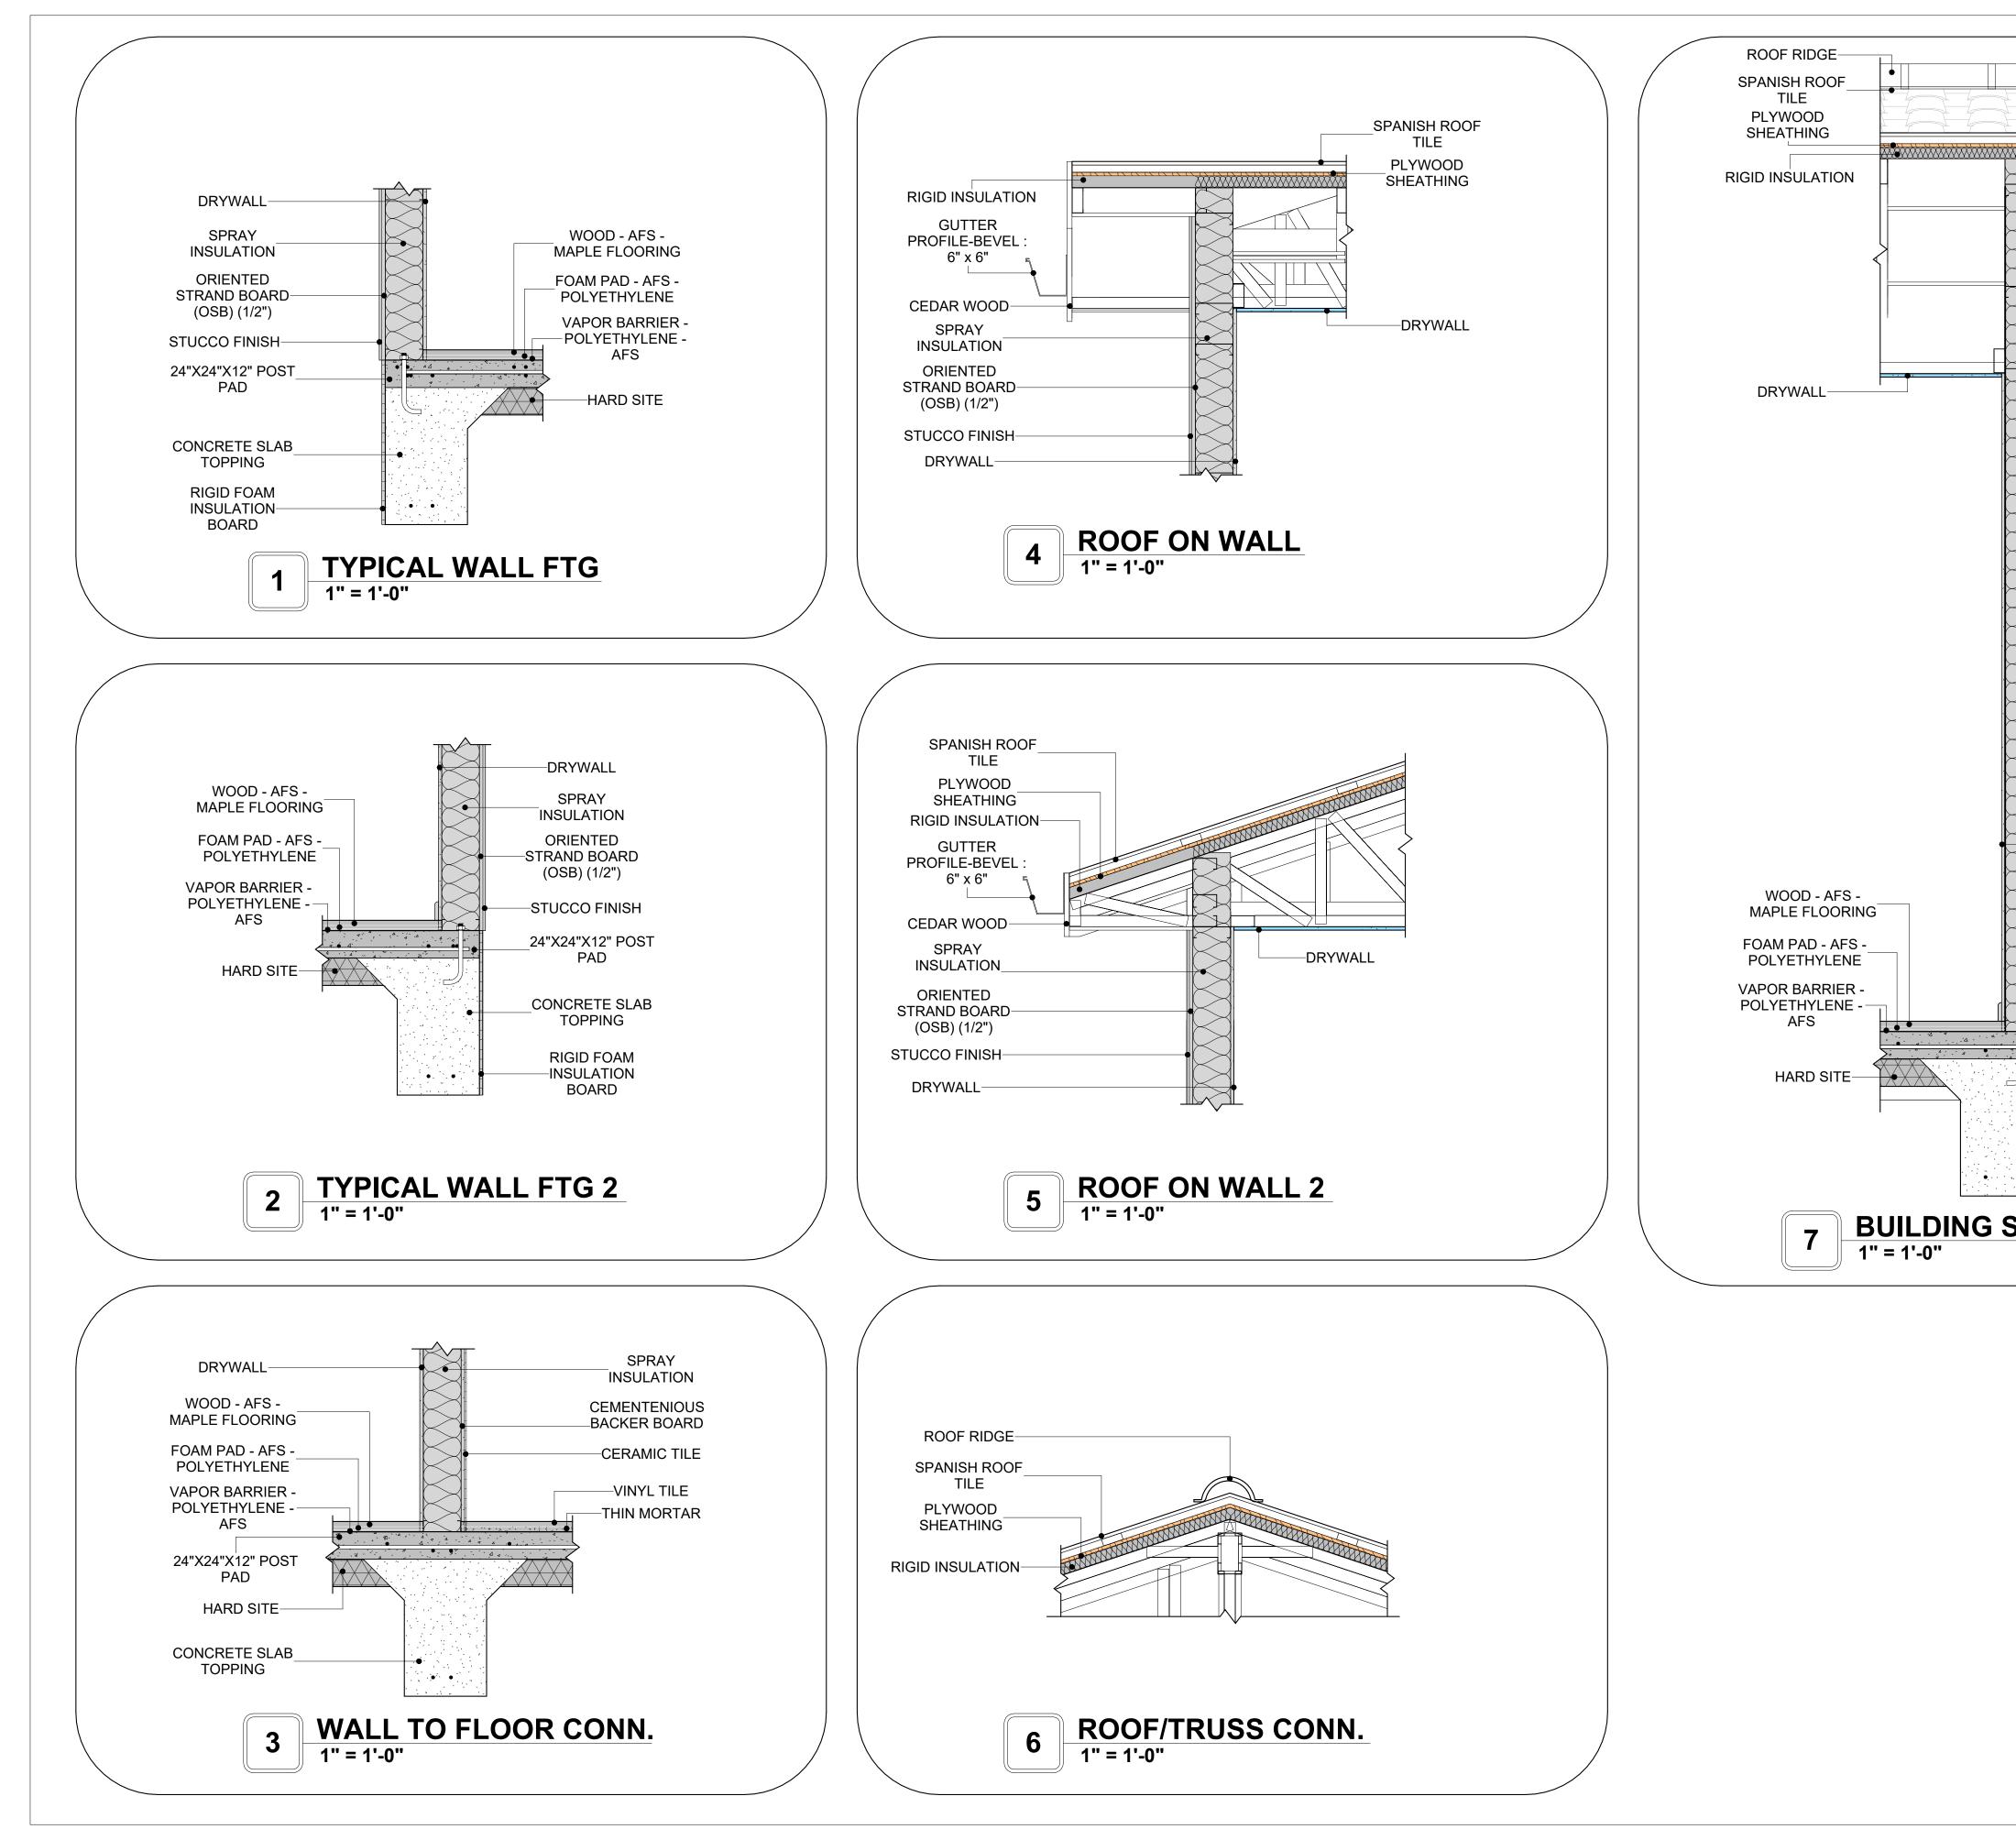

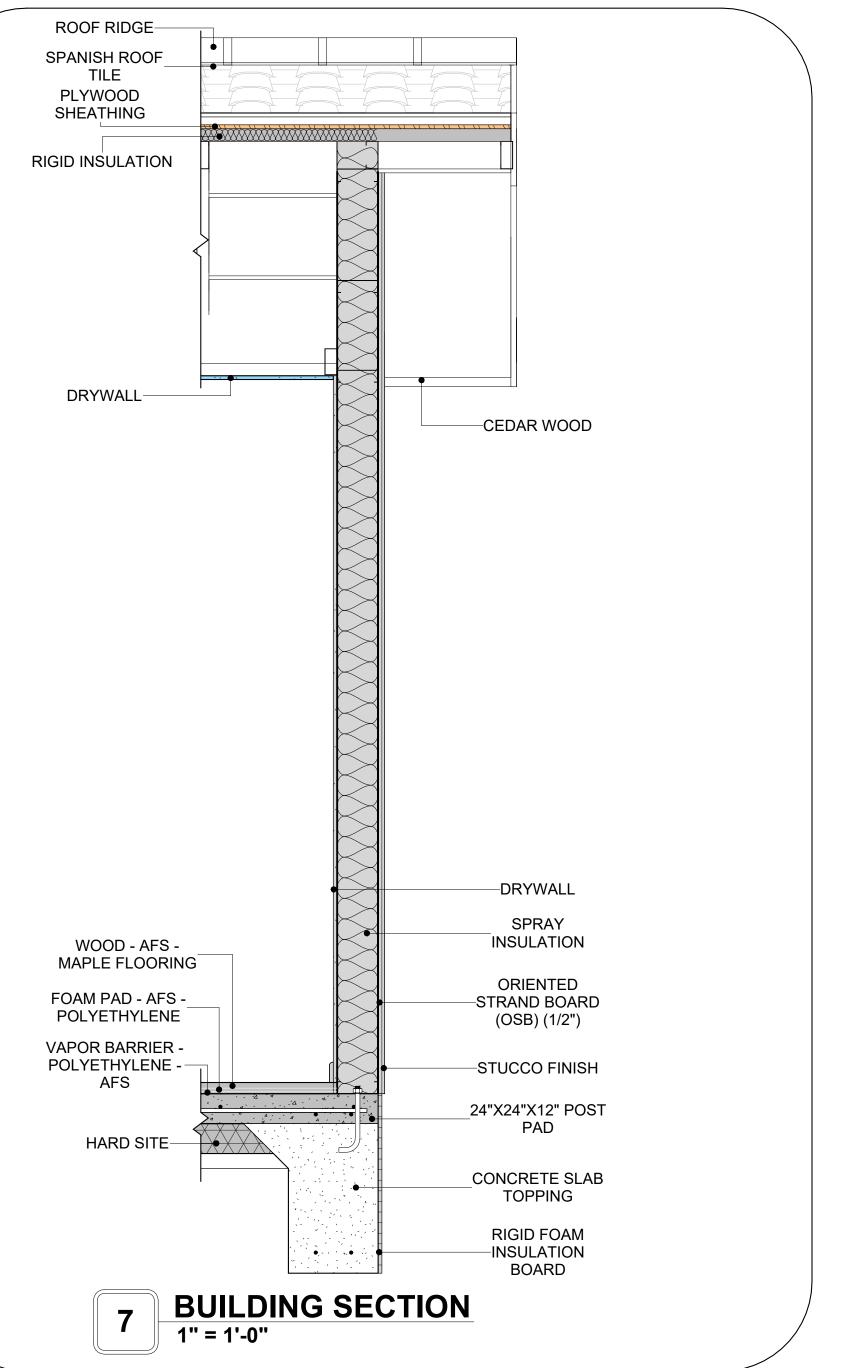



KEY PLAN

NO.	DESCRIPTION	DATE
NOTE:		

LEGEND:

PROJECT

LA County-800-1Bd1Ba-550

DRAWING NAME

ARCHITECTURAL DETAILS

Client Name	CLIENT NAME:
0061_12	PROJECT NUMBER:
4/10/2025 2:33:33 PM	DATE:
Designer	DESIGNED BY:
Author	DRAWN BY:
Checker	CHECKED BY:

A401

SCALE: 1" = 1'-0"


CASEWORK GENERAL NOTES


- 1. ALL CABINET HEIGHTS INCLUDE COUNTERTOPS. DIMENSIONS ARE TO THE NEAREST INCH.
 2. DIVISIONS IN CASEWORK ARE SHOWN FOR CLARITY AND DO NOT REPRESENT BREAKS IN THE
- COUNTERTOP.
- 3. PROVIDE CONTINUOUS COUNTERTOP OVER ALL SIMILAR HEIGHT CASEWORK, UNLESS AND OTHERWISE NOTED.
- 4. MANUFACTURER AND CATALOG NUMBERS ARE FOR REFERENCE AND ILLUSTRATION PURPOSES
- DOTTED LINES INDICATE WALL HUNG CABINETS, DIVISIONS OF BASE CABINETS BELOW THE
 COUNTERTOP, FURNITURE NOT IN THE CONTRACT OR PROJECTION SCREENS -SEE CASEWORK KEY AND SPECIFICATIONS.
- ALL CABINETS AND DRAWERS TO HAVE CAM LOCKS EXCEPT FOR SINK BASE CABINETS.
 ALL EXPOSED SURFACES (EXPOSED TO VIEW FROM ANY PERSPECTIVE) TO BE COVERED WITH
- LAMINATE.


 9. ALL CASEWORK WHICH MEETS A WALL AT ONE OR BOTH ENDS, TO BE PROVIDED WITH FILLER
- PANELS AND SCRIBED TO THE WALL(S) AS REQUIRED.
- 10. ALL CABINETS AND DRAWERS ARE PROVIDED WITH RECESSED HANDLES.
- 11. CONTRACTOR TO FIELD VERIFY ALL CLEAR OPENINGS PRIOR TO MILLWORK OR CASEWORK
- 12. CASEWORK DRAWINGS ARE DIAGRAMMATIC IN NATURE TO SHOW DESIGN INTENT.


	CASEWORK SCHEDULE					
TYPE MAR K	TYPE	COUN T	HEIGHT	WIDTH	DEPTH	AREA
01	WALL CABINET DOUBLE DOOR 3	1	2' - 6"	2' - 2"	1' - 0"	5 SF
02	LINEAR COUNTER TOP	1	0' - 4"	2' - 2"	2' - 1"	1 SF
03	BASE CABINET DOUBLE DOOR 4	1	2' - 11"	2' - 2"	2' - 0"	6 SF
04	LAUNDRY OPEN CABINET	1	1' - 6"	2' - 0"	2' - 4"	3 SF
05	HD WALL FILLER 18	1	2' - 6"	0' - 9"	1' - 0"	2 SF
06	WALL CABINET DOUBLE DOOR 2	1	2' - 6"	2' - 6"	1' - 0"	6 SF
07	WALL CABINET L-SHAPE	1	2' - 6"	2' - 0"	2' - 0"	5 SF
08	WALL CABINET SINGLE DOOR	1	2' - 6"	1' - 3"	1' - 0"	3 SF
10	BASE CABINET L-SHAPED 3	1	2' - 11"	3' - 3"	3' - 3"	9 SF
11	HD_L-SHAPE_COUNTER_TOP11 2	1	0' - 4"	9' - 7"	4' - 0"	3 SF
12	BASE_CABINET_SINGLE_DOOR 2	1	2' - 7"	2' - 0"	2' - 0"	5 SF
13	HD_L-SHAPE_COUNTER_TOP W SINK HOLE 2	1	0' - 4"	4' - 6"	8' - 1"	1 SF
14	BASE_CABINET_SINGLE_DOOR	1	2' - 7"	1' - 6"	2' - 0"	4 SF
15	BASE CABINET L-SHAPED	1	2' - 11"	3' - 3"	3' - 3"	9 SF
16	BASE_CABINET_DOUBLE_DOOR 5	1	2' - 11"	3' - 6"	2' - 0"	10 SF
17	BASE_FILLER_1	1	2' - 11"	0' - 9"	2' - 0"	2 SF
18	BASE_CABINET_DOUBLE_DOOR	1	2' - 11"	6' - 0"	2' - 0"	17 SF
19	BASE_CABINET_DOUBLE_DOOR 2	1	2' - 11"	3' - 6"	2' - 0"	10 SF
20	ISLAND_COUNTERTOP	1	0' - 2"	9' - 6"	2' - 1"	1 SF
21	RECESSED_MED_CABINET 2	1	2' - 0"	1' - 6"	0' - 3"	3 SF
22	VANITY_CABINET_2	1	2' - 4"	3' - 1"	2' - 0"	7 SF
23	CLOSET 5	1	6' - 0"	6' - 3"	1' - 4"	38 SF
24	LAUNDRY OPEN CABINET 2	1	1' - 0"	2' - 3"	2' - 7"	2 SF
GRAND	TOTAL	23				

SPECIALTY EQUIPMENT SCHEDULE						
TYPE MARK	TYPE MARK TYPE COUNT					
	I	I .				
01	WASHER-FRONT-LOAD	1				
02	REFRIGERATOR	1				
03	RANGE	1				
04	DRYER-FRONT-LOAD	1				
05	DISHWASHER	1				
GRAND TOTAL: 5		,				

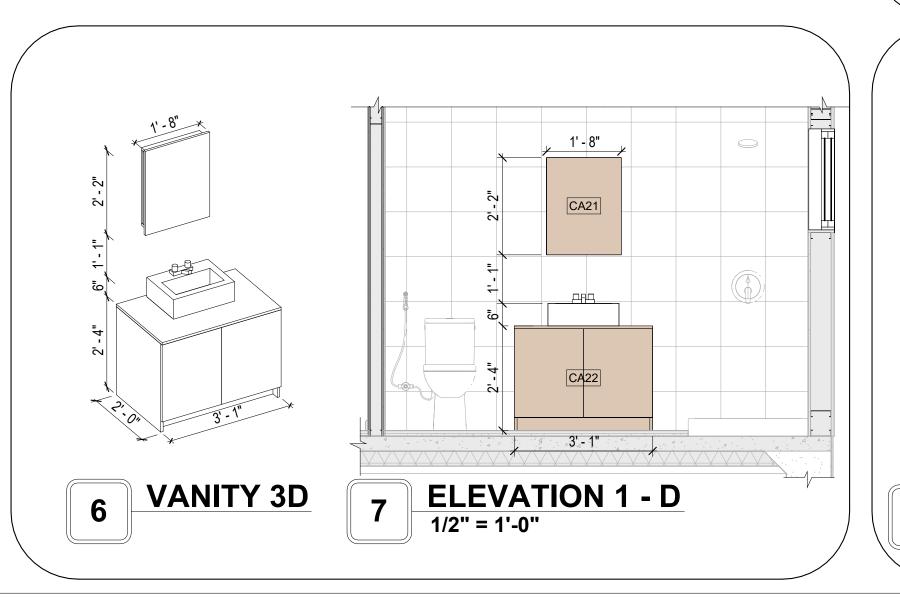


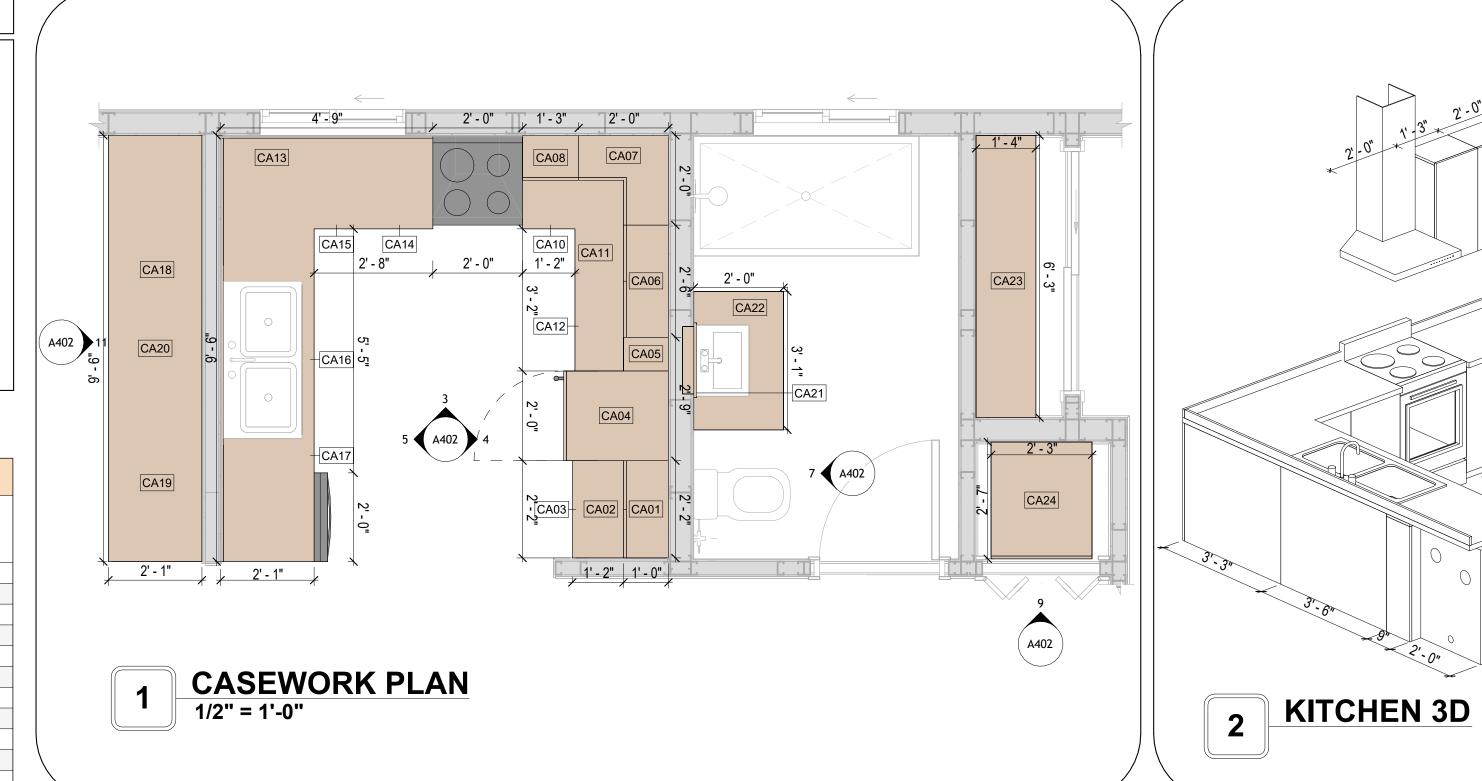


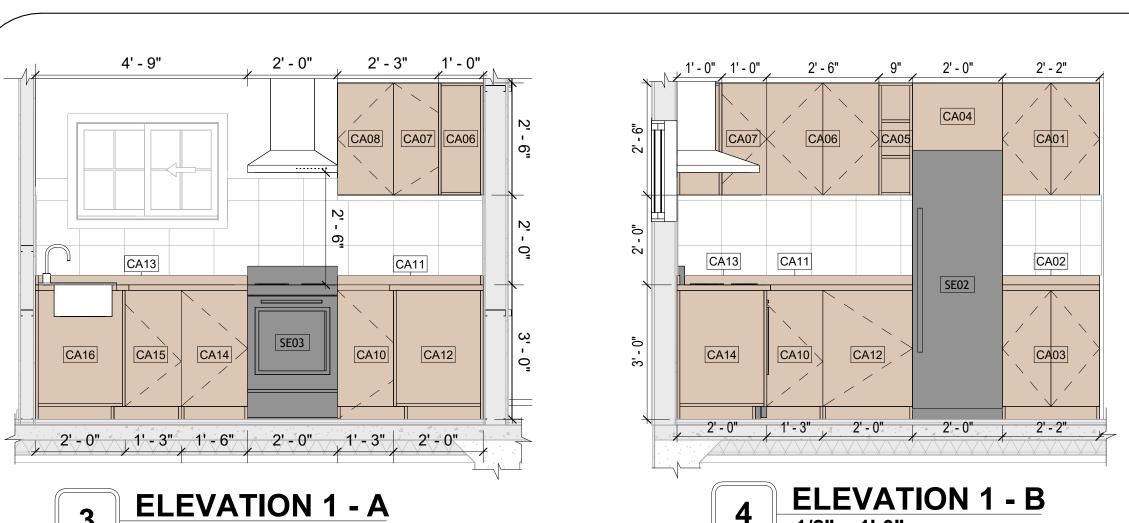

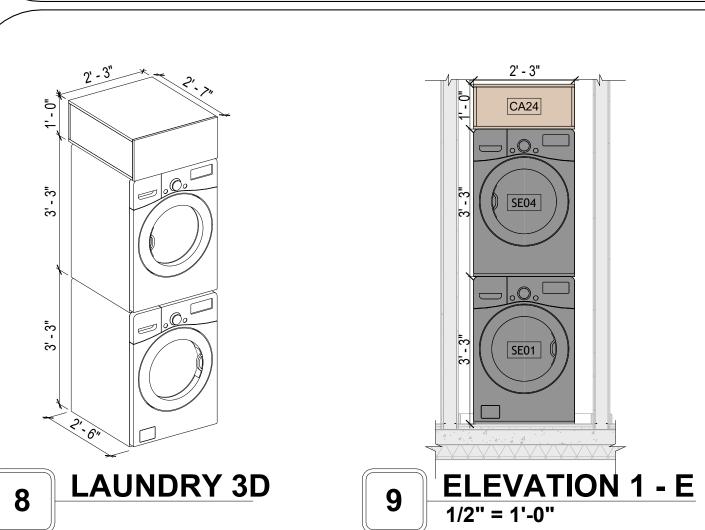

1/2" = 1'-0"

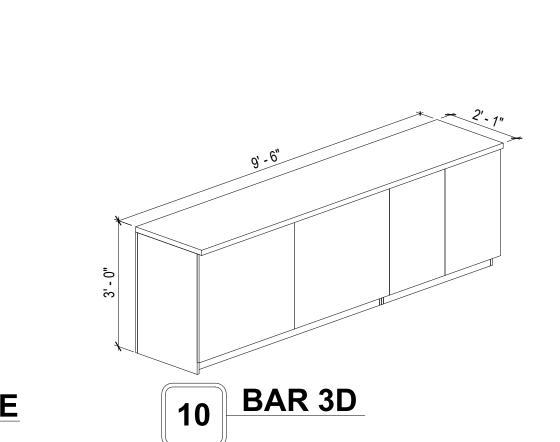

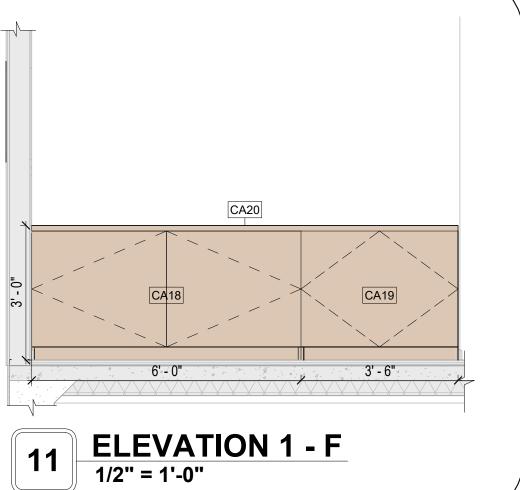


CA15

2'-0" 2'-0"

ELEVATION 1 - C

Tuscon,AZ, USA
888-864-0184
inquire@frameupnow.com
www.frameupnow.com



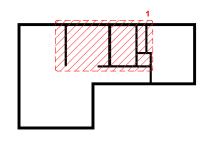

NO.	DESCRIPTION	DATE

NOTE:

LEGEND:

PROJECT

LA County-800-1Bd1Ba-550

DRAWING NAME

ARCHITECTURAL CASEWORK

CLIENT NAME:	Client Name
PROJECT NUMBER:	0061_12
DATE:	4/10/2025 2:33:37 PM
DESIGNED BY:	Designer
DRAWN BY:	Author
CHECKED BY:	Checker

A402

SCALE: As indicated

GENERAL NOTES

1. THIS DRAWING DEPICTS THE HVAC (HEATING, VENTILATION, AND AIR CONDITIONING) SYSTEM FOR THE LA COUNTY 1BD1BA_NG. IT PROVIDES A VISUAL REPRESENTATION OF THE SYSTEM LAYOUT AND COMPONENTS.

2.THE HVAC SYSTEM IS DESIGNED TO MEET THE SPECIFIC REQUIREMENTS OF THE BUILDING, INCLUDING HEATING, COOLING, AND VENTILATION NEEDS, AS PER THE PROJECT SPECIFICATIONS AND APPLICABLE CODES AND STANDARDS.

3. THE HVAC SYSTEM INSTALLATION SHALL COMPLY WITH THE LATEST EDITION OF THE INTERNATIONAL MECHANICAL CODE (IMC), INTERNATIONAL RESIDENTIAL CODE (IRC), AND ALL OTHER APPLICABLE LOCAL, STATE, AND NATIONAL CODES AND REGULATIONS.

4. THE EQUIPMENT SHOWN ON THIS DRAWING INCLUDES BUT IS NOT LIMITED TO AIR HANDLING UNITS (AHUS), CHILLERS, BOILERS, COOLING TOWERS, PUMPS, DUCTWORK, DIFFUSERS, GRILLES, AND CONTROL DEVICES.

5. ALL EQUIPMENT, DUCTWORK, AND PIPING SHALL BE INSTALLED IN ACCORDANCE WITH MANUFACTURER'S SPECIFICATIONS, LOCAL CODES, AND INDUSTRY BEST PRACTICES.

6. ALL DUCTWORK SHALL BE SIZED, FABRICATED, AND INSTALLED IN ACCORDANCE WITH THE LATEST EDITION OF THE ACCA MANUAL D AND THE SMACNA HVAC DUCT CONSTRUCTION STANDARDS. DUCTWORK SHALL BE INSTALLED IN A NEAT AND WORKMANLIKE MANNER, PROPERLY SUPPORTED AND BRACED TO PREVENT SAGGING, AIR LEAKAGE, OR VIBRATION.

7. CONDENSATE DRAINAGE PIPING SHALL BE PROPERLY PITCHED TO ENSURE POSITIVE DRAINAGE TO AN APPROVED DISPOSAL LOCATION, SUCH AS A FLOOR DRAIN, SUMP PUMP, OR EXTERIOR GRADE. CONDENSATE LINES SHALL BE INSULATED TO PREVENT SWEATING.

8. THE LOCATION OF CONTROL PANELS AND SENSORS INDICATED ON THIS DRAWING CAN BEMODIFY WITH THE SPECIFIC LOCATIONS AND WIRING DETAILS WILL BE DETERMINED DURING THE CONTROL SYSTEM DESIGN AND INSTALLATION.

9. THE HVAC SYSTEM DESIGN CONSIDER ENERGY EFFICIENCY, INDOOR AIR QUALITY, OCCUPANT COMFORT, AND NOISE CONTROL, FOLLOWING APPLICABLE GUIDELINES AND REGULATIONS.

10. COORDINATION WITH OTHER TREADS HAS BEEN DONE ON A DESIGN LEVEL. THIS DRAWING SHALL BE READ TOGETHER WITH THE AR, EL AND SN DESIGN DRAWINGS TO ENSURE PROPER INSTALLATION AND INTEGRATION OF THE HVAC SYSTEMS.

11. THE HVAC CONTRACTOR IS RESPONSIBLE FOR OBTAINING ALL NECESSARY PERMITS AND LICENSES, AND FOR SCHEDULING AND COORDINATING WITH THE LOCAL BUILDING DEPARTMENT AND UTILITY PROVIDERS TO ENSURE A TIMELY AND COMPLIANT INSTALLATION.

12. ALL DUCTWORK PENETRATIONS THROUGH WALLS, FLOORS, OR CEILINGS SHALL BE PROPERLY SEALED AND FIRE-STOPPED USING APPROVED METHODS AND MATERIALS TO MAINTAIN THE INTEGRITY OF THE BUILDING'S FIRE-RESISTANCE RATINGS.

13. HVAC EQUIPMENT SHALL BE INSTALLED LEVEL AND PLUMB, AND IN STRICT ACCORDANCE WITH THE MANUFACTURER'S INSTALLATION INSTRUCTIONS AND RECOMMENDATIONS. PROVIDE ADEQUATE CLEARANCES AROUND EQUIPMENT FOR PROPER AIRFLOW, SERVICE ACCESS, AND

CODE COMPLIANCE.

14. ALL HVAC EQUIPMENT AND COMPONENTS, INCLUDING THERMOSTATS, DAMPERS, AND ACCESS PANELS, SHALL BE LOCATED IN ACCESSIBLE AREAS


15. THE HVAC SYSTEM SHALL BE BALANCED AND ADJUSTED TO ENSURE PROPER AIRFLOW, TEMPERATURE DISTRIBUTION, AND SYSTEM PERFORMANCE THROUGHOUT THE RESIDENCE. PROVIDE A WRITTEN REPORT DOCUMENTING THE FINAL SYSTEM BALANCE.

16. ANY DEVIATIONS OR MODIFICATIONS TO THE HVAC SYSTEM DESIGN SHALL BE REVIEWED AND APPROVED BY THE RESPONSIBLE DESIGN PROFESSIONALS AND COMMUNICATED TO ALL RELEVANT PARTIES INVOLVED IN THE CONSTRUCTION PROCESS.

FOR EASY SERVICING AND MAINTENANCE. PROVIDE ADEQUATE SPACE AROUND EQUIPMENT FOR PROPER AIRFLOW AND SERVICE ACCESS.


17. FOR ANY INQUIRIES OR CLARIFICATIONS REGARDING THE HVAC SYSTEM DESIGN, PLEASE CONSULT THE RESPONSIBLE DESIGN PROFESSIONALS OR THE PROJECT MANAGEMENT TEAM.

SYMBOLS

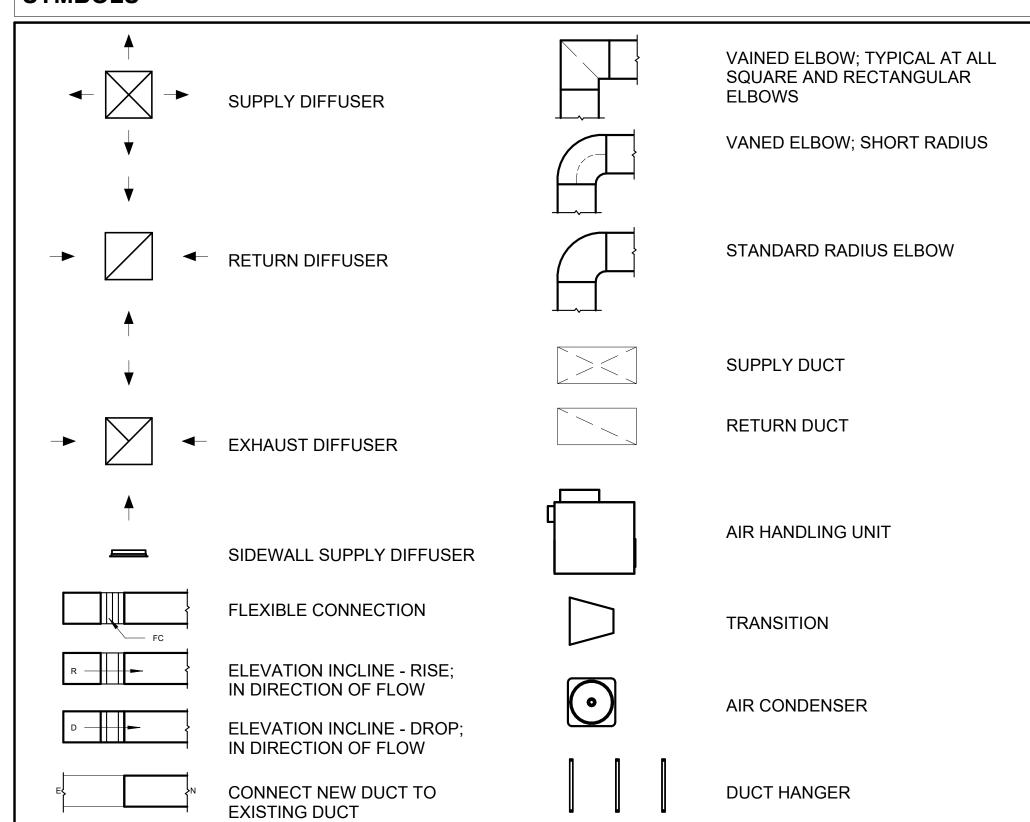



AIR CONDITIONING PIPE LINE

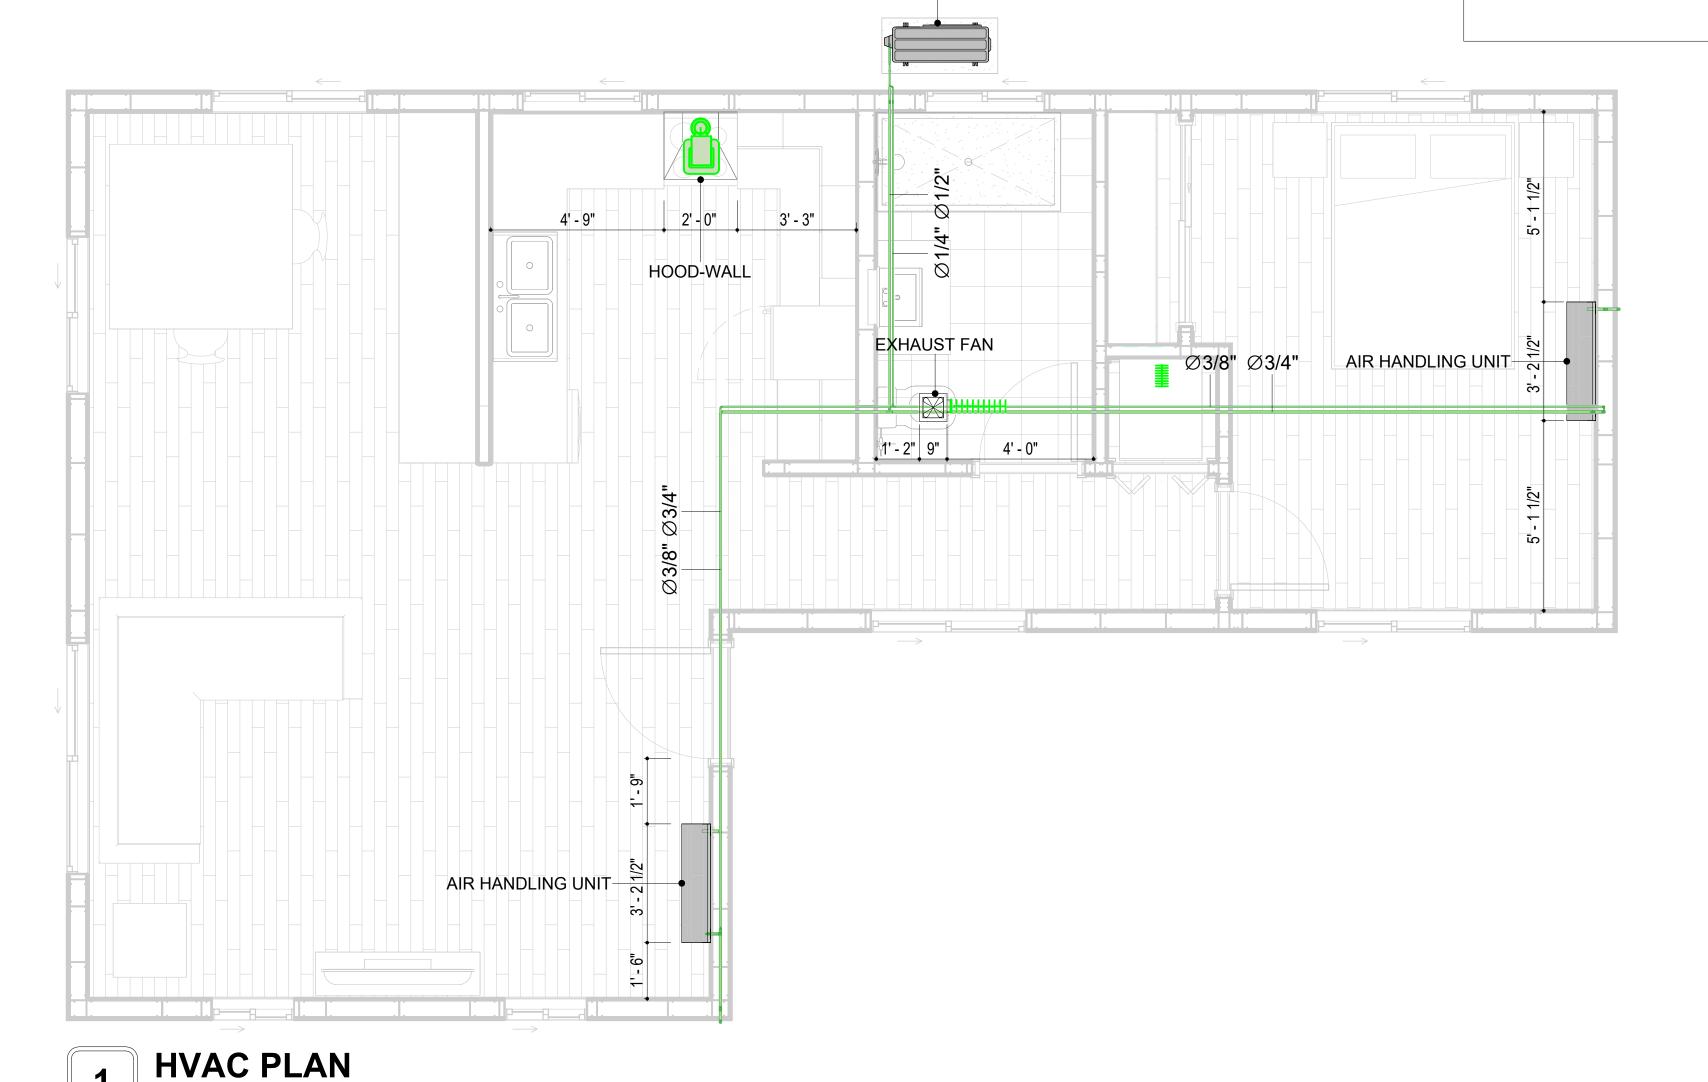

CONDENSER

REFRIGERANT LINE SCHEDULE					
CATAGORY	DESCRIPTION	DIAMETER	LENGTH		
PIPE TYPES	COPPER	1/4"	17.07		
PIPE TYPES	COPPER	3/8"	42.45		
PIPE TYPES	COPPER	1/2"	17.22		
PIPE TYPES	COPPER	3/4"	59.79		

3/8" = 1'-0"

REFRIGERANT LINE FITTING SCHEDULE					
CATAGORY	DESCRIPTION	Size	Count		
ELBOW - GENERIC	ELBOW - GENERIC: STANDARD/HVAC	1/2"ø-1/2"ø	3		
ELBOW - GENERIC	ELBOW - GENERIC: STANDARD/HVAC	1/4"ø-1/4"ø	5		
ELBOW - GENERIC	ELBOW - GENERIC: STANDARD/HVAC	3/4"ø-3/4"ø	15		
ELBOW - GENERIC	ELBOW - GENERIC: STANDARD/HVAC	3/8"ø-3/8"ø	9		
TEE - GENERIC	TEE - GENERIC: STANDARD	3/4"ø-3/4"ø-3/ 4"ø	1		
TEE - GENERIC	TEE - GENERIC: STANDARD	3/8"ø-3/8"ø-3/ 8"ø	1		
TRANSITION - GENERIC	TRANSITION - GENERIC: STANDARD	3/4"ø-1/2"ø	3		
TRANSITION - GENERIC	TRANSITION - GENERIC: STANDARD	3/4"ø-5/8"ø	2		
TRANSITION - GENERIC	TRANSITION - GENERIC: STANDARD	3/8"ø-1/4"ø	1		

MECHANICAL EQUIPMENT SCHEDULE			
CATAGORY	COUNT		
AIR HANDLING UNIT	AIR HANDLING UNIT: WALL MOUNTED	2	
CONDENSER	CONDENSER: OUT DOOR	1	
EXHAUST FAN	EXHAUST FAN: 75 CFM 1		
	HOOD-WALL: VENT 1		

DUCT FITTING SCHEDULE			
CATAGORY	DESCRIPTION	COUNT	
ROUND TRANSITION - ANGLE	45 DEGREE	5	

	DUCT ACCESSORY SCHEDU	LE
CATAGORY	DESCRIPTION	COUNT
ROOF VENT	3" DIAMETER	3

FLEX DUCT SCHEDULE					
DESCRIPTION	DESCRIPTION	LENGTH	DIAMETER	COUNT	
FLEX DUCT ROUND	FLEX-ROUND	12.10	4"	3	
GRAND TOTAL: 3		12.10			



KEY PLAN

NO.	DESCRIPTION	DAT

NOTE:

LEGEND:

PROJECT

LA County-800 1Bd1Ba-550

DRAWING NAME

HVAC PLAN

 CLIENT NAME:
 Owner

 PROJECT NUMBER:
 15_0001

 DATE:
 4/6/2025 11:30:41 PM

 DESIGNED BY:
 Designer

 DRAWN BY:
 Author

 CHECKED BY:
 Checker

M101

SCALE: As indicated

ELECTRICAL NOTES

- 1. THIS DRAWING DEPICTS THE ELECTRICAL SYSTEM FOR THE LA_County_800_1Bd1Ba_550. IT PROVIDES A VISUAL REPRESENTATION OF THE ELECTRICAL LAYOUT AND COMPONENTS, INCLUDING POWER DISTRIBUTION, LIGHTING, AND CONTROL SYSTEMS.
- 2. THE ELECTRICAL SYSTEM IS DESIGNED TO MEET THE SPECIFIC REQUIREMENTS OF THE BUILDING, INCLUDING POWER DISTRIBUTION, LIGHTING, AND SPECIALIZED ELECTRICAL EQUIPMENT NEEDS, AS PER THE PROJECT SPECIFICATIONS AND APPLICABLE CODES AND STANDARDS.
- 3. THE ELECTRICAL SYSTEM INSTALLATION SHALL COMPLY WITH THE LATEST EDITION OF THE NATIONAL ELECTRICAL CODE (NEC), INTERNATIONAL BUILDING CODE (IBC), AND ALL OTHER APPLICABLE LOCAL, STATE, AND NATIONAL CODES AND REGULATIONS.
- 4. LOCATIONS AS NEEDED, DEVICES ARE SHOWN ON PLANS IN APPROXIMATE IDEAL LOCATIONS, UNLESS SPECIFICALLY DIMMENSIONED.
- 5. OPEN WALLS AS NEEDED TO ALLOW FOR NEW ELECTRICAL INSTALLATIONS.
- 6. LABEL ALL CIRCUITS ON JUNCTION BOXES, RECEPTACLES, DATA, SMOKE DETECTOR, AND EQUIPMENT IN PANEL BOX.
- 7. INSTALL RACEWAY AS NEEDED FOR DDC, ACCESS CONTROL, LOW VOLTAGE WIRING & DATA.
- 8. RELABEL POWER, DATA & FIRE ALARM FOR ROOM #CHANGES.
 9. VERIFY ALL CIRCUITS LABELED ON PRINT ARE CORRECT BEFORE WORKING ON THEM.
- 10. NOTE ON SITE PLAN ALL CHANGES OR MISSING DETAIL TO BE INCORPORATED INTO THE MASTER PLAN.
- 11. DRAWINGS ARE DIAGRAMMATIC ONLY FOR THE PURPOSE OF SHOWING FIXTURE AND OUTLET LOCATIONS.
- 12. ELECTRICAL CONTRACTOR TO VERIFY SERVICE SIZE BY CALCULATION BASED UPON ACTUAL NAME PLATE RATINGS OF SELECTED EQUIPMENT.
- PLATE RATINGS OF SELECTED EQUIPMENT.

 13. VERIFY LOCATION OF SERVICE ENTRANCE WITH POWER COMPANY. PROVIDE UFER GROUND IN
- BUILDING FOUNDATION AT SERVICE ENTRANCE LOCATION.
- 14. PROVIDE A MIN. OF 20 FEET OF ONE *4 BARE COPPER UFER WIRE EMBEDDED IN CONCRETE FOOTING AT THE SERVICE ENTRANCE LOCATION WHERE APPROVED BY LOCAL SERVICE PROVIDER.
- 15. PROVIDE WATERPROOF FIXTURES IN ALL HIGH MOISTURE AREAS (EXTERIOR, SHOWER AND TUB CEILINGS ETC.)
- 16. PROVIDE DEDICATED CIRCUITS TO EACH BATH, DEN, FAMILY ROOM, BEDROOM, LOFT, KITCHEN
- REFRIGERATOR, KITCHEN FREEZER DISHWASHER, AND ANY AREA/ITEM SPECIFIED BY OWNER.

 17. INCANDESCENT FIXTURES WITH OPEN OR PARTIALLY ENCLOSED LAMPS, PENDANT FIXTURES, AND
- LAMP HOLDERS ARE NOT PERMITTED IN CLOSETS.

 18. ALL WORKMANSHIP AND MATERIALS TO CONFORM WITH THE 2015 IRC.
- 19. PROVIDE A MIN. OF 20 FEET OF ONE *4 BARE COPPER UFER WIRE EMBEDDED IN CONCRETE FOOTING AT THE SERVICE ENTRANCE LOCATION WHERE APPROVED BY LOCAL SERVICE PROVIDER.
- 20. PROVIDE A BONDING CONDUCTOR CONSISTING OF A MINIMUM OF ONE *4 BARE COPPER WIRE CONNECTING THE BUILDING'S METAL WATER PIPING SYSTEM TO THE SERVICE EQUIPMENT ENCLOSURE GROUNDING.

MAIN PANEL CALCS

ELECTRICAL CALCS	
LIGHT AND OUTLETS 800 @ 3W	2,400 W
3 APPLIANCE CIRCUITS	4,500 W
DRYER	2,000 W
WASHER	2,000 W
RANGE	5,000 W
WATER HEATER	5,000 W
REFRIG.	1,800 W
DISHWASHER & DISPOSAL	3000 W
TOTAL	25,700 W
FRIST 10,000 @ 100% REMAINDER @ 40% MINI. SPLIT UNITS	10,000 W 6,280W 10,000 W
TOTAL	26,280 W
26,280 W DIVIDED BY 240V =	110 AMPS TOTAL

(USE 200 AMP SERVICE)

ELECTRICAL ABBREVIATIONS LIST

1P	1 POLE (2P, 3P, 4P, ETC.)	CTR	CENTER	HT	HEIGHT
A	AMPERÈ	CU	COPPER	HTG	HEATING
AC	ABOVE COUNTER OR AIR CONDITIONER	DCP	DOMESTIC WATER CIRCULATING PUMP	HTR	HEATER
ACLG	ABOVE CEILING	DEPT	DEPARTMENT	HV	HIGH VOLTAGE
ADO	AUTOMATIC DOOR OPENER	DET	DETAIL	HVAC	HEATING, VENTILATING AND AIR
AF	AMP FRAME	DIA	DIAMETER	CONDITIONING	CONDITIONING
AFF	ABOVE FINISHED FLOOR	DISC	DISCONNECT	HWP	HYDRONIC WATER PUMP
AFG	ABOVE FINISHED GRADE	DIST	DISTRIBUTION	IC	INTERRUPTING CAPACITY
AFI	ARC FAULT CIRCUIT INTERRUPTER	DN	DOWN	IG	ISOLATED GROUND
AHU	AIR HANDLING UNIT	DPR	DAMPER	IMC	INTERMEDIATE METAL CONDUIT
AL	ALUMINUM	DS	SAFETY DISCONNECT SWITCH	INCAND	INCANDESCENT
ALT	ALTERNATE	DT	DOUBLE THROW	IR	INFRARED
AMP	AMPERE	DWG	DRAWING	I/W	INTERLOCK WITH
AMPL	AMPLIFIER	DDC	DIRECT DIGITAL CONTROL	J-BOX	JUNCTION BOX
ANNUN	ANNUNCIATOR APPROX APPROXIMATELY	EC	ELECTRICAL CONTRACTOR	KV	KILOVOLT
AQ-STAT	AQUASTAT	ELEC	ELECTRIC, ELECTRICAL	KVA	KILOVOLT-AMPERE
ARCH	ARCHITECT, ARCHITECTURAL	ELEV	ELEVATOR	KVAR	KILOVOLT-AMPERE REACTIVE
AS	AMP SWITCH	EM	EMERGENCY	KW	KILOWATT
AT	AMP TRIP	EMS	ENERGY MANAGEMENT SYSTEM	KWH	KILOWATT HOUR
ATS	AUTOMATIC TRANSFER SWITCH	EMT	ELECTRICAL METALLIC TUBING	LOC	LOCATE OR LOCATION
AUTO	AUTOMATIC	EP	ELECTRIC PNEUMATIC	LT	LIGHT
AUX	AUXILIARY	EQUIP	EQUIPMENT	LTG	LIGHTING
AV	AUDIO VISUAL	EWC	ELECTRIC WATER COOLER	LTNG	LIGHTNING
AWG	AMERICAN WIRE GAUGE	EXIST	EXISTING	LV	LOW VOLTAGE
BATT	BATTERY	EXH	EXHAUST	MAX	MAXIMUM
BD	BOARD	EXP	EXPLOSION PROOF	MAG.S	MAGNETIC STARTER
BLDG	BUILDING	FA	FIRE ALARM	M/C	MOMENTARY CONTACT
BMS	BUILDING MANAGEMENT SYSTEM	FABP	FIRE ALARM BOOSTER POWER	MC	MECHANICAL CONTRACTOR
C	CONDUIT	SUPPLY PANEL	SUPPLY PANEL	MCB	MAIN CIRCUIT BREAKER
CAB	CABINET	FACP	FIRE ALARM CONTROL PANEL	MCC	MOTOR CONTROL CENTER
CAT	CATALOG	FCU	FAN COIL UNIT	MDC	MAIN DISTRIBUTION CENTER
CATV	CABLE TELEVISION	FIXT	FIXTURE	MDP	MAIN DISTRIBUTION PANEL
СВ	CIRCUIT BREAKER	FLR	FLOOR	MFR	MANUFACTURERMAIN FUSED
CCTV	CLOSED CIRCUIT TELEVISION	FLUOR	FLUORESCENT		DISCONNECT SWITCH
CKT	CIRCUIT	FU	FUSE	MH	MANHOLE
CLG	CEILING	FUDS	FUSED SAFETY DISCONNECT SWITCH	MIC	MICROPHONE
COMB	COMBINATION	GA	GAUGE	MIN	MINIMUM
CMPR	COMPRESSOR	GAL	GALLON	MISC	MISCELLANEOUS
CONN	CONNECTION	GALV	GALVANIZED	MLO	MAIN LUGS ONLY
CONST	CONSTRUCTION	GC	GENERAL CONTRACTOR	MMS	MANUAL MOTOR STARTER
CONT	CONTINUATION OR CONTINUOUS	GEN	GENERATOR	MOA	MULTIOUTLET ASSEMBLY
CONTR	CONTRACTOR	GFI	GROUND FAULT CIRCUIT INTERRUPTER	MSP	MOTOR STARTER PANELBOARD
CONV	CONVECTOR	GFP	GROUND FAULT PROTECTOR	MSBD	MAIN SWITCHBOARD
CP	CIRCULATING PUMP	GND	GROUND	MT	MOUNT
CRT	CATHODE-RAY TUBE	GRS	GALVANIZED RIGID STEEL (CONDUIT)	MT.C	EMPTY CONDUIT
CT	CURRENT TRANSFORMER	GYP BD	GYPSUM BOARD	UL	UNDERWRITERS LABORATORIES

Branch Panel:

Location: KITCHEN 03
Supply From:
Mounting: Recessed
Enclosure: Type 1

Volts: 120/240 Single
Phases: 1
Wires: 3

A.I.C. Rating: Mains Type: Mains Rating: 200 A MCB Rating: 1 A

Notes

Circuit Numb er	Circuit Description	Number of Elements	Rating	Length	Wire Size	A			В	Wire Size	Length	Rating	Number of Elements	Circuit Description	Circui Numb er
1	CONDENCER	1	60 A	15' - 6 17/32"	2-#6, 1-#6, 1-#10	750 VA	750 VA			2-#10, 1-#10, 1-#10	12' - 5 5/32"	30 A	1	WATER HEATER	2
3								750 VA	750 VA						4
5	RANGE	1	50 A	9' - 9 11/32"	2-#8, 1-#8, 1-#10	750 VA	420 VA			1-#12, 1-#12, 1-#12	36' - 2 21/32"	20 A	10	HALL AND KITCHEN LIGHT POINTS	6
7								750 VA	1092 VA	1-#12, 1-#12, 1-#12	38' - 8 5/32"	20 A	8	GFCI OUTDOOR RECEPTACLES AND LIGHT	8
9	DRYER	1	30 A	29' - 1 1/32"	2-#10, 1-#10, 1-#10	750 VA	1080 VA			1-#12, 1-#12, 1-#12	49' - 2 29/32"	20 A	6	BEDROOM RECEPTACLES	10
11								750 VA	240 VA	1-#12, 1-#12, 1-#12	26' - 11 17/32"	20 A	5	DINING AREA LIGHT UNITS	12
13	DINING GFCI RECEPTACLES	4	20 A	22' - 6 3/32"	1-#12, 1-#12, 1-#12	720 VA	1200 VA			1-#10, 1-#10, 1-#10	23' - 9 15/32"	30 A	1	DISH WASHER	14
15	BEDROOM LIGHT UNITS	10	20 A	38' - 9 15/32"	1-#12, 1-#12, 1-#12			568 VA	1260 VA	1-#12, 1-#12, 1-#12	21' - 3 13/32"	20 A	7	KITCHEN GFCI RECEPTACLES	16
17	BATHROOM UNITS	5	20 A	25' - 1 5/16"	1-#12, 1-#12, 1-#12	336 VA	1500 VA			1-#12, 1-#12, 1-#12	16' - 9 7/32"	20 A	1	REFRIGERATOR	18
19	GFCI WASHER	1	20 A	29' - 10 1/32"	1-#12, 1-#12, 1-#12			1200 VA	1620 VA	1-#10, 1-#10, 1-#10	51' - 3 23/32"	20 A	9	LIVING-DINING AND HALL RECEPTACLES	20
21							336 VA			1-#12, 1-#12, 1-#12	38' - 4 3/8"	20 A	9	LIVING ROOM LIGHT UNITS	22
23															24
25															26
						8590	VA	897	7 VA						

Connected Load	Demand Factor	Estimated Demand	Panel	Totals
300 VA	100.00%	300 VA		
1432 VA	100.00%	1432 VA	Total Conn. Load:	17568 VA
15660 VA	81.93%	12830 VA	Total Est. Demand:	14738 VA
200 VA	100.00%	200 VA	Total Conn.:	73 A
			Total Est. Demand:	61 A
_	1432 VA 15660 VA	1432 VA 100.00% 15660 VA 81.93%	1432 VA 100.00% 1432 VA 15660 VA 81.93% 12830 VA	1432 VA 100.00% 1432 VA Total Conn. Load: 15660 VA 81.93% 12830 VA Total Est. Demand: 200 VA 100.00% 200 VA Total Conn.:

KEY PLAN

NO.	DESCRIPTION	DATE

NOTE:

LEGEND:

PROJECT

LA-County-800-1Bd1Ba-550

DRAWING NAME

SCHEDULE

CLIENT NAME:	Owner
PROJECT NUMBER:	0386_12
DATE:	4/7/2025 2:57:56 AM
DESIGNED BY:	Designer
DRAWN BY:	Author
CHECKED BY:	Checker

E101

SCALE: 1/4" = 1'-0"

© [2024] [FrameUpNow] . All rights reserved

ELECTRICAL NOTE

- A. PROVIDE INTERCONNECTED SMOKE ALARMS IN EACH SLEEPING ROOMS, OUTSIDE EACH SLEEPING ROOM, ON EACH STORY, IN THE HALL OR ADJACENT ROOM LUHERE THE CEILING HEIGHT OF A ROOM OPEN TO THE HALL EXCEEDS THE HALL BY 24'. SMOKE ALARMS SHALL BE PERMANENTLY HARD WIRED WITH BATTERY BACKUP.
- B. RECEPTACLE OUTLETS FOR RANGES AND CLOTHES DRYERS SHALL BE A THREE POLE WITH GROUND TYPE. FOUR WIRE GROUNDING-TYPE FLEXIBLE CORDS WILL BE REQUIRED FOR CONNECTION OF RANGES AND CLOTHES DRYERS. THE BONDING JUMPER SHALL NOT BE CONNECTED BETWEEN NEUTRAL TERMINAL AND THE FRAME OF THE APPLIANCE.
- C. TWO OR MORE 20 AMP SMALL APPLIANCE CIRCUITS SHALL BE PROVIDED TO SERVE THE KITCHEN, BREAKFAST NOOK, AND DINING ROOM. SUCH CIRCUITS SHALL HAVE NO OTHER OUTLETS.
- D. AT LEAST ONE 20 AMP BRANCH CIRCUIT SHALL BE PROVIDED TO SERVICE THE LAUNDRY ROOM. THIS CIRCUIT SHALL HAVE NO OTHER OUTLETS.
- E. ALL RECEPTACLES WITH IN 6' OF A WET BAR SINK OR KITCHEN SINK TO SERVE COUNTER TOP SURFACES MUST BE GFCI. ON KITCHEN COUNTERS 12' OR WIDER NO POINT ALONG THE WALL SHALL BE MORE THAN 2' FROM A RECEPTACLE. ALL RECEPTACLES WITH IN 6' OF KITCHEN SINK MUST BE GFCI. AT LEAST ONE GFCI RECEPTACLE SHALL
- BE INSTALLED IN THE BATHROOM ADJACENT TO EACH BASIN.

 F. FIXTURES INCLUDING CEILING FANS THAT ARE LOCATED IN DAMP LOCATIONS SHALL BE LISTED TO BE SUITABLE FOR
- SUCH LOCATIONS PER 2012 IRC
- G. PROVIDE ONE (1) SWITCHED OUTLET @ ALL BEDROOMS AND DEN
- H. CEILING FANS NOT EXCEEDING 35 LBS. (WITH OR WITHOUT ACCESSORIES MAY BE SUPPORTED BY OUTLET BOXES PROVIDED THE OUTLET BOXES ARE IDENTIFIED FOR SUCH USE PER 2012 IRC
- I. ELECTRICAL OUTLET BOXES ON OPPOSITE SIDES OF FIRE RATED WALLS SHALL BE SEPARATED BY A HORIZONTAL DISTANCE OF NOT LESS THAN 24".
- J. OUTLET BOXES IN THE WALLS BETWEEN THE GARAGE AND DWELLING SHALL BE METAL OR U.L. APPROVED FIRE RESISTIVE PLASTIC. BOXES IN GARAGE CEILING SHALL BE METAL.
- K. ALL BRANCH CIRCUITS THAT SUPPLY 120 VOLTS SINGLE PHASE 15 AND 20 AMPS RECEPTACLE OUTLETS INSTALLED IN THE DWELLING SHALL BE PROTECTED BY AN ARC FAULT CIRCUIT INTERRUPTER, EXCEPT GFCI RECEPTICLES.

NOTE:

A. RECEPTACLES MUST BE PROVIDED IN HALLWAYS 10'-0" OR MORE IN LENGTH. FOR A ONE FAMILY DWELLINGS AND EACH OF A TWO FAMILY DWELLING THAT IS AT GRADE LEVEL, AT LEAST ONE WP-GFCI RECEPTACLE OUTLET ACCESSIBLE AT GRADE LEVEL AND NOT MORE THAN 6'-6" ABOVE GRADE SHALL BE INSTALLED AT THE FRONT AND BACK OF THE DWELLING.

NOTE: APPLIANCE DISCONNECT

E4001.5 GROUNDING OF ENCLOSURES.

METAL ENCLOSURES FOR SWITCHES OR CIRCUIT BREAKERS SHALL BE CONNECTED TO AN

EQUIPMENT GROUNDING CONDUCTOR.

METAL ENCLOSURES FOR SWITCHES OR CIRCUIT BREAKERS USED AS SERVICE

EQUIPMENT SHALL COMPLY WITH THE PROVISIONS OF SECTION E3609.4. WHERE


NONMETALLIC ENCLOSURES ARE USED WITH METAL RACEWAYS OR METAL-ARMORED

CABLES, PROVISIONS SHALL BE MADE FOR CONNECTING THE EQUIPMENT GROUNDING CONDUCTOR.


NONMETALLIC BOXES FOR SWITCHES SHALL BE INSTALLED WITH A WIRING METHOD THAT


PROVIDES OR INCLUDES AN EQUIPMENT GROUNDING CONDUCTOR. (404.12)

ELECTRICAL LEGEND						
	Electrical Lights With Fan					
0	Waterproof Recessed Can Light					
	Pendant Light					
0	Recessed Can Light					
- □	Wall Lamp					
	Standalone linear					
⊬ 6	Single Switch					
₩,	Three way Switch					
₽	Fan Switch					
	Duplex Receptacle					
	Triplex Receptacle					
⊕ GFCI	GFCI Receptacle					
	Exhaust Fan					
•	Smoke and heat detector					

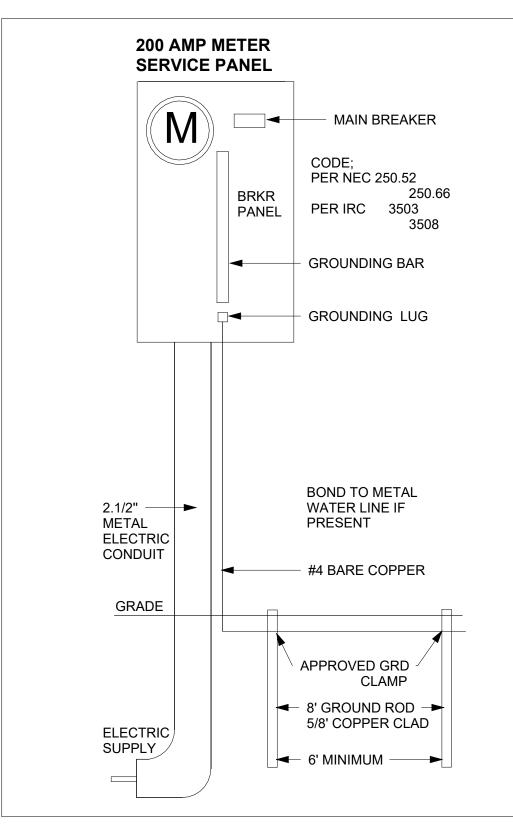

SERVICE PANEL DIAGRAM
12" = 1'-0"

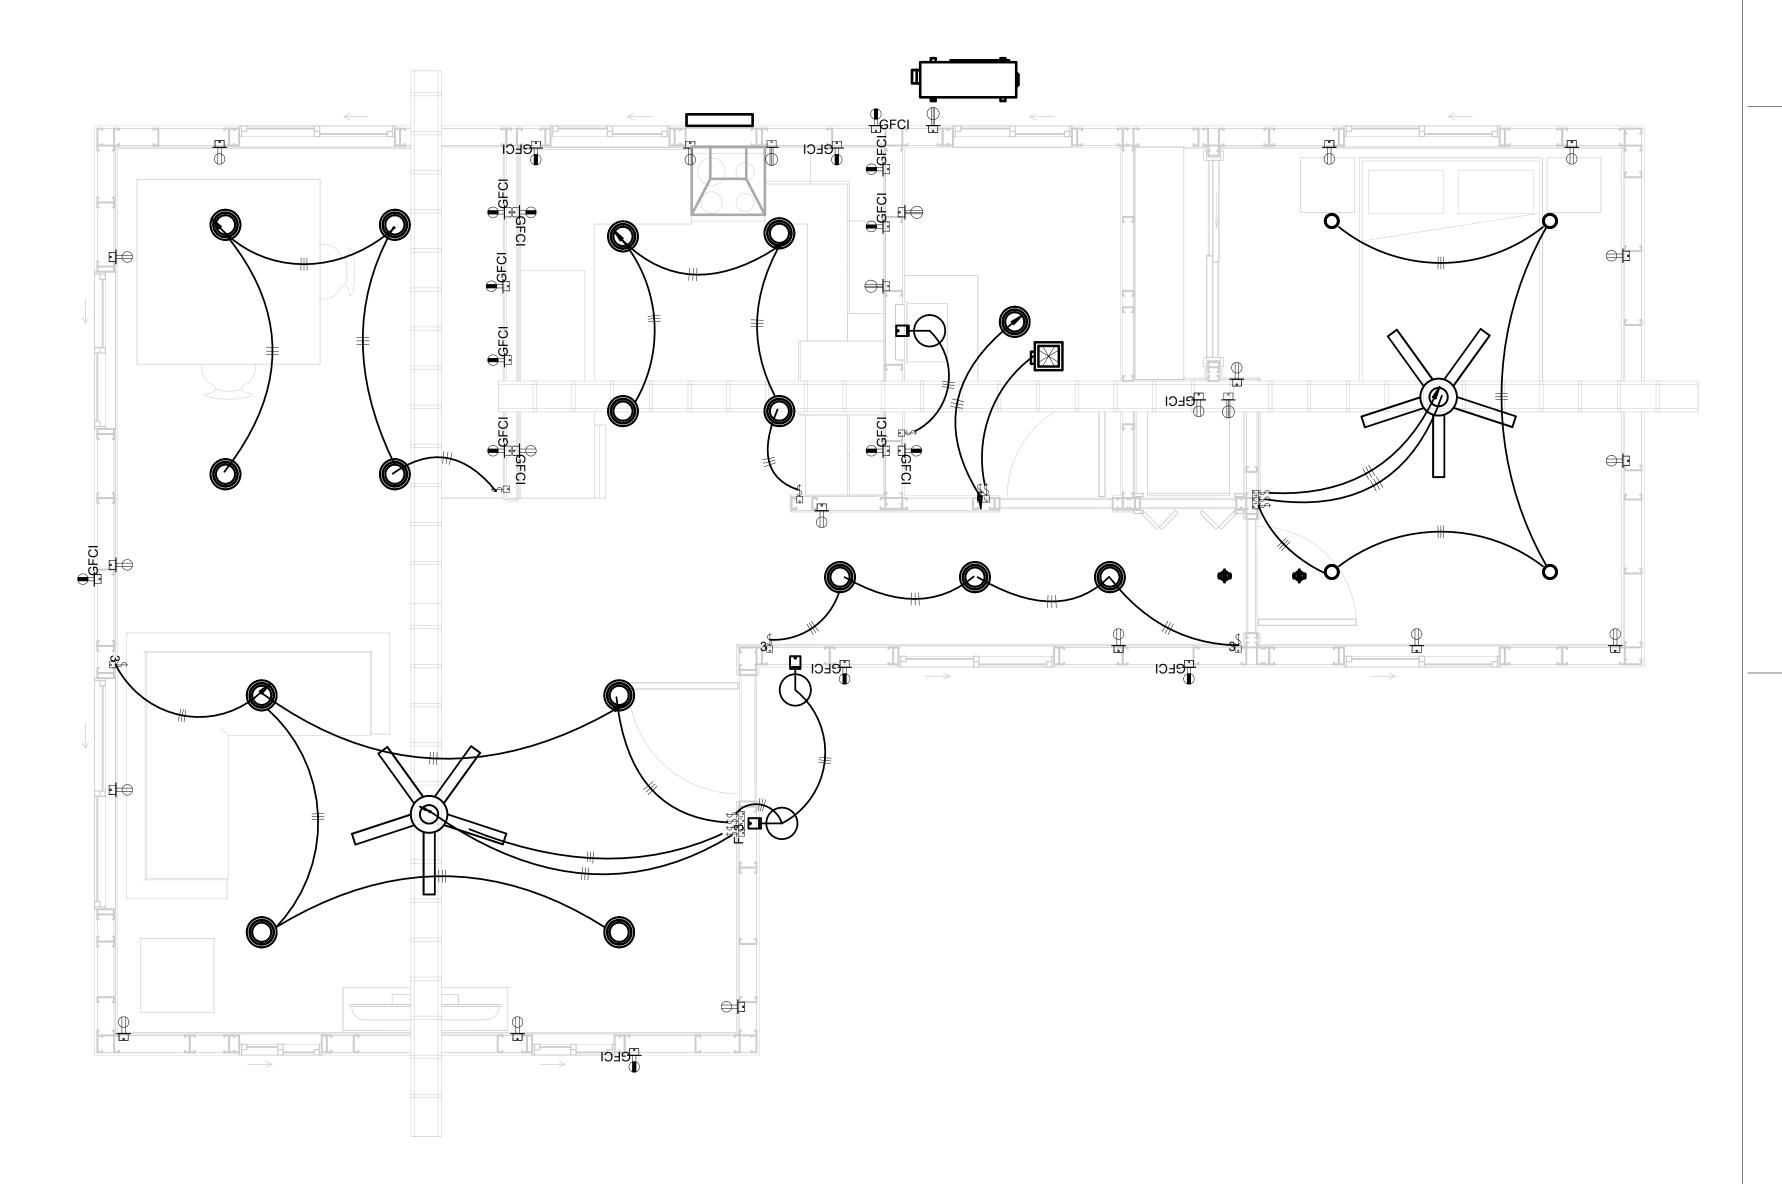

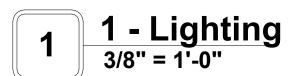



KEY PLAN

NO.	DESCRIPTION	DATE

NOTE:

LEGEND:

PROJECT

LA-County-800-1Bd1Ba-550

DRAWING NAME

LIGHTING


CLIENT NAME:	Owner
PROJECT NUMBER:	0386_12
DATE:	4/7/2025 2:57:58 AM
DESIGNED BY:	Designer
DRAWN BY:	Author
CHECKED BY:	Checker

E102


SCALE: As indicated


NOTES: CONDUIT, CABLE AND WIRING


- Use Metalic Conduits (IMC) for cables running under concrete slabs.
 Use IMC for circuits with high voltage appliances (240 volts and above)
 For circuits with 120 volts consider using EMT or PVC conduits if needed.
 For Low voltage applications up to 50 volts consider using non metalic conduits.
 All conduits to be used in the project must conform to the latest National Electrical Code (NEC),
- 5. All conduits to be used in the project must comorn to the latest National Electrical Code (NEC), 2015.
 6. All wiring and cables to be used in the project must also conform to the latest National Electrical Code (NEC), 2015.
 7. All cables and wires used should be rated for their respective loading and should be gauged and conform to the NEC.

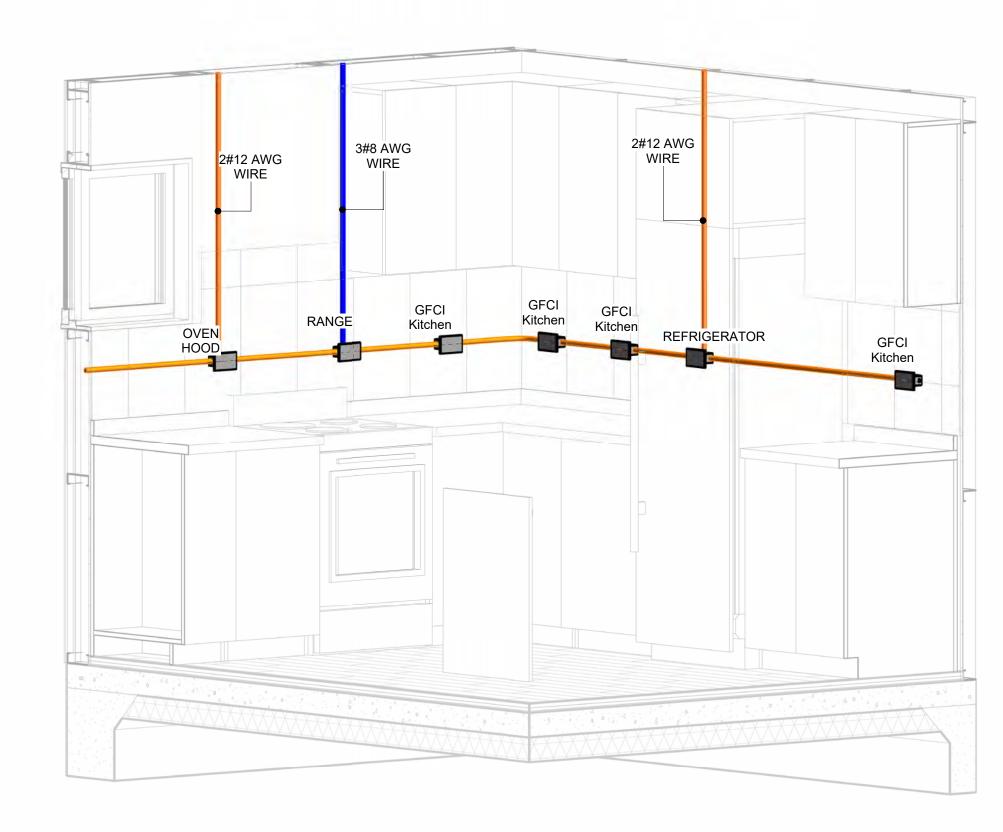





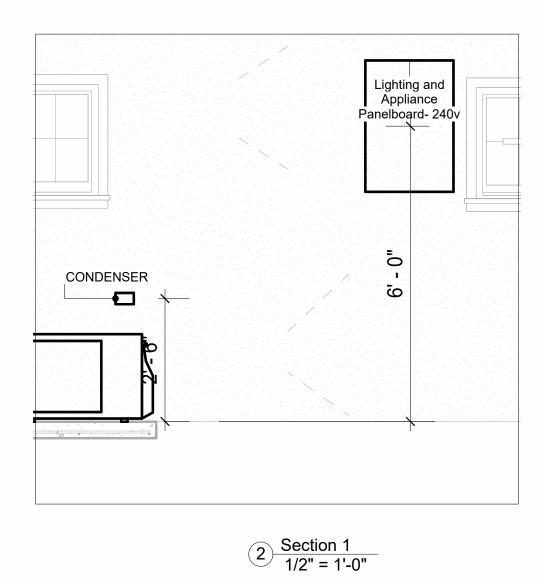

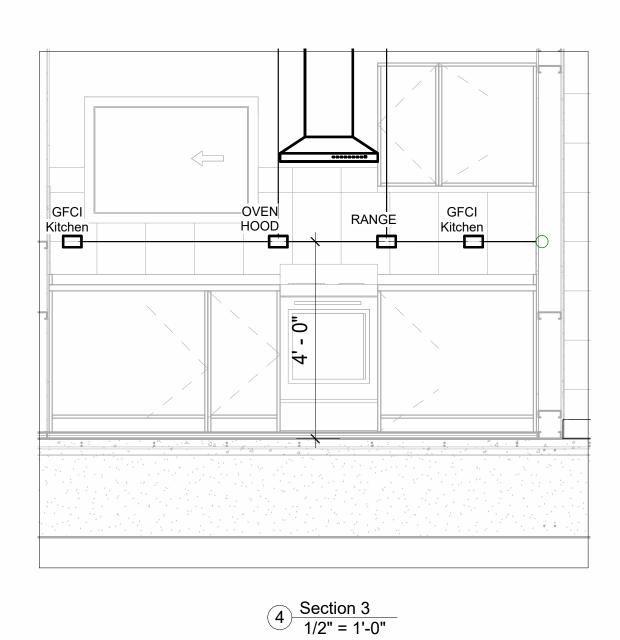

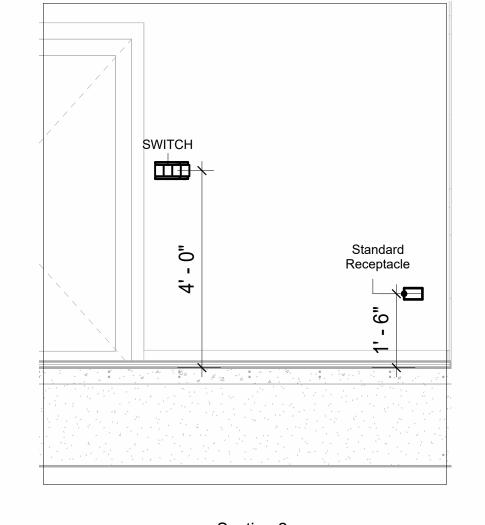


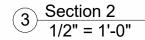

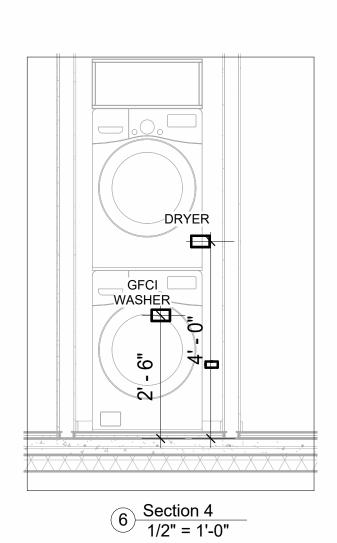



KEY PLAN

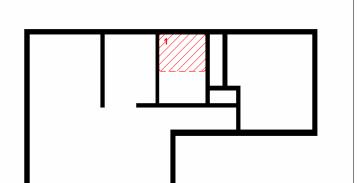

NO.	DESCRIPTION	DATE					

NOTE:

LEGEND:

PROJECT

LACounty-800-1Bd1Ba-550

DRAWING NAME

POWER

Owner	CLIENT NAME:
0386_12	PROJECT NUMBER:
4/7/2025 2:58:24 AN	DATE:
Designer	DESIGNED BY:
Author	DRAWN BY:
Checker	CHECKED BY:

E103

NOTES: LIGHT

- 1. LIGHT FIXTURES AND LUMINARIES SHALL CONFORM TO THE NEC, THE IRC AND LOCAL SAFETY & BUILDING CODE.
- 2. ALL LIGHTING FIXTURES SHOULD CONFORM TO THE DESIGN ELECTRICAL LOAD AND SHALL BE PROPERLY WIRED AND MOUNTED BY QUALIFIED ELECTRICIAN FOLLOWING MANUFACTURERS SPECIFICATIONS.
- CEILING FANS AND FANS WITH LIGHT WITH WEIGHT EXCEEDING 35 LBS SHOULD BE PROVIDED WITH STRUCTURAL BACKING FOR SUPPORT AND SHALL BE FIXED AS PER MANUFACTURERS SPECIFICATIONS.
- 4. EXTERIOR LIGHTS SHALL CONFORM TO LOCAL BUILDING CODE AND GUIDELINES.

NOTES: SWITCH JUNCTION BOX


- THE MINIMUM SIZE OF JUCTION BOX TO BE USED IS 2"X4"X(1.5" OR 3.5" DEEP) THIS ARE TO BE USED FOR SINGLE GANG SWITCH OR OUTLETS.
- 2. FOR DOUBLE GANG (2 GANG) OUTLETS AND SWITCHS THE MINIMUM SIZE OF THE
- JUCTION BOX TO BE PROVIDED SHALL NOT BE LESS THAN 4"X4"X(1.5" OR 3.5" DEEP)
- 3. FOR THREE GANG (3 GANG) OUTLETS AND SWITCHS THE MINIMUM SIZE OF THE JUĆTION BOX SHALL NOT BE LESS THAN 6"X4"X(1.5" OR 3.5" DEEP).

Conduit Fitting Schedule(junction box)				
Family Count Description				

Electrical Fixture Schedule (SWITCH BOX)				
Type Count				
Double Gang Switch Box	1			
Single Gang Switch Box	7			
Triple Gang Switch Box 2				

Lighting Device			
Type Count			
Fan switch	2		
Single Pole	9		
Three Way	4		

Lighting Fixture				
Lighting Fixture Type	Voltage	Electrical Load	Count	
Electrical_Lights_Fan-Light1	120 V/1-100 VA- 120 V/1-100 VA	200 A, 120 V/240 V, Single Phase, 3 Wires	2	
Lighting_Recessed	120 V/1-60 VA	200 A, 120 V/240 V, Single Phase, 3 Wires	16	
SASSO 100 round wallwasher trim	120 V/1-28 VA	200 A, 120 V/240 V, Single Phase, 3 Wires	4	
Wall Lamp - Bracket	120 V/1-100 VA	200 A, 120 V/240 V, Single Phase, 3 Wires	3	

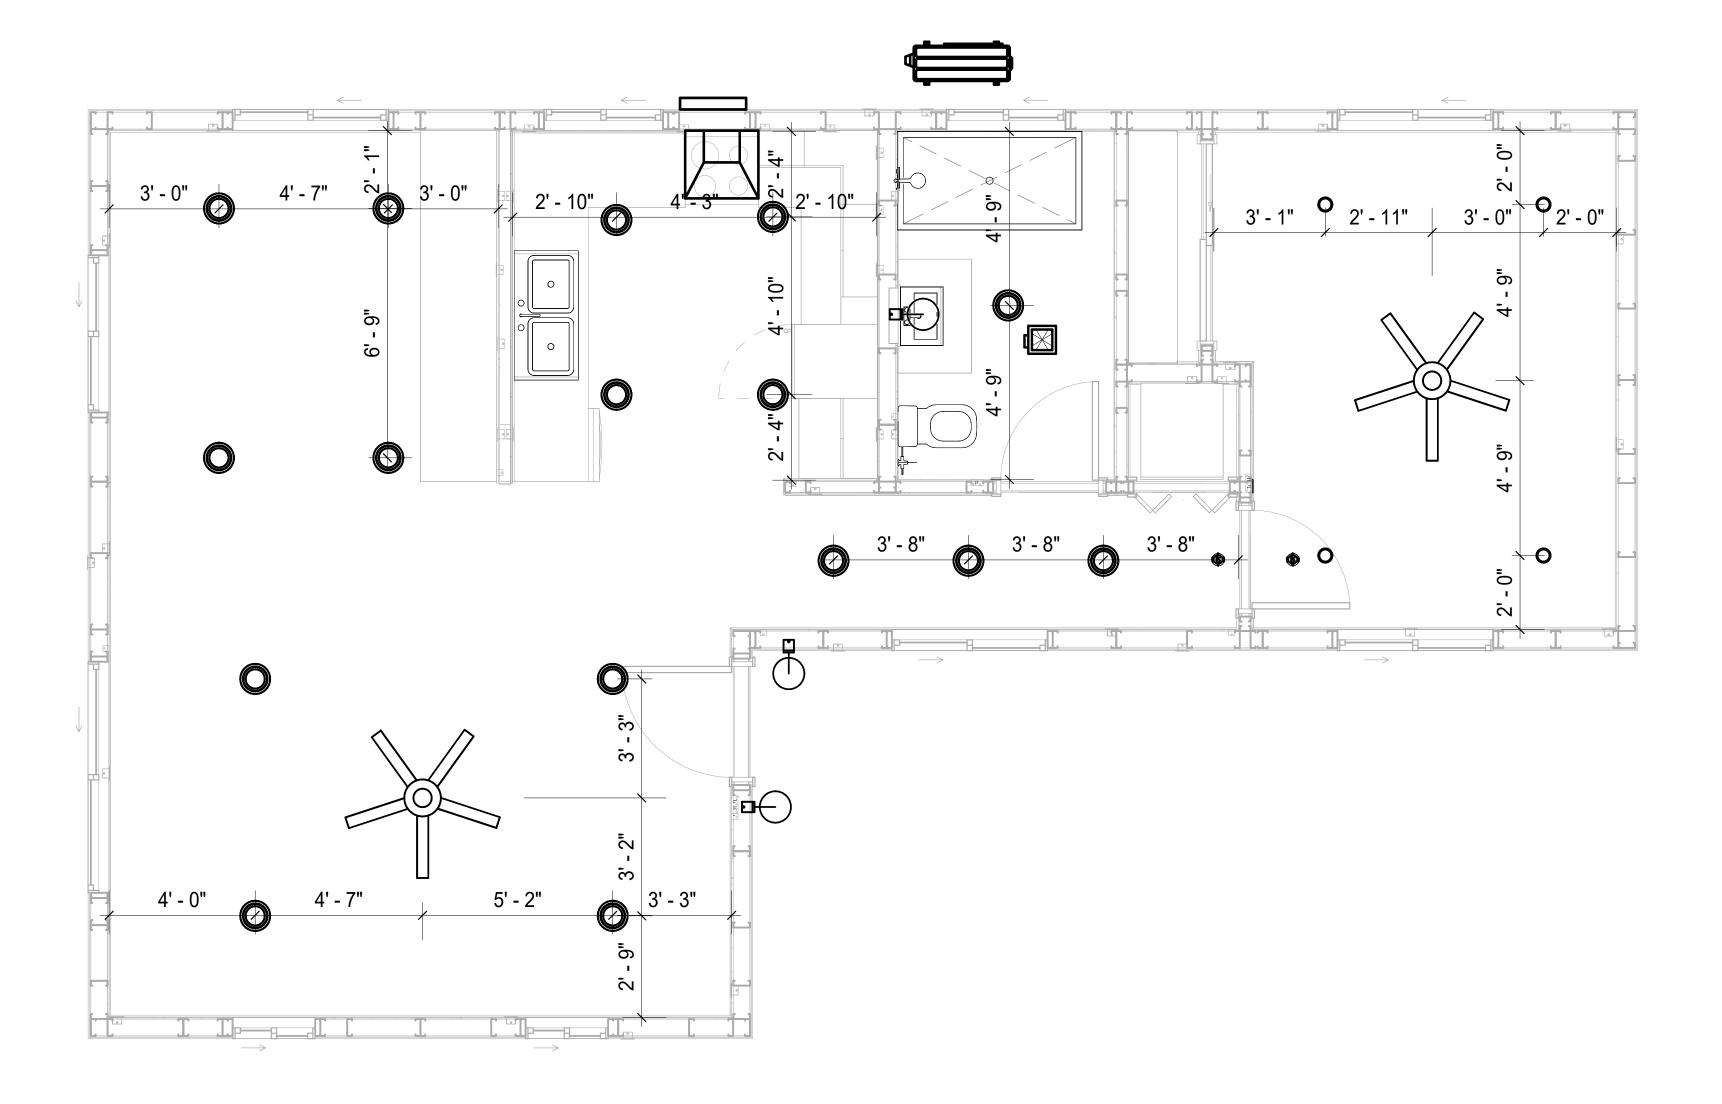

1 DIMENSION FOR LIGHT FIXTURES
3/8" = 1'-0"

KEY PLAN

NO. DESCRIPTION DATE

NOTE:

LEGEND:

PROJECT

LA-County-800-1Bd1Ba-550

DRAWING NAME

DIMENSION PLAN FOR LIGHT FIXTURES

CLIENT NAME:	Owner
PROJECT NUMBER:	0386_12
DATE:	4/7/2025 2:58:26 AM
DESIGNED BY:	Designer
DRAWN BY:	Author
CHECKED BY:	Checker

E104


SCALE: 3/8" = 1'-0"

NOTES;

- 1. VERIFY EQUIPMENT PLUG CONFIGURATION BEFORE PURCHASING RECEPTACLES
- 2. FOR ALL EQUIPMENT.
- 3. COORDINATE EXACT LOCATION OF LIGHT FIXTURES, WALL SWITCHES, RECEPTACLES AND OTHER DEVICES WITH ARCHITECTURAL DRAWINGS.
- 4. USE METALLIC JUNCTION BOX WITH THE GFCI RECEPTACLES, WITH HIGHT VOLTAGE.

Electrical Fixture Schedule (Receptacle)		
Type Count		
CONDENSER	1	
DRYER	1	
GFCI DISHWASHER	1	
GFCI Kitchen	10	
GFCI OUT DOOR	6	
GFCI WASHER	1	
OVEN HOOD	1	
RANGE	1	
REFRIGERATOR	1	
Standard Receptacle	16	
water heater	1	

Electrical Outlet Schedule				
Туре	Circuit Number	Electrical Data		Count
Standard Receptacle		120 V/1-180 VA	1	
CONDENSER	1,3	240 V/2-1500 VA	1	
vater heater	2,4	240 V/2-1500 VA	1	
RANGE	5,7	240 V/2-1500 VA	1	
GFCI OUT DOOR	8	120 V/1-180 VA	5	
DRYER	9,11	240 V/2-1500 VA	1	
Standard Receptacle	10	120 V/1-180 VA	6	
GFCI Kitchen	13	120 V/1-180 VA	4	
GFCI DISHWASHER	14	120 V/1-1200 VA	1	
GFCI Kitchen	16	120 V/1-180 VA	6	
OVEN HOOD	16	120 V/1-180 VA	1	
GFCI OUT DOOR	17	120 V/1-180 VA	1	
REFRIGERATOR	18	120 V/1-1500 VA	1	
FCI WASHER	19	120 V/1-1200 VA	1	
Standard Receptacle	20	120 V/1-180 VA	9	

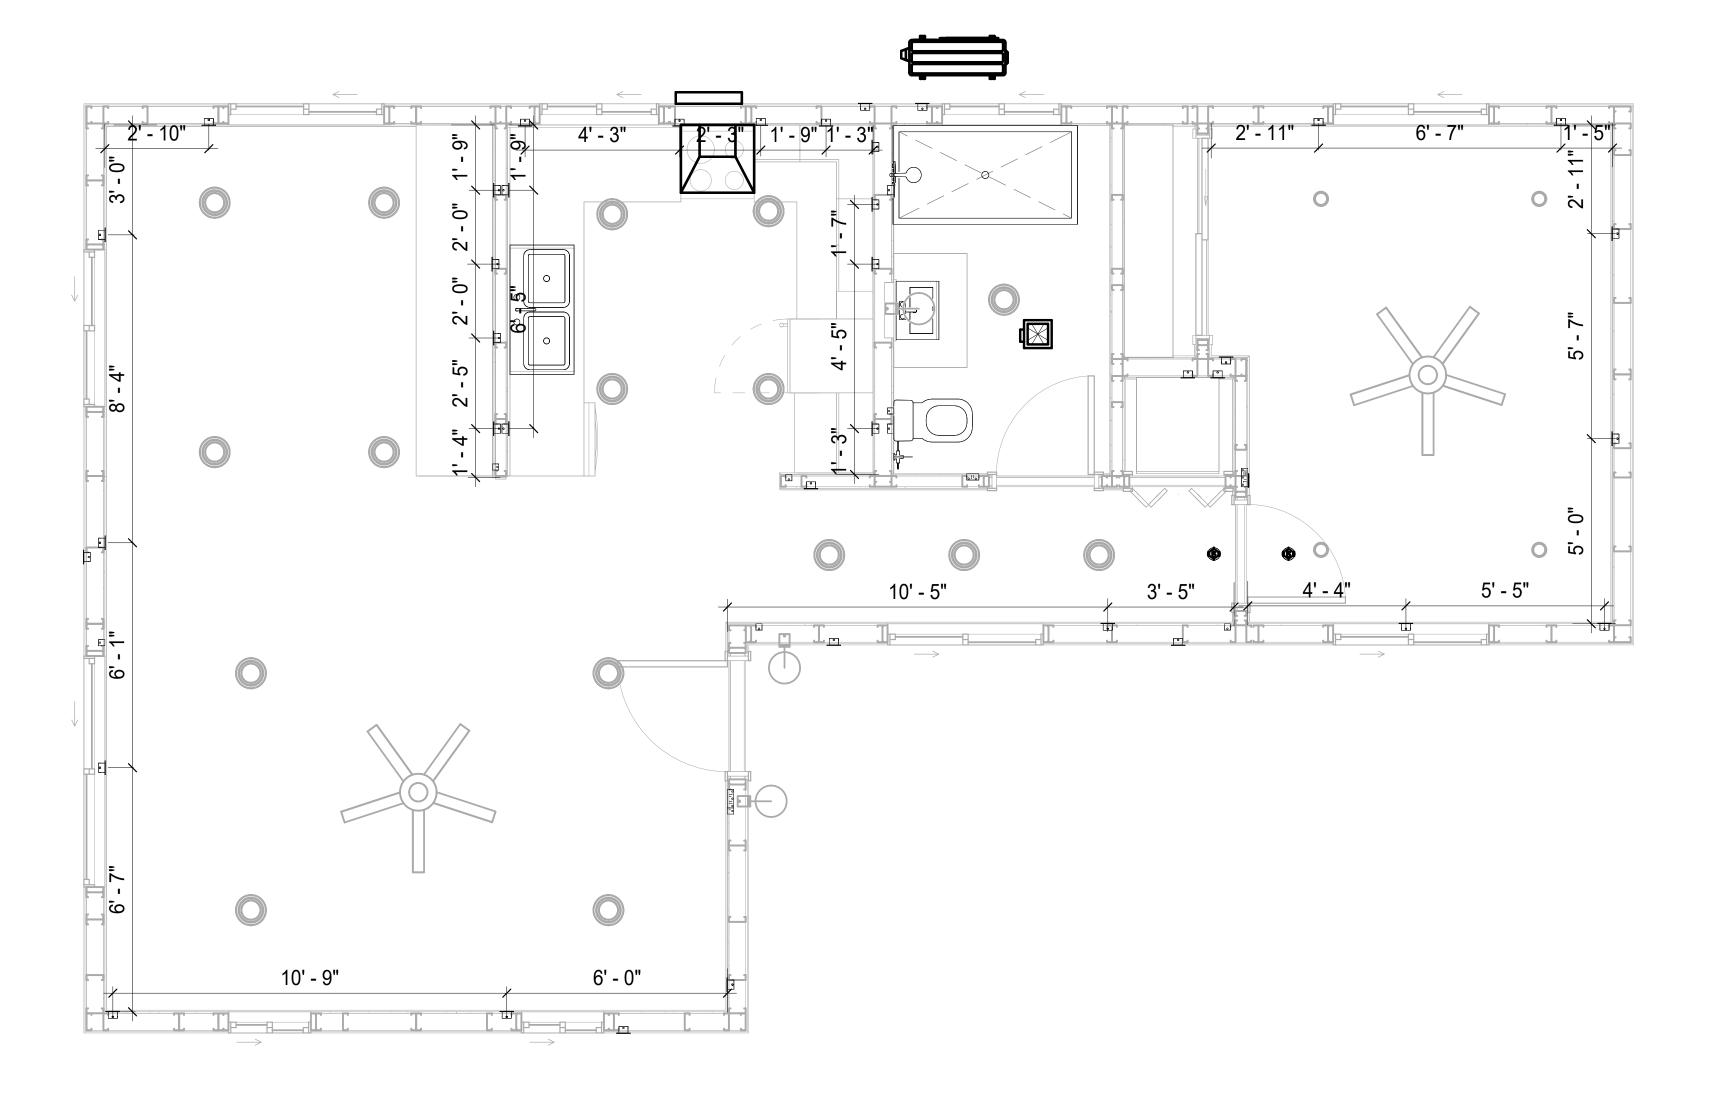

1 DIMENSION FOR FITTINGS
3/8" = 1'-0"

KEY PLAN

NO. DESCRIPTION DATE

NOTE:

LEGEND:

PROJECT

LA-County-800-1Bd1Ba-550

DRAWING NAME

DIMENSION PLAN FOR FITTINGS

CLIENT NAME:	Owner
PROJECT NUMBER:	0386_12
DATE:	4/7/2025 2:58:27 AM
DESIGNED BY:	Designer
DRAWN BY:	Author
CHECKED BY:	Checker

E105

SCALE: 3/8" = 1'-0"

SHEET LIST

SHEET NUMBER SHEET NAME

P101 NOTE AND SCHEDULE P102 WATER SUPPLY AND SEWAGE SYSTEM

PIPE COLOR SCHEME DOMESTIC COLD WATER DOMESTIC HOT WATER -- - SANITARY VENT SANITARY SEWER ----- STORM DRAINAGE GRAY WATER GAS LINE

PLUMBING NOTES

- THE PLUMBING SYSTEM IS DESIGNED TO MEET THE BUILDING'S DOMESTIC WATER SUPPLY, SANITARY DRAINAGE, AND STORM DRAINAGE REQUIREMENTS, AS PER PROJECT SPECIFICATIONS AND APPLICABLE CODES.
- THE SYSTEM INSTALLATION SHALL COMPLY WITH THE LATEST INTERNATIONAL PLUMBING CODE (IPC), INTERNATIONAL RESIDENTIAL CODE (IRC), AND ALL OTHER RELEVANT LOCAL, STATE, AND NATIONAL REGULATIONS.
- ALL PLUMBING WORK SHALL COMPLY WITH THE LATEST EDITION OF THE INTERNATIONAL PLUMBING CODE (IPC) AND THE LOCAL PLUMBING CODE.
- PLUMBING SYSTEMS SHALL BE TESTED AND INSPECTED IN ACCORDANCE WITH THE LOCAL PLUMBING CODE REQUIREMENTS.
- 5. PLUMBING FIXTURES SHALL BE INSTALLED WITH THE APPROPRIATE TRIM, FITTINGS, AND ACCESSORIES, AS RECOMMENDED BY THE MANUFACTURER.
- 6. PIPING SHALL BE PROPERLY SUPPORTED AND SECURED TO PREVENT SAGGING,
- MOVEMENT, AND VIBRATION. SHUT-OFF VALVES SHALL BE PROVIDED AT ALL BRANCH CONNECTIONS AND AT THE
- INLET AND OUTLET OF EACH PIECE OF EQUIPMENT. BACKFLOW PREVENTION DEVICES SHALL BE INSTALLED AS REQUIRED BY THE LOCAL
- PLUMBING CODE TO PROTECT THE POTABLE WATER SYSTEM. PLUMBING FIXTURES AND EQUIPMENT SHALL BE ACCESSIBLE FOR MAINTENANCE AND
- 10. EXPOSED PLUMBING PIPING AND FIXTURES SHALL BE INSULATED TO PREVENT CONDENSATION AND ENERGY LOSS.
- 11. DEAD ENDS IN THE DRAINAGE SYSTEM MUST BE AVOIDED, EXCEPT WHERE NECESSARY TO INSTALL A CLEANOUT IN AN ACCESSIBLE LOCATION, AND MUST HAVE A VENTED CONNECTION TO THE OUTSIDE ATMOSPHERE.
- 12. THE VERTICAL DEFLECTION OF PVC PIPE MUST NOT EXCEED 5%, AND NO DEFLECTION IS PERMITTED FOR IRON PIPE.
- 13. WORK MUST BE PROPERLY COORDINATED WITH OTHER TRADES TO AVOID CONFLICTS, REFERRING TO THE ARCHITECTURAL AND STRUCTURAL DRAWINGS FOR INFORMATION REGARDING CEILING ELEVATIONS, SPACE CLEARANCES, WALL AND PARTITION LOCATIONS, ETC.
- 14. ALL FIXTURES SHALL HAVE ACCESSIBLE STOPS.
- 15. DOMESTIC WATER PIPING SHALL BE PEX, AND PVC PIPING IS NOT ACCEPTABLE FOR INTERIOR USE.
- 16. VENT TERMINATIONS SHALL BE LOCATED AT LEAST 10 FEET FROM OR 3 FEET ABOVE ANY OPERABLE WINDOW, DOOR OPENING, AIR INTAKE, OR VENT SHAFT, AND AT LEAST 3 FEET IN EVERY DIRECTION FROM ANY LOT LINE, ALLEY, OR STREET.
- 17. PIPE AND FITTINGS UTILIZED IN THE WATER SUPPLY SYSTEM SHALL HAVE A MAXIMUM OF 8 PERCENT LEAD.
- 18. ACRYLONITRILE BUTADIENE STYRENE (ABS) SHALL BE USED FOR THE SEWERAGE AND
- VENTILATION SYSTEM. 19. CROSS-LINKED POLYETHYLENE (PEX) SHALL BE USED FOR THE WATER SUPPLY SYSTEM.
- POLYVINYL CHLORIDE (PVC) SHALL BE USED FOR THE RAIN WATER SYSTEM.
- 21. THE MIMIMUM WATER SUPPLY DEPTH UNDER FLOOR FINISH SHOUD BE 1/2".
- 22. ANY PIPE INSTALLED UNDERGROUND MUST HAVE AT LEAST 12 INCHES OF CLEARANCE BETWEEN THE OUTSIDE OF THE PIPE AND ANY OTHER UNDERGROUND STRUCTURE.
- 23. THE MINIMUM CLEARANCE BETWEEN COLD AND HOT WATER LINES IN RESIDENTIAL HOMES MAINTAIN A MINIMUM DISTANCE OF 6 INCHES.
- HORIZONTAL SEPARATION BETWEEN WATER AND SEWER LINES: A MINIMUM OF 12 INCHES BETWEEN POTABLE WATER SUPPLY LINES (COLD AND HOT WATER) AND
- SANITARY SEWER LINES.

ABBREVIATIONS

Ø	DIAMETER
ABS	ACRYLONITRILE BUTADIENE STYRENE
ABV	ABOVE
AD	AREA DRAIN
AFF	ABOVE FINISHED FLOOR
ALT	ALTERNATE
BFF	BELOW FINISHED FLOOR
BLW	BELOW
CO	CLEAN OUT
CW	COLD WATER
D	DEGREE
DFU	DRANAGE FIXTURE UNIT
DIA	DIAMETER
DN	DOWN
FCO	FLOOR CLEAN OUT
FD	FLOOR DRAIN
FL	FLOOR
FS	FLOOR SINK
FT FT	FOOT/FEET
HB	HOSE BIB
HW	HOT WATER
IN	INCH
MIN	MINIMUM
NO	NUMBER
NTS	NOT TO SCALE
PEX	CROSS-LINKED POLYETHYLENE
PLBG	PLUMBING
PVC	POLYVINYL CHLORIDE
QTY	QUANTITY
RD	ROOF DRAIN
RED	REDUCER
RM	ROOM
RW	RAIN WATER
SF	SQUARE FOOT
V	VENT
VTR	VENT THROUGH ROOF
W	WASTE
WCO	WALL CLEAN OUT
WSFU	WATER SUPPLY FIXTURE UNIT

PLUMBING LEGEND

D	CAP
	BEND 45 DEG
B	BEND 90 DEG
	TEE REDUCING
	TEE
	CLEAN TWO-WAY
	WYE 45 DEG
	WYE 45 DEG DOUBLE
	WYE COMBINATION
	P-TRAP

PIPE SCHEDULE				
MATERIAL	DIAMETER	LENGTH		
ACRYLONITRILE BUTADIENE STYRENE (ABS)	1 1/2"	31 FT		
ACRYLONITRILE BUTADIENE STYRENE (ABS)	2"	14 FT		
ACRYLONITRILE BUTADIENE STYRENE (ABS)	3"	42 FT		
CROSS-LINKED POLYETHYLENE (PEX)	1/2"	84 FT		
CROSS-LINKED POLYETHYLENE (PEX)	3/4"	27 FT		
CROSS-LINKED POLYETHYLENE (PEX)	1"	0 FT		
POLYVINYL CHLORIDE - RIGID	2"	81 FT		

	ITTING SCHEDULE	071
FITTING	SIZE	QTY
DOMESTIC COLD WATER		
PEX 90 DEGREE ELBOW	1/2"ø-1/2"ø	13
PEX 90 DEGREE ELBOW	3/4"ø-3/4"ø	2
PEX CROSS ELBOW	1/2"ø-1/2"ø-1/2"ø	1
PEX TEE ELBOW	1"ø-1"ø	1
PEX TEE ELBOW	1/2"ø-1/2"ø-1/2"ø	3
PEX TEE ELBOW	3/4"ø-3/4"ø-3/4"ø	1
PEX TRANSITION ELBOW	1"ø-1/2"ø	2
PEX TRANSITION ELBOW	1"ø-3/4"ø	5
PEX TRANSITION ELBOW	3/4"ø-1/2"ø	6
DOMESTIC HOT WATER PEX 90 DEGREE ELBOW	1/2"ø-1/2"ø	13
PEX 90 DEGREE ELBOW PEX 90 DEGREE ELBOW	3/4"ø-3/4"ø	2
PEX TEE ELBOW	1/2"ø-1/2"ø	
PEX TEE ELBOW PEX TEE ELBOW		3
PEX TRANSITION ELBOW	3/4"ø-3/4"ø 1"ø-1/2"ø	1
PEX TRANSITION ELBOW PEX TRANSITION ELBOW	1"ø-3/4"ø	1
PEX TRANSITION ELBOW	3/4"ø-1/2"ø	<u> </u>
PEX TRANSITION ELBOW	3/4"ø-3/4"ø	<u>5</u> 1
RAIN WATER		
	2"ø-2"ø	30
PVC 90 DEG BEND ELBOW	2"ø-2"ø	30
PVC 90 DEG BEND ELBOW SEWAGE		30
PVC 90 DEG BEND ELBOW SEWAGE ABS 90 DEGREE BEND ELBOW	2"ø-2"ø 1 1/2"ø-1 1/2"ø 2"ø-2"ø	
PVC 90 DEG BEND ELBOW SEWAGE ABS 90 DEGREE BEND ELBOW ABS 90 DEGREE BEND ELBOW	1 1/2"ø-1 1/2"ø	2
PVC 90 DEG BEND ELBOW SEWAGE ABS 90 DEGREE BEND ELBOW ABS 90 DEGREE BEND ELBOW ABS 90 DEGREE BEND ELBOW	1 1/2"ø-1 1/2"ø 2"ø-2"ø	2 1
PVC 90 DEG BEND ELBOW SEWAGE ABS 90 DEGREE BEND ELBOW ABS 90 DEGREE BEND ELBOW ABS 90 DEGREE BEND ELBOW ABS P-TRAP	1 1/2"ø-1 1/2"ø 2"ø-2"ø 3"ø-3"ø	2 1 2
PVC 90 DEG BEND ELBOW SEWAGE ABS 90 DEGREE BEND ELBOW ABS 90 DEGREE BEND ELBOW ABS 90 DEGREE BEND ELBOW ABS P-TRAP ABS P-TRAP	1 1/2"ø-1 1/2"ø 2"ø-2"ø 3"ø-3"ø 1 1/2"ø-1 1/2"ø	2 1 2 4
PVC 90 DEG BEND ELBOW SEWAGE ABS 90 DEGREE BEND ELBOW ABS 90 DEGREE BEND ELBOW ABS 90 DEGREE BEND ELBOW ABS P-TRAP ABS P-TRAP ABS REDUCER ELBOW	1 1/2"ø-1 1/2"ø 2"ø-2"ø 3"ø-3"ø 1 1/2"ø-1 1/2"ø 2"ø-2"ø	2 1 2 4 2
PVC 90 DEG BEND ELBOW SEWAGE ABS 90 DEGREE BEND ELBOW ABS 90 DEGREE BEND ELBOW ABS 90 DEGREE BEND ELBOW ABS P-TRAP ABS P-TRAP ABS REDUCER ELBOW ABS REDUCER ELBOW	1 1/2"ø-1 1/2"ø 2"ø-2"ø 3"ø-3"ø 1 1/2"ø-1 1/2"ø 2"ø-2"ø 2"ø-1 1/2"ø	2 1 2 4 2 1
SEWAGE ABS 90 DEGREE BEND ELBOW ABS P-TRAP ABS P-TRAP ABS REDUCER ELBOW ABS REDUCER ELBOW ABS TEE ELBOW	1 1/2"ø-1 1/2"ø 2"ø-2"ø 3"ø-3"ø 1 1/2"ø-1 1/2"ø 2"ø-2"ø 2"ø-2"ø 3"ø-2"ø	2 1 2 4 2 1 1
SEWAGE ABS 90 DEGREE BEND ELBOW ABS 90 DEGREE BEND ELBOW ABS 90 DEGREE BEND ELBOW ABS P-TRAP ABS P-TRAP ABS REDUCER ELBOW ABS REDUCER ELBOW ABS TEE ELBOW	1 1/2"ø-1 1/2"ø 2"ø-2"ø 3"ø-3"ø 1 1/2"ø-1 1/2"ø 2"ø-2"ø 2"ø-2"ø 2"ø-1 1/2"ø 3"ø-2"ø 1 1/2"ø-1 1/2"ø-1 1/2"ø	2 1 2 4 2 1 1 1 2
SEWAGE ABS 90 DEGREE BEND ELBOW ABS P-TRAP ABS P-TRAP ABS REDUCER ELBOW ABS REDUCER ELBOW ABS TEE ELBOW ABS TEE ELBOW ABS TEE ELBOW	1 1/2"ø-1 1/2"ø 2"ø-2"ø 3"ø-3"ø 1 1/2"ø-1 1/2"ø 2"ø-2"ø 2"ø-1 1/2"ø 3"ø-2"ø 1 1/2"ø-1 1/2"ø-1 1/2"ø 2"ø-2"ø-2"ø	2 1 2 4 2 1 1 2 1
PVC 90 DEG BEND ELBOW SEWAGE ABS 90 DEGREE BEND ELBOW ABS 90 DEGREE BEND ELBOW ABS 90 DEGREE BEND ELBOW ABS P-TRAP ABS P-TRAP ABS REDUCER ELBOW ABS REDUCER ELBOW ABS TEE ELBOW ABS TEE ELBOW ABS TEE ELBOW ABS TEE ELBOW	1 1/2"ø-1 1/2"ø 2"ø-2"ø 3"ø-3"ø 1 1/2"ø-1 1/2"ø 2"ø-2"ø 2"ø-2"ø 2"ø-1 1/2"ø 3"ø-2"ø 1 1/2"ø-1 1/2"ø-1 1/2"ø 2"ø-2"ø-2"ø-3"ø	2 1 2 4 2 1 1 2 1 2
SEWAGE ABS 90 DEGREE BEND ELBOW ABS P-TRAP ABS P-TRAP ABS REDUCER ELBOW ABS REDUCER ELBOW ABS TEE ELBOW	1 1/2"ø-1 1/2"ø 2"ø-2"ø 3"ø-3"ø 1 1/2"ø-1 1/2"ø 2"ø-2"ø 2"ø-1 1/2"ø 3"ø-2"ø 1 1/2"ø-1 1/2"ø-1 1/2"ø 2"ø-2"ø-2"ø-2"ø 3"ø-3"ø-3"ø 3"ø-3"ø-1 1/2"ø	2 1 2 4 2 1 1 2 1 2 3
RAIN WATER PVC 90 DEG BEND ELBOW SEWAGE ABS 90 DEGREE BEND ELBOW ABS 90 DEGREE BEND ELBOW ABS 90 DEGREE BEND ELBOW ABS P-TRAP ABS P-TRAP ABS REDUCER ELBOW ABS REDUCER ELBOW ABS TEE REDUCER ELBOW WASTE DOUBLE TEE	1 1/2"ø-1 1/2"ø 2"ø-2"ø 3"ø-3"ø 1 1/2"ø-1 1/2"ø 2"ø-2"ø 2"ø-1 1/2"ø 3"ø-2"ø 1 1/2"ø-1 1/2"ø-1 1/2"ø 2"ø-2"ø-2"ø 3"ø-3"ø-3"ø 3"ø-3"ø-1 1/2"ø 1 1/2"ø-1 1/2"ø	2 1 2 4 2 1 1 2 1 2 3 1
SEWAGE ABS 90 DEGREE BEND ELBOW ABS P-TRAP ABS P-TRAP ABS REDUCER ELBOW ABS REDUCER ELBOW ABS TEE BEND ABS TEE REDUCER ELBOW WASTE DOUBLE TEE	1 1/2"ø-1 1/2"ø 2"ø-2"ø 3"ø-3"ø 1 1/2"ø-1 1/2"ø 2"ø-2"ø 2"ø-1 1/2"ø 3"ø-2"ø 1 1/2"ø-1 1/2"ø-1 1/2"ø 2"ø-2"ø-2"ø 3"ø-3"ø-3"ø 3"ø-3"ø-1 1/2"ø 1 1/2"ø-1 1/2"ø	2 1 2 4 2 1 1 2 1 2 3 1
PVC 90 DEG BEND ELBOW SEWAGE ABS 90 DEGREE BEND ELBOW ABS 90 DEGREE BEND ELBOW ABS 90 DEGREE BEND ELBOW ABS P-TRAP ABS P-TRAP ABS REDUCER ELBOW ABS REDUCER ELBOW ABS TEE REDUCER ELBOW WASTE DOUBLE TEE VENT ABS 90 DEGREE BEND ELBOW ABS REDUCER ELBOW	1 1/2"ø-1 1/2"ø 2"ø-2"ø 3"ø-3"ø 1 1/2"ø-1 1/2"ø 2"ø-2"ø 2"ø-1 1/2"ø 3"ø-2"ø 1 1/2"ø-1 1/2"ø-1 1/2"ø 2"ø-2"ø-2"ø 3"ø-3"ø-3"ø 3"ø-3"ø-1 1/2"ø 1 1/2"ø-1 1/2"ø 1 1/2"ø-1 1/2"ø	2 1 2 4 2 1 1 2 1 2 3 1
SEWAGE ABS 90 DEGREE BEND ELBOW ABS 90 DEGREE BEND ELBOW ABS 90 DEGREE BEND ELBOW ABS P-TRAP ABS P-TRAP ABS REDUCER ELBOW ABS REDUCER ELBOW ABS TEE REDUCER ELBOW ABS TEE REDUCER ELBOW WASTE DOUBLE TEE VENT ABS 90 DEGREE BEND ELBOW ABS REDUCER ELBOW ABS TEE ELBOW	1 1/2"ø-1 1/2"ø 2"ø-2"ø 3"ø-3"ø 1 1/2"ø-1 1/2"ø 2"ø-2"ø 2"ø-1 1/2"ø 3"ø-2"ø 1 1/2"ø-1 1/2"ø-1 1/2"ø 2"ø-2"ø-2"ø 3"ø-3"ø-3"ø 3"ø-3"ø-1 1/2"ø 1 1/2"ø-1 1/2"ø 1 1/2"ø-1 1/2"ø 3"ø-3"ø-3"ø-3"ø	2 1 2 4 2 1 1 2 1 2 3 1
PVC 90 DEG BEND ELBOW SEWAGE ABS 90 DEGREE BEND ELBOW ABS 90 DEGREE BEND ELBOW ABS 90 DEGREE BEND ELBOW ABS P-TRAP ABS P-TRAP ABS REDUCER ELBOW ABS REDUCER ELBOW ABS TEE REDUCER ELBOW WASTE DOUBLE TEE VENT ABS 90 DEGREE BEND ELBOW ABS REDUCER ELBOW	1 1/2"ø-1 1/2"ø 2"ø-2"ø 3"ø-3"ø 1 1/2"ø-1 1/2"ø 2"ø-2"ø 2"ø-1 1/2"ø 3"ø-2"ø 1 1/2"ø-1 1/2"ø-1 1/2"ø 2"ø-2"ø-2"ø 3"ø-3"ø-3"ø 3"ø-3"ø-1 1/2"ø 1 1/2"ø-1 1/2"ø 1 1/2"ø-1 1/2"ø	2 1 2 4 2 1 1 2 1 2 3 1

EARAH M	۱۸/	\ \ /	TDAD	0147	1 1\ A /	OT\/	DELL	TOT	\A/ELI	TOT	NOTEO
FAMILY	W	V	TRAP	CVV	HVV	QIY	DFU	101.	WFU	101.	NOTES
DISHWASHER	2"	1-1/2"	1-1/2"	1/2"	1/2"	1		0			DRAIN TO SEWER SEE PLANS
DRYER	N/A	N/A	N/A	N/A	N/A	1		0			
HANGING PIPES CLAMP						20		0			
KITCHEN SINK DOUBLE	2"	1-1/2"	1-1/2"	1/2"	1/2"	1		0			
SHOWER TRAY	2"	1-1/2"	1-1/2"	1/2"	1/2"	1		0			
SHOWER TRIM	-	-	-	1/2"	1/2"	1		0			
VANITY SINK	2"	1-1/2"	1-1/2"	1/2"	1/2"	1		0			
WASHER	2"	1-1/2"	2"	1/2"	1/2"	1		0			DRAINS TO GRAY WATER OR SEWER SEE PLANS
WATER CLOSET	3"	2"	3"	1/2"	1/2"	1		0			
WATER HEATER						1		0			

FIXTURE SCHEDULE						
FIXTURE	QTY	DESCRIPTION				
DISHWASHER	1	DRAIN TO SEWER SEE PLANS				
DRYER	1					
HANGING PIPES CLAMP	20					
KITCHEN SINK DOUBLE	1					
SHOWER TRAY	1					
SHOWER TRIM	1					
VANITY SINK	1					
WASHER	1	DRAINS TO GRAY WATER OR SEWER SEE PLANS				
WATER CLOSET	1					
WATER HEATER	1					

PLUMBING SCHEDULE									
FIXTURE	TRAP	WASTE	VENT	C.W	H.W				
DISHWASHER	1-1/2"	2"	1-1/2"	1/2"	1/2"				
DRYER	N/A	N/A	N/A	N/A	N/A				
KITCHEN SINK DOUBLE	1-1/2"	2"	1-1/2"	1/2"	1/2"				
SHOWER TRAY	1-1/2"	2"	1-1/2"	1/2"	1/2"				
SHOWER TRIM	-	-	-	1/2"	1/2"				
VANITY SINK	1-1/2"	2"	1-1/2"	1/2"	1/2"				
WASHER	2"	2"	1-1/2"	1/2"	1/2"				
WATER CLOSET	3"	3"	2"	1/2"	1/2"				
WATER HEATER									

WATER FIXTURE UNIT SCHEDULE								
FAMILY	TOTAL							
DISHWASHER	1		0					
DRYER	1		0					
HANGING PIPES CLAMP	20		0					
KITCHEN SINK DOUBLE	1		0					
SHOWER TRAY	1		0					
SHOWER TRIM	1		0					
VANITY SINK	1		0					
WASHER	1		0					
WATER CLOSET	1		0					
WATER HEATER	1		0					

WASTE FIXTURE UNIT SCHEDULE								
FAMILY	QTY	DFU VALUES	TOTAL					
DISHWASHER	1	0						
DRYER	1	0						
HANGING PIPES CLAMP 20 0								
KITCHEN SINK DOUBLE	1	0						
SHOWER TRAY	1	0						
SHOWER TRIM	1 0							
VANITY SINK	1	0						
WASHER	1	0						
WATER CLOSET	1	0						
WATER HEATER	1	0						

ACCESSORIES & FITTINGS SCHEDULE							
FIXTURE QTY DESCRIPTIONS							
DISHWASHER CONNECTOR	1						
HOSE BIB	1						
LAUNDRY SWEAT CONNECTOR	1						
SHUTOFF VALVE	4						



Tuscon, AZ, USA 888-864-0184

KEY PLAN

DESCRIPTION DATE

NOTE:

LEGEND:

PROJECT

LA-County-800 1Bd/1Ba-550

DRAWING NAME

DRAWN BY:

CHECKED BY:

NOTE AND SCHEDULE

0386_15

Designer


Author

Checker

CLIENT NAME: PROJECT NUMBER: DATE: 4/5/2025 4:13:42 PM DESIGNED BY

P101


SCALE: 1/2" = 1'-0"

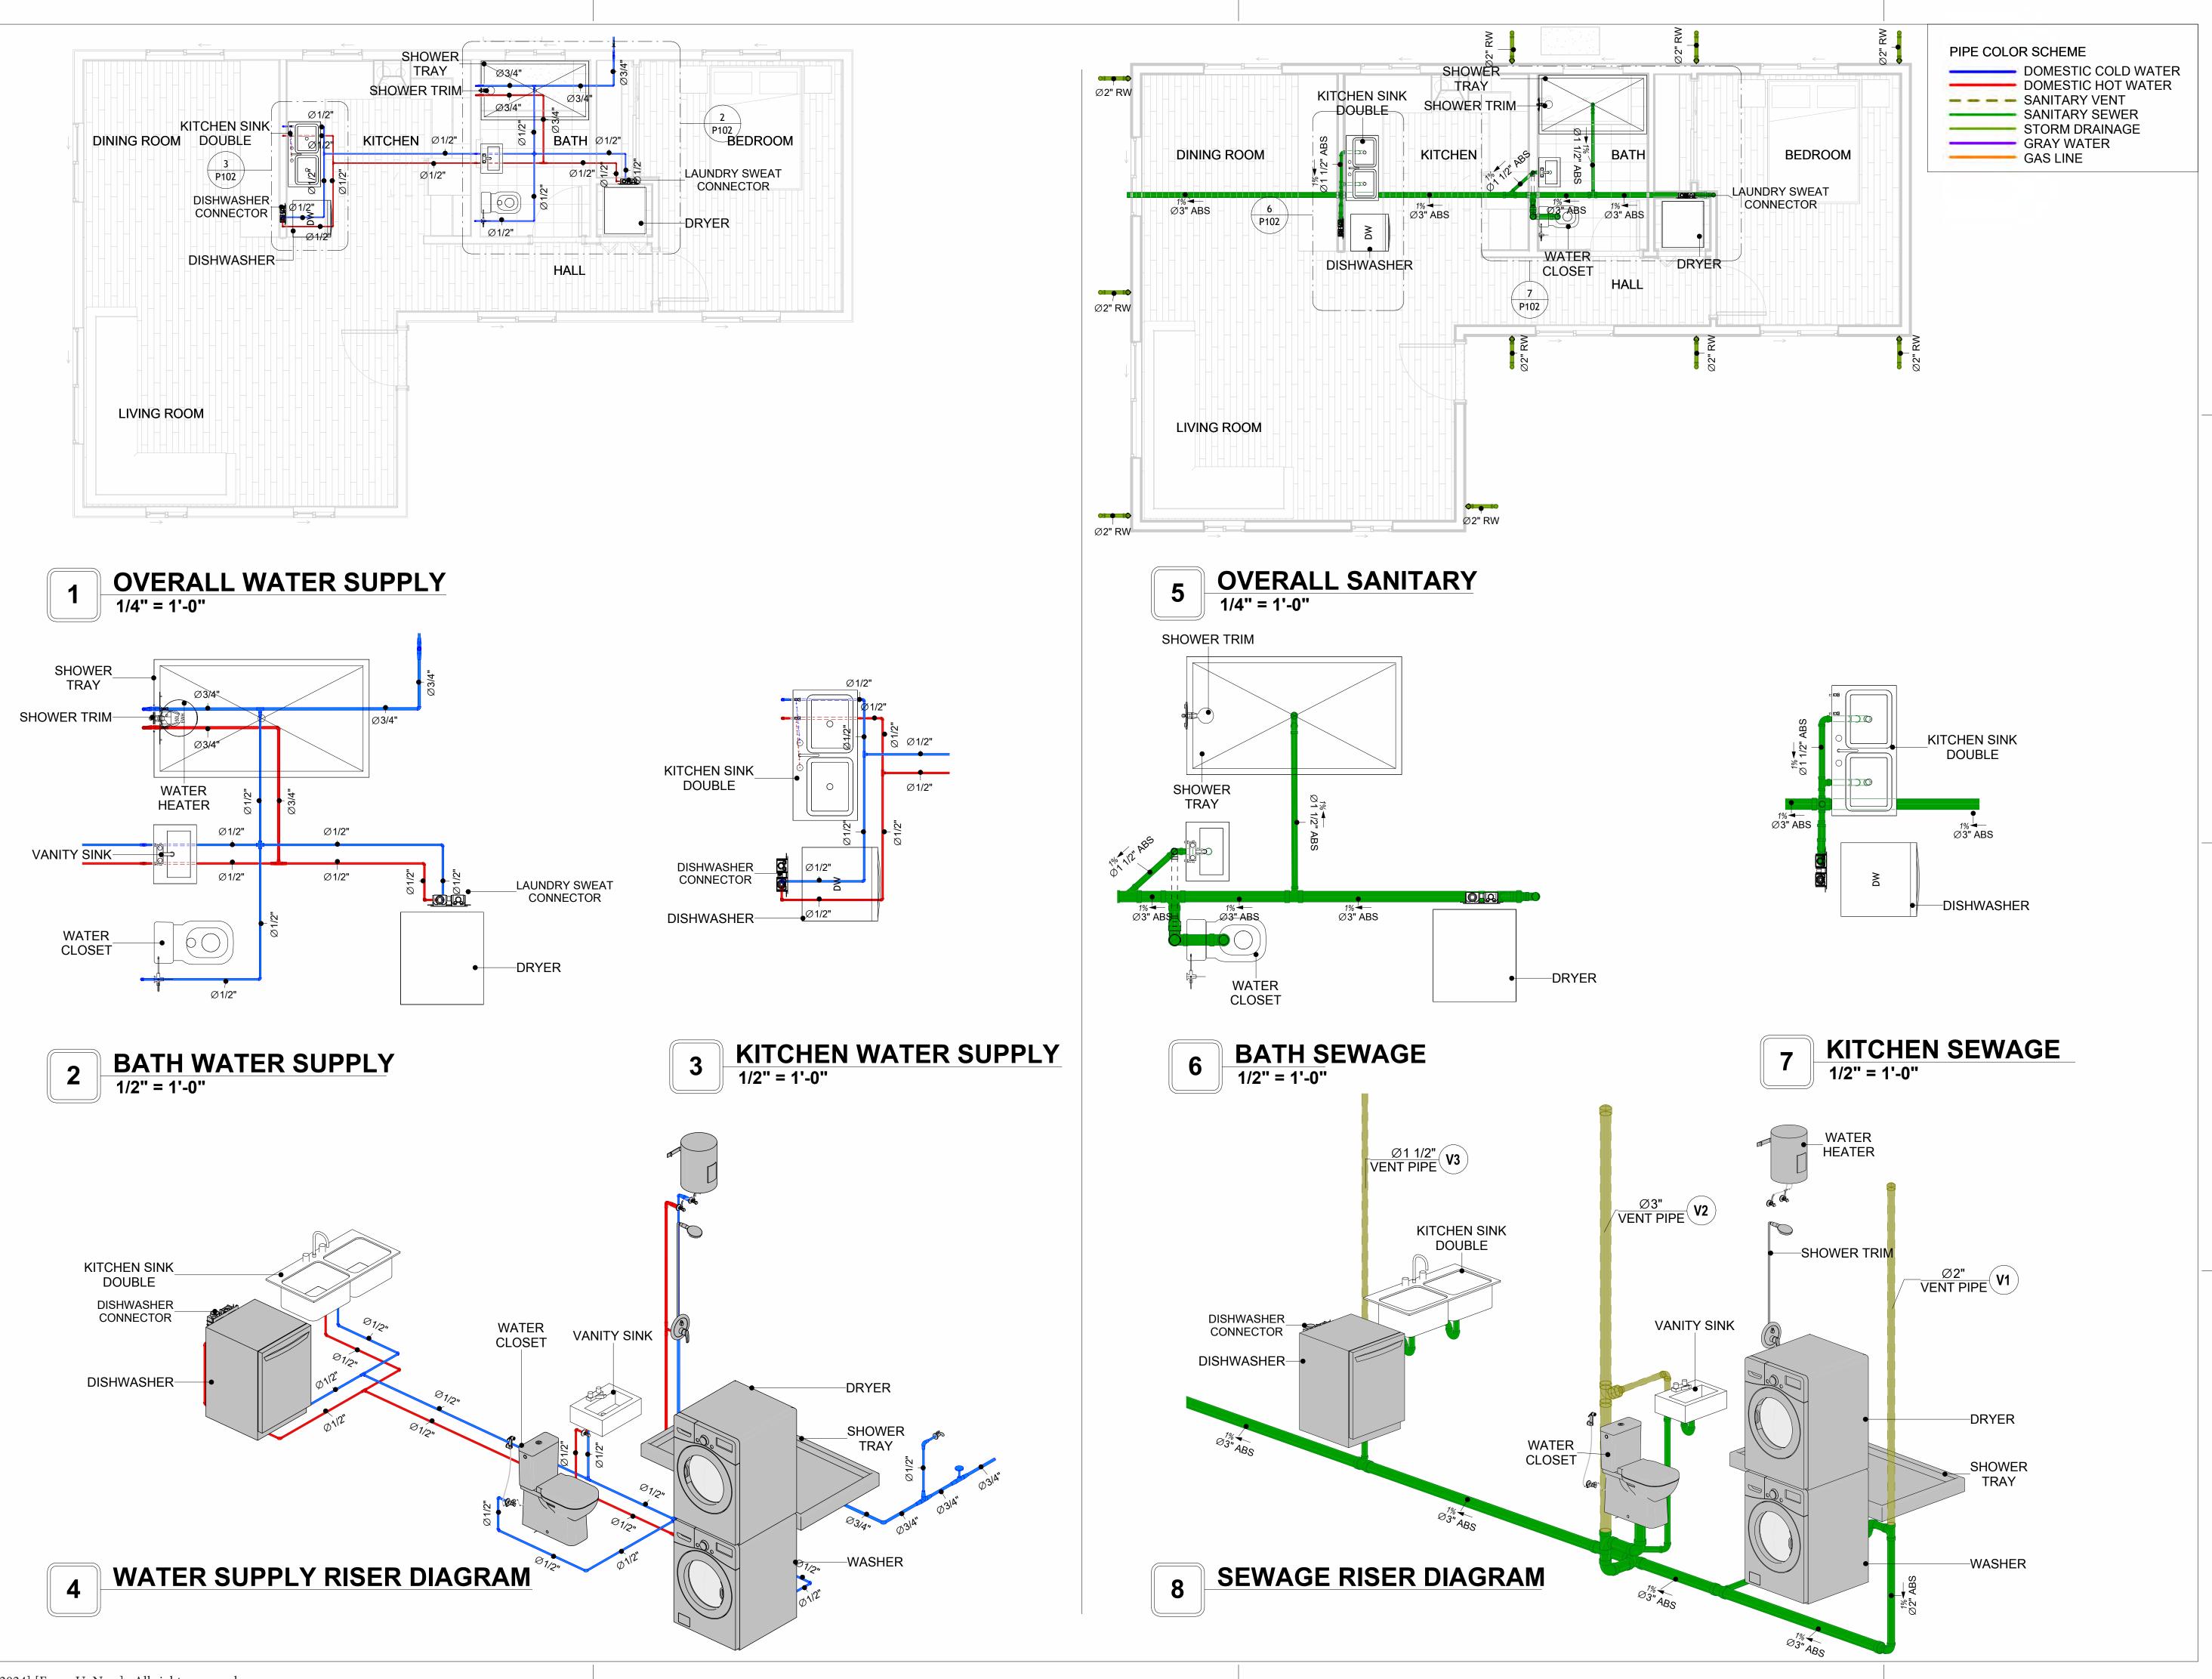



Tuscon,AZ, USA 888-864-0184

KEY PLAN

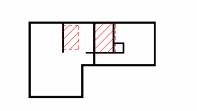

NO.	DESCRIPTION	DATE

NOTE:

LEGEND:

PROJECT

LA-County-800 1Bd/1Ba-550

DRAWING NAME

WATER SUPPLY AND SEWAGE SYSTEM

CLIENT NAME:	
PROJECT NUMBER:	0386_15
DATE:	4/5/2025 4:14:15 PM
DESIGNED BY:	Designer
DRAWN BY:	Author
CHECKED BY:	Checker

P102

SCALE: As indicated

Materials Shopping List

Please print and take this Materials Shopping List to your favorite Home Depot and ask for assistance in selecting the materials, fixtures and fittings to complete your new home.

Record your selection and the price of the item. Then do the math to determine the cost for your selections and the total cost of finishing your home.

Have It Your Way!

The material types listed in this document were selected based on personal preferences. The Customer is encouraged to make changes to the material types in accordance with local customs, regulations, and personal preferences.

Have It Your Way!



20 good reasons to frame a home with metal and not wood



Why build your ADU with metal vs wood	Wood	Metal	Explanation
1 DIY Construction Benefit		~	The wall frames, trusses and beams can be erected in a just a few days
2 Minimal Construction Skills Required		~	Pre-assembled walls and trusses require no specialized skills to errect
3 Build as DIY, Hybrid or by a General Contractor		✓	Do it yourself, Hybrid (involve special contractors) or hire a General Contractor
4 Build It As You Can Afford It		\checkmark	Impervious to Weather - build as you have the time and money
5 Up Front Cost of Framing Materials	~		As to only the framing material, wood is less expensive
6 Total Cost To Build		~	Savings in time, labor, and other areas make light gauge steel LESS expensive
7 Termites and wood boring insects		Y	Termites, carpenter ants and wood boring insects eat wood, not metal
8 Mold resistant		~	Metal does not attract mold
9 Damage caused by exterior and interior flooding		~	Metal needs no reconditioning after a flood
10 Fire Resistant		~	Non-combustible
11 Lower insurance rates		Y	Many insurance underwriters now provide lower rates for metal framed homes
12 Walls, trusses, and beams retain their original form		~	Perfectly straight walls - no shimming of drywall
13 Corners are 90 degrees		✓	No need for templating of countertops to adjust for out of square corners
14 Strength and weight		✓	Metal is stronger than wood and weighs less - no need for crane to lift ADU trusses
15 IBC Engineered Stamp		~	If an engineering stamp is necessary, months of waiting are saved
16 Complete BOM (Materials Shopping List)		~	Take the materials shopping list to Home Depot and start shopping/pricing
17 Flexible in Seismic Areas - Won't Fracture		~	Light gauge steel is flexible and won't fracture when the earth moves
18 No Waste At Job Site		~	Steel is the most recycled material in the world. A typical wood home has 20-30% waste
19 Environmentally Friendly		~	Trees don't have to be destroyed and the source of most metal is from recycling
20 How-To Videos Included		~	How-to videos provide simple assembly instructions
21 Relationship Counselor		~	Eliminate emotional uphevels - save time, money, and preserve the relationship

Universal Requirements - some or all may be required

- 1 Site plan
- 2 Electrical Supply Connection
- 3 Sewer Connection
- 4 Fresh Water Supply Connection
- 5 Set Backs
- 6 Soils Evaluation

- 7 Earthquake (fault) evaluation
- 8 Foundation Plan subject to soils
- 9 Compliance with local energy codes: insulation home wrap and flashing
- 10 Engineering for wind speed and snow load.
- 11 State and Local ordinances regarding ADUs
- 12 Local Architect and/or Engineer may be necessary







LA County 800 1Bd 1Ba MATERIAL SHOPPING LIST

Have It Your Way!

The material types listed in this document were selected based on personal preferences. The Customer is encouraged to make changes to the material types in accordance with local customs, regulations, and personal preferences. Have It Your Way!

TOC

Name



Link Page No Cover Page TOC 2

1 Cover Page 2 TOC 3 ELECTRICAL BOM **ELECTRICAL BOM** 3 5 HVAC BOM **HVAC BOM** 7 PLUMBING BOM 4 PLUMBING BOM 10 6 ARCHITECTURAL BOM ARCHITECTURAL BOM 15

Table Of Content

Have It Your Way!

The material types listed in this document were selected based on personal preferences. The Customer is encouraged to make changes to the material types in accordance with local customs, regulations, and personal preferences. Have It Your Way!

GENERAL NOTES

- 1 This BOM (Bill of Materials) is prepared as a Materials Shopping List to help builders and DIYers gain a complete understanding of most if not all elements required for the complete construction of this structure, according to the original design documents provided by FrameUpNow.
- 2 All quantities and specifications are subject to change based on the final design, field measurements, availability of products and customer preferences. The customer should verify all information prior to purchasing materials.
- 3 All products and elements in the list shall conform to the International Residential Code (IRC), or any other local and international building codes, safety regulations, and standards that are applicable to the location of the structure.
- 4 If any changes are made by the customer to the list of materials specified in this document, the customer is responsible for assuring that the correct type and quantity of materials are utilized in accordance with local building
- 5 FrameUpNow, will not be held responsible for any misuse of this document, the products listed, or for deviations from the content that are made due to changes in specifications, pricing, availability, or customer preferences.
- 6 The customer is advised to consult a qualified professional or technician prior to purchasing materials for specialized construction system items. Some items including but not limited to caseworks, doors and windows may require as built measurements prior to purchase to confirmation of final dimensions.
- If there are additional trim elements or specific installation methods, the total amount of materials needed might vary. Consider any additional trim required for corners, intersections, or other architectural details that might cause this variations before procedding to purchase and construction.

ARCHITECTURAL BOM



	LA County_800_1Bd 1Ba								
				RIAL SHOPPING LIST					
No.	Item	Type	Unit	Quantity Unit Price	Total	Description			
Δ	APPLIANCES	· · · · · · · · · · · · · · · · · · ·				·			
1	Refrigerator		PCS	1					
2	Range		PCS	1					
3	Washer		PCS	1					
4	Dryer		PCS	1					
5	Dish Washer		PCS	1					
6	Oven		PCS	0					
7	Microwave		PCS	0					
Δ	CASEWORKS								
1	Kitchen Cabinet		FT	34.3					
2	Laundry Cabinet		FT	2.25					
3	Vanity Cabinet		FT	3.08					
4	Medicine Cabinet		PCS	1					
5	Kitchen countertop		SF	62.98					
6	Laundry Countertop		PCS	0					
7	Bathroom Countertop		SF	0					
8	Island		FT	0					
9	Peninsula		FT	0					
10	Closets		SF	41.46					
△	CEILING								
1	Ceiling Board	Dry Wall	SF	655					
2	Dry Wall Fastener	Screw	PCS	1146					
3	Vapor Retarder	Polyethylene film	SF	711					
4	Vapor Retarder Fastener	Nails with washer heads	PCS	2133					
5	Ceiling Board (MRD)	Moisture resistant drywall	SF	56					
6	MRD Fastener		PCS	98					
7	Ceiling Board	Marine Plywood	SF	0					
8	Marine Plywood Fastener	Screw	PCS	0					
9	Dry Wall Tape		FT	356					
	FLOORING								
1	Main Living Space		SF	501.87					
2	Bathroom		SF	52.43					
3	Bedroom		SF	156.04					
<u></u>	STRUCTURE		los l						
1	Foundation		SF	752.2					
_	WALLS EXTERIOR		los I						
	External Stone		SF	0					
2	Stucco Finish		SF	1003					
3	Wall Shteathing (OSB)	Call delling and (4007.11)	SF	1003					
4	Shteathing Fastener	Self-drilling screws(100/pkt)	PKT	10.03					
5	Wall Homewrap	Ctanlad factor == (200/=1-t)	SF	1003.0					
6	Homewrap Fastener	Stapled fastener (200/pkt)	PKT	3.8					
7	Wall Paint	Macanny atons	SF	1003					
8	Stone Copping	Masonry stone	SF	0					
9	Stone Veneer	Masonry stone	SF	0					
10	Mortar for Stone Veneer		SF	0					
	Wall Insulation		SF	1529					
	WALLS INTERIOR Competitions Region Regard		SF	349	I				
	Cementitious Backer Board Kerdi membrane		SF	349					
3	Kerdi membrane Fastener		SF	349					
	Wall Ceramic Tile		SF	349					
4			SF						
5	Drywall Board	Solf drilling serous (100/pld)		1260					
6 7	Drywall Fastener Wall Paint	Self-drilling screws(100/pkt)	PKT	12.6					
			SF	1260					
	Drywall Tape Wall Sweep		FT FT	236 183					
7	wan Sweep		1-1	103					

ARCHITECTURAL BOM



Δ	DOORS				
1	Interior Swinging	3' - 0" X 6'-8"	PCS	2	
2	Interior Swinging	2' - 8" X 6'-8"	PCS	1	
3	Interior Sliding	5' - 4" X 6'-8"	PCS	1	
4	Interior Bifold	2' - 8" X 6'-8"	FT	16.34	
5	Exterior Door Trim	2 0 7 0 0	FT	217.44	
6	Interior Door Trim		PCS	1	
7	Entry Lock set		PCS	2	
8	Privacy Lock set		PCS	2	
9	Passage Lock set		1 63	2	
	WINDOWS				
1	Sliding	3' - 3" X 2'-3"	PCS	2	
2	Sliding	2' - 3" X 3'-3"	PCS	2	
3	Sliding	4' - 3" X 4'-3"	PCS	5	
4	Sliding	6' - 3" X 4'-3"	PCS	1	
5	Exterior Window Trim	0 - 3 X 4 - 3	FT	140	
6	Interior Window Trim		FT	140	
	ROOF		FI	140	
1	Roof Covering		SF	1081.0	
2	Roof Covering Fastener		PCS	541	
-			SF		
3	Roof Felt Paper		PCS	1081.0 3243.0	
_	Roof Felt Paper Fastener		SF		
5	Roof Sheathing		-	1081	
6	Roof Sheathing Fastener		PCS FT	8648	
7	Batten			536.0	
8	Batten Fastener		PCS	403.0	
9	Soffit		SF	138.0	
10	Soffit Fastener		PCS	69.0	
11	Fascia		FT	151.0	
	Fascia board fastener		PCS	76	
13	Roof Insulation		SF	1081.0	



		LA County_8	00_1Bd 1E	Ва			
	FI	ECTRICAL MATER	ΙΔΙ SHΩΡ	PING LI	T2		
No.	Item	Type	Unit	-	Unit Price	Total	Description
_	LIGHTING FIXTURES	Турс	Offit	Quartity	OTHER FIGE	Total	Description
1	Kitchen Ceiling Light		IPCS	4			
_	Kitchen Wall Mounted Light		PCS	0			
3	Exterior Wall Mounted Light		PCS	2			
4	Livingroom Ceiling Light With Fan		PCS	1			
5	Bedroom Ceiling Light With Fan		PCS	1			
6	Dining Ceiling Light		PCS	4			
7	Bath Wall Mounted Light		PCS	1			
	.,		PCS	1			
	Bathroom Ceiling Light		PCS				
	Livingroom Ceiling Light		PCS	4			
	Bedroom Ceiling Light		PCS	4			
	Hall & Entry Ceiling Light			3			
	Closet Ceiling Light		PCS	0			
13	Smoke Detector		PCS	2			
	ELECTRICAL FITTINGS						
	Standard Receptacle 120V	20A	PCS	16			
15	GFCI Receptacle 120V	20 A	PCS	19			
16		30 A	PCS	3			
17	GFCI Receptacle 240V	50 A	PCS	1			
18		60 A	PCS	1			
19	Fan Switch		PCS	3			
20	Single Pole Switch		PCS	9			
21	Three Way Switch		PCS	4			
	Dimmer Switch		PCS	0			
	ELECTRICAL CONDUITS & WIRING						
23	ROMEX 14 AWG	14/3/W/ground	FT	0			
	ROMEX 12 AWG	12/2/W/ground	FT	393			
	ROMEX 10 AWG	10/3/W/ground	FT	63			
	Romex 8 AWG	8/3/W/ground	FT	10			
	ROMEX 6 AWG	6/3/W/ground	FT	16			
	Bare Copper Ground Wire 6 AWG	o/ o/ tt/ ground	FT	0			
<u></u>	ELECTRICAL BOXES & CIRCUTES		''				
	Panelboard -240V 1 Phase MLO	200 AMP	PCS	1			
	Circuit breaker	15 A	PCS	0			
	Circuit breaker	20 A	PCS	12			
_			PCS				
	Circuit breaker	30 A	PCS	3			
	Circuit breaker	50 A		1			
	Circuit breaker	60 A	PCS	1			
	Single Gang Switch Box		PCS	7			
	Double Gang Switch Box		PCS	1			
	Triple Gang Switch Box		PCS	2			
	Pull Box	#1/4	PCS	22			
39	Receptacle Box		PCS	40			



LA County_800_1Bd 1Ba PLUMBING SYSTEM MATERIAL SHOPPING LIST

		PLUMBING SYSTEM N	MAILKIAL	SHUPPII	NG LIST		
No.	Item	Туре	Unit	Quantity	Unit Price	Total	Description
Δ	PLUMBING FIXTURES & ACCESSORIES						
1	Bath Tub (Alcove Tub)		PCS	0			
2	Kitchen Sink		PCS	1			
3	Kitchen Faucets		PCS	1			
4	Vanity Sink		PCS	1			
5	Bath room Faucets		PCS	1			
6	Water Closet		PCS	1			
7	Shower Trim		PCS	1			
8	Shower Tray		PCS	1			
9	Water Heater		PCS	1			
	Hose Bib		PCS	1			
	Shutoff Valve		PCS	6			
	Hanging pipe clamp		PCS	19			
	Gate Valve		PCS	19			
	Dishwasher Supply Single Connector		PCS				
			PCS	1			
	Dishwasher Sewage Single Connector			1			
	Laundry Sweat Connector		PCS	1			
<u> </u>	SANITARY & PLUMBING PIPES	4.0	FT		1		
	ABS (Acrylonitrile Butadiene Styrene) Pipes	Ø 1"	FT	0			
	ABS (Acrylonitrile Butadiene Styrene) Pipes	ø 1 1/2"	FT	31			
	ABS (Acrylonitrile Butadiene Styrene) Pipes	ø 2"	FT	14			
	ABS (Acrylonitrile Butadiene Styrene) Pipes	ø 3"	FT	42			
	PEX (Cross-linked polyethylene) Pipes	ø 1/2"	FT	84			
	PEX (Cross-linked polyethylene) Pipes	ø 3/4"	FT	27			
	PEX (Cross-linked polyethylene) Pipes	ø 1"	FT	0			
8	PVC Pipes Sch.80 - Rigid	ø 1 1/2"	FT	0			
9	PVC Pipes Sch.80 - Rigid	ø 2"	FT	81			
10	PVC Pipes Sch.80 - Rigid	ø 3"	FT	0			
11	Flex Pipe Round	ø 1/2"	PCS	6			
Δ	PIPE FITTINGS						
1	ABS 90 Degree Bend Elbow	1 1/2"ø-1 1/2"ø	PCS	3			
2	ABS 90 Degree Bend Elbow	2"ø-2"ø	PCS	1			
3	ABS 90 Degree Bend Elbow	3"ø-3"ø	PCS	2			
4	ABS P-Trap	1 1/2"ø-1 1/2"ø	PCS	4			
	ABS P-Trap	2"ø-2"ø	PCS	2			
6	ABS Reducer Elbow	2"ø-1 1/2"ø	PCS	1			
7	ABS Reducer Elbow	3"ø-1 1/2"ø	PCS	1			
	ABS Reducer Elbow	3"ø-2"ø	PCS	1			
9	ABS TEE Elbow	1 1/2"ø-1 1/2"ø-1 1/2"ø	PCS	2			
	ABS TEE Elbow	2"ø-2"ø-2"ø	PCS	1			
	ABS TEE Elbow	3"ø-3"ø-3"ø	PCS	3			
	ABS Tee Reducer Elbow	3"ø-3"ø-1 1/2"ø	PCS	3			
			_				
	ABS Vent Cap Elbow	1 1/2"ø	PCS	1			
	ABS Vent Cap Elbow	2"ø	PCS	1			
	ABS Vent Cap Elbow	3"ø	PCS	1			
	PEX 90 Degree Elbow	1/2"ø-1/2"ø	PCS	26			
	PEX 90 Degree Elbow	3/4"ø-3/4"ø	PCS	4			
	PEX Cross Elbow	1/2"ø-1/2"ø-1/2"ø	PCS	1			
	PEX Tee Elbow	1"ø-1"ø-1"ø	PCS	1			
	PEX Tee Elbow	1/2"ø-1/2"ø-1/2"ø	PCS	6			
21	PEX Tee Elbow	3/4"ø-3/4"ø-3/4"ø	PCS	2			
22	PEX Transition Elbow	1"ø-1/2"ø	PCS	3			
23	PEX Transition Elbow	1"ø-3/4"ø	PCS	6			
	PEX Transition Elbow	3/4"ø-1/2"ø	PCS	11			
	PEX Transition Elbow	3/4"ø-3/4"ø	PCS	1			
	PVC 90 Deg Bend Elbow	2"ø-2"ø	PCS	30			
	WASTE DOUBLE TEE	1 1/2"ø-1 1/2"ø-1 1/2"ø-1	PCS	1			

		LA County	/_800_1	Bd 1Ba			
		HVAC SYSTEM MA	TERIAL	SHOPP	ING LIST		
No.	Item	Туре	Unit	Quantity	Unit Price	Total	Description
	HVAC_DUCTS						
1	PIPE (REFRIGERANT LINE)	1/4" (Ø)	FT	17.07			
2	PIPE (REFRIGERANT LINE)	3/8" (Ø)	FT	42.45			
3	PIPE (REFRIGERANT LINE)	1/2" (Ø)	FT	17.22			
4	PIPE (REFRIGERANT LINE)	3/4''' (Ø)	FT	59.79			
5	DRAYER HOSE	4" (Ø)	FT	5.8			
6	FLEX DUCT ROUND	4" (Ø)	FT	6.3			
\Box	DUCT FITTINGS & ACCESSORIES						
7	ELBOW (REFRIGERANT LINE)	1/2" (Ø)-1/2" (Ø)	PCS	3			
8	ELBOW (REFRIGERANT LINE)	1/4" (Ø)-1/4" (Ø)	PCS	5			
9	ELBOW (REFRIGERANT LINE)	3/4" (Ø)-3/4" (Ø)	PCS	15			
10	ELBOW (REFRIGERANT LINE)	3/8" (Ø)-3/8" (Ø)	PCS	9			
11	TEE (REFRIGERANT LINE)	3/4" (Ø)-3/4" (Ø)-3/4" (Ø)	PCS	1			
12	TEE (REFRIGERANT LINE)	3/8" (Ø)-3/8" (Ø)-3/8" (Ø)	PCS	1			
13	TRANSITION (REFRIGERANT	3/4" (Ø)-1/2" (Ø)	PCS	3			
14	TRANSITION (REFRIGERANT	3/4" (Ø)-5/8" (Ø)	PCS	2			
15	TRANSITION (REFRIGERANT	3/8" (Ø)-1/4" (Ø)	PCS	1			
	HVAC_EQUIPMENTS						
16	AIR HANDLING UNIT	WALL MOUNTED	PCS	2			
17	CONDENSER	OUTDOOR UNIT	PCS	1			
18	EXHAUST FAN	75 CFM	PCS	1			
19	EXHAUST HOOD	WALL MOUNTED	PCS	1			
20	HOOD-WALL: VENT	HOOD-WALL: VENT	PCS	1			
21	DRAYER: VENT	DRAYER: VENT	PCS	1			
22	ROOF VENT	3"(Ø)	PCS	1			



Table Of Content

#	Name	Link	Page No
1	Cover Page	Cover Page	1
2	TOC	TOC	2
3	ELECTRICAL BOM	ELECTRICAL BOM	3
5	HVAC BOM	HVAC BOM	7
4	PLUMBING BOM	PLUMBING BOM	10
6	ARCHITECTURAL BOM	ARCHITECTURAL BOM_	15

Have It Your Way!

The material types listed in this document were selected based on personal preferences. The Customer is encouraged to make changes to the material types in accordance with local customs, regulations, and personal preferences. Have It Your Way!

GENERAL NOTES

- 1 This BOM (Bill of Materials) is prepared as a Materials Shopping List to help builders and DIYers gain a complete understanding of most if not all elements required for the complete construction of this structure, according to the original design documents provided by FrameUpNow.
- ² All quantities and specifications are subject to change based on the final design, field measurements, availability of products and customer preferences. The customer should verify all information prior to purchasing materials.
- 3 All products and elements in the list shall conform to the International Residential Code (IRC), or any other local and international building codes, safety regulations, and standards that are applicable to the location of the structure.
- 4 If any changes are made by the customer to the list of materials specified in this document, the customer is responsible for assuring that the correct type and quantity of materials are utilized in accordance with local building codes.
- FrameUpNow, will not be held responsible for any misuse of this document, the products listed, or for deviations from the content that are made due to changes in specifications, pricing, availability, or customer preferences.
- The customer is advised to consult a qualified professional or technician prior to purchasing materials for specialized construction system items. Some items including but not limited to caseworks, doors and windows may require as built measurements prior to purchase to confirmation of final dimensions.
- 7 If there are additional trim elements or specific installation methods, the total amount of materials needed might vary. Consider any additional trim required for corners, intersections, or other architectural details that might cause this variations before procedding to purchase and construction.



			LIGHTING FIXTURES				
#	Item	Туре	Description, Manufacturer, SKU	Unit	Quantity	Unit Price	Total
1	Kitchen Ceiling Light			PCS	4		
3	Kitchen Wall Mounted Light			PCS	0		
4	Exterior Wall Mounted Light			PCS	2		
5	Livingroom Ceiling Light With Fan			PCS	1		
6	Bedroom Ceiling Light With Fan			PCS	1		
7	Dining Ceiling Light			PCS	4		
8	Bath Wall Mounted Light			PCS	1		
9	Bathroom Ceiling Light			PCS	1		
10	Livingroom Ceiling Light			PCS	4		
11	Bedroom Ceiling Light			PCS	4		
12	Hall & Entry Ceiling Light			PCS	3		
12	Closet Ceiling Light			PCS	0		
13	Smoke Detector			PCS	2		
14							
15							



			ELECTRICAL FITTINGS			
#	Item	Туре	Description, Manufacturer, SKU	Unit	Quantity Unit P	rice Total
1	Standard Receptacle 120V	20A		PCS	16	
2	GFCI Receptacle 120V	20 A		PCS	19	
3	GFCI Receptacle 240V	30 A		PCS	3	
4	GFCI Receptacle 240V	50 A		PCS	1	
5	GFCI Receptacle 240V	60 A		PCS	1	
6	Fan Switch			PCS	3	
7	Single Pole Switch			PCS	9	
8	Three Way Switch			PCS	4	
9	Dimmer Switch			PCS	0	
10						
11						
12						
13						
14						
15						



		ELECTR	ICAL CONDUITS & WIRING				
#	Item	Туре	Description, Manufacturer, SKU	Unit	Quantity	Unit Price	Total
1	ROMEX 14 AWG	14/3/W/ground		FT	0		
3	ROMEX 12 AWG	12/2/W/ground		FT	393		
4	ROMEX 10 AWG	10/3/W/ground		FT	63		
6	Romex 8 AWG	8/3/W/ground		FT	10		
8	ROMEX 6 AWG	6/3/W/ground		FT	16		
9	Bare Copper Ground Wire 6 AWG			FT			



		ELEC	TRICAL BOXES & CIRCUTES				
#	Item	Туре	Description, Manufacturer, SKU	Unit	Quantity	Unit Price	Total
1	Panelboard -240V 1 Phase MLO	200 AMP		PCS	1		
2	Circuit breaker	15 A		PCS	0		
3	Circuit breaker	20 A		PCS	12		
4	Circuit breaker	30 A		PCS	3		
5	Circuit breaker	50 A		PCS	1		
6	Circuit breaker	60 A		PCS	1		
7	Single Gang Switch Box			PCS	7		
8	Double Gang Switch Box			PCS	1		
9	Triple Gang Switch Box			PCS	2		
10	Pull Box	#1/4		PCS	22		
11	Receptacle Box			PCS	40		
12							
13							
14							
15							

			HVAC_DUCTS 01				
#	Item	Туре	Description, Manufacturer, SKU	Unit	Quantity	Unit Price	Total
1	PIPE (REFRIGERANT LINE)	1/4" (Ø)		FT	17.07		
2	PIPE (REFRIGERANT LINE)	3/8" (Ø)		FT	42.45		
3	PIPE (REFRIGERANT LINE)	1/2" (Ø)		FT	17.22		
4	PIPE (REFRIGERANT LINE)	3/4"' (Ø)		FT	59.79		
5	DRAYER HOSE	4" (Ø)		FT	5.8		
6	FLEX DUCT ROUND	4" (Ø)		FT	6.3		
7							
8							
9							
10							
11							
12							
13							
14							
15							
16							

			DUCT FITTINGS & ACCESSORIES				
#	Item	Туре	Description, Manufacturer, SKU	Unit	Quantity	Unit Price	Total
1	ELBOW (REFRIGERANT LINE)	1/2" (Ø)-1/2" (Ø)		PCS	3		
2	ELBOW (REFRIGERANT LINE)	1/4" (Ø)-1/4" (Ø)		PCS	5		
3	ELBOW (REFRIGERANT LINE)	3/4" (Ø)-3/4" (Ø)		PCS	15		
4	ELBOW (REFRIGERANT LINE)	3/8" (Ø)-3/8" (Ø)		PCS	9		
5	TEE (REFRIGERANT LINE)	3/4" (Ø)-3/4" (Ø)-3/4" (Ø)		PCS	1		
6	TEE (REFRIGERANT LINE)	3/8" (Ø)-3/8" (Ø)-3/8" (Ø)		PCS	1		
7	TRANSITION (REFRIGERANT LINE)	3/4" (Ø)-1/2" (Ø)		PCS	3		
8	TRANSITION (REFRIGERANT LINE)	3/4" (Ø)-5/8" (Ø)		PCS	2		
9	TRANSITION (REFRIGERANT LINE)	3/8" (Ø)-1/4" (Ø)		PCS	1		
10	(TETTUGE OUT EITE)						
11							
12							
13							
14							
15							
16							

			HVAC_EQUIPMENTS				
#	Item	Туре	Description, Manufacturer, SKU	Unit	Quantity	Unit Price	Total
1	AIR HANDLING UNIT	WALL MOUNTED		PCS	2		
2	CONDENSER	OUTDOOR UNIT		PCS	1		
3	EXHAUST FAN	75 CFM		PCS	1		
4	EXHAUST HOOD	WALL MOUNTED		PCS	1		
5	HOOD-WALL: VENT	HOOD-WALL: VENT		PCS	1		
6	DRAYER: VENT	DRAYER: VENT		PCS	1		
7	ROOF VENT	3"(Ø)		PCS	1		
8							
9							
10							
11							
12							
13							
14							



		PLUMBIN	NG FIXTURES & ACCESSORIES				
#	Item	Туре	Description, Manufacturer, SKU	Unit	Quantity	Unit Price	Total
1	Bath Tub (Alcove Tub)			PCS	C		
2	Kitchen Sink Double			PCS	1		
3	Kitchen faucets			PCS	1		
4	Vanity Sink			PCS	1		
5	Bath room faucets			PCS	1		
6	Water Closet			PCS	1		
7	Shower Trim			PCS	1		
8	Shower Tray			PCS	1		
9	Water Heater			PCS	1		
10	Hose Bib			PCS	1		
11	Shutoff Valve			PCS	6		
12	Hanging pipe clamp			PCS	20		
13	Gate Valve			PCS	1		
14	Dishwasher Supply Single Connector			PCS	1		
15	Dishwasher Sewage Single Connector			PCS	1		
16	Laundry Sweat Connector			PCS	1		



		SANI	TARY & PLUMBING PIPES				
#	Item	Туре	Description, Manufacturer, SKU	Unit	Quantity	Unit Price	Total
1	ABS (Acrylonitrile Butadiene Styrene) Pipes	ø 1"		FT	0		
2	ABS (Acrylonitrile Butadiene Styrene) Pipes	ø 1 1/2"		FT	31		
3	ABS (Acrylonitrile Butadiene Styrene) Pipes	ø 2"		FT	14		
4	ABS (Acrylonitrile Butadiene Styrene) Pipes	ø 3"		FT	42		
5	PEX (Cross-linked polyethylene) Pipes	ø 1/2"		FT	84		
6	PEX (Cross-linked polyethylene) Pipes	ø 3/4"		FT	27		
7	PEX (Cross-linked polyethylene) Pipes	ø 1"		FT	0		
8	PVC Pipes Sch.80 - Rigid	ø 1 1/2"		FT	0		
9	PVC Pipes Sch.80 - Rigid	ø 2"		FT	81		
10	PVC Pipes Sch.80 - Rigid	ø 3"		FT	0		
11	Flex Pipe Round	ø 1/2"		PCS	6		
12							
13							
14							
15							



		PIPE	FITTINGS 01				
ŧ	Item	Туре	Description, Manufacturer, SKU	Unit	Quantity	Unit Price	Total
	ABS 90 Degree Bend Elbow	1 1/2"ø-1 1/2"ø		PCS	3		
	ABS 90 Degree Bend Elbow	2"ø-2"ø		PCS	1		
	ABS 90 Degree Bend Elbow	3"ø-3"ø		PCS	2		
	ABS P-Trap	1 1/2"ø-1 1/2"ø		PCS	4		
	ABS P-Trap	2"ø-2"ø		PCS	2		
)	ABS Reducer Elbow	2"ø-1 1/2"ø		PCS	1		
	ABS Reducer Elbow	3"ø-1 1/2"ø		PCS	1		
	ABS Reducer Elbow	3"ø-2"ø		PCS	1		
	ABS TEE Elbow	1 1/2"ø-1 1/2"ø-1 1/2"ø		PCS	2		
0	ABS TEE Elbow	2"ø-2"ø-2"ø		PCS	1		
1	ABS TEE Elbow	3"ø-3"ø-3"ø		PCS	3		
2	ABS Tee Reducer Elbow	3"ø-3"ø-1 1/2"ø		PCS	3		
3	ABS Vent Cap Elbow	1 1/2"ø		PCS	1		
4	ABS Vent Cap Elbow	2"ø		PCS	1		
5	ABS Vent Cap Elbow	3"ø		PCS	1		



				ITTINGS 02	PIPE FI		
Total	Unit Price	Quantity	Unit	Description, Manufacturer, SKU	Туре	Item	#
		26	PCS		1/2"ø-1/2"ø	PEX 90 Degree Elbow	1
		4	PCS		3/4"ø-3/4"ø	PEX 90 Degree Elbow	2
		1	PCS		1/2"ø-1/2"ø-1/2"ø	PEX Cross Elbow	3
		1	PCS		1"ø-1"ø-1"ø	PEX Tee Elbow	4
		6	PCS		1/2"ø-1/2"ø-1/2"ø	PEX Tee Elbow	5
		2	PCS		3/4"ø-3/4"ø-3/4"ø	PEX Tee Elbow	6
		3	PCS		1"ø-1/2"ø	PEX Transition Elbow	7
		6	PCS		1"ø-3/4"ø	PEX Transition Elbow	8
		11	PCS		3/4"ø-1/2"ø	PEX Transition Elbow	9
		1	PCS		3/4"ø-3/4"ø	PEX Transition Elbow	10
		30	PCS		2"ø-2"ø	PVC 90 Deg Bend Elbow	11
		1	PCS		1 1/2"ø-1 1/2"ø-1 1/2"ø-1 1/2"ø	WASTE DOUBLE TEE	12
							13
							14
		+					15
							12 13 14



			APPLIANCES				
#	Item	Туре	Description, Manufacturer, SKU	Unit	Quantity	Unit Price	Total
1	Refrigerator			PCS	1		
2	Range			PCS	1		
3	Washer Front Load	Stackable		PCS	1		
4	Dryer Front Load	Stackable		PCS	1		
5	Dish Washer			PCS	1		
6	Oven			PCS	(
7	Microwave			PCS	(
8							
9							
10							
11							
12							
13							
14							
15							
16							



			CASEWORKS 01				
#	Item	Туре	Description, Manufacturer, SKU	Unit	Quantity	Unit Price	Total
1	Kitchen Cabinet			FT	34.3		
2	Laundry Cabinet			FT	2.25		
3	Vanity Cabinet			FT	3.08		
4	Medicine Cabinet			PCS	1		
5	Kitchen countertop			SF	62.98		
6	Laundry Countertop			PCS	0		
7	Bathroom Countertop			SF	0		
8	Island			FT	0		
9	Peninsula			FT	0		
10	Closets			SF	41.46		
11							
12							
13							
14							
15							



	1		CEILING 01				
‡	Item	Туре	Description, Manufacturer, SKU	Unit	Quantity	Unit Price	Total
	LIVING ROOM + KITCHEN +	DINING		SF	448.0		
1	Ceiling Board	Drywall		SF	448		
2	Drywall Fastener	Screw		PCS	784		
3	Vapor Retarder	Polyethylene film		SF	448		
4	Vapor Retarder Fastener	Nails with washer heads		PCS	1344		
	BATH ROOM			SF	56.1		
5	Ceiling Board	MRD (Moisture resistant drywall)		SF	56		
5	MRD Fastener	Screw		PCS	98		
	BEDROOM			SF	141.0	141.0	
7	Ceiling Board	Drywall		SF	141		
8	Drywall Fastener	Screw		PCS	247		
9	Vapor Retarder	Polyethylene film		SF	141		
10	Vapor Retarder Fastener	Nails with washer heads		PCS	423		



			CEILING 02				
#	Item	Туре	Description, Manufacturer, SKU	Unit	Quantity	Unit Price	Total
	CLOSET			SF	12.3		
11	Ceiling Board	Drywall		SF	12		
12	Drywall Fastener	Screw		PCS	22		
13	Vapor Retarder	Polyethylene film		SF	12		
14	Vapor Retarder Fastener	Nails with washer heads		PCS	37		
	W/D			SF	8.4		
15	Ceiling Board	Drywall		SF	8		
16	Drywall Fastener	Screw		PCS	15		
17	Vapor Retarder	Polyethylene film		SF	8		
18	Vapor Retarder Fastener	Nails with washer heads		PCS	25		
	HALL			SF	45.4		
19	Ceiling Board	Drywall		SF	45		
20	Drywall Fastener	Screw		PCS	79		
21	Vapor Retarder	Polyethylene film		SF	45		
22	Vapor Retarder Fastener	Nails with washer heads		PCS	136		



			FLOORING INTERIOR 01				
#	Item	Туре	Description, Manufacturer, SKU	Unit	Quantity	Unit Price	Total
	CLOSET						
1	Closet Flooring			SF	13		
2	Wood underlay	Foam Pad Polyethylene		SF	13		
3	Vapor Retarder	Vapor Barrier Polyethylene		SF	13		
	BEDROOM	·					
4	Living Area Flooring			SF	143		
5	Wood underlay	Foam Pad Polyethylene		SF	143		
6	Vapor Retarder	Vapor Barrier Polyethylene		SF	143		
	LIVING ROOM AND KITCHE	EN					
7	Tile Finish			SF	502		
8	Adhesive	1/2" Thin set Mortar		SF	502		
9	Vapor Retarder	Vapor Barrier Polyethylene		SF	502		
	BATHROOM	·					
10	Tile Finish			SF	44		
11	Adhesive	1/2" Thin set Mortar		SF	44		
12	Vapor Retarder	Vapor Barrier Polyethylene		SF	44		



			FLOORING INTERIOR 02				
#	Item	Туре	Description, Manufacturer, SKU	Unit	Quantity	Unit Price	Total
	W/D						
13	Tile Finish			SF	9		
14	Adhesive	1/2" Thin set Mortar		SF	9		
15	Vapor Retarder	Vapor Barrier Polyethylene		SF	9		



			FLOORING EXTERIOR			
#	Item	Туре	Description, Manufacturer, SKU	Unit	Quantity	Unit Price
	STRUCTURE			SF	752.2	
1	Concrete Slab	4"concrete cast in situ		CF	251	
2	Insulation	Rigid insulation		SF	232	
3	Hard core	Compacted soil		CF	179.3	
4	Re-bar	#4 re-bar		Ton	0.74	
5	Concrete Pad	4"concrete cast in situ		CF	2	
6	Slab edge	Turndown		CF	210.9	
7	Footing	Cast-in-place concrete		CF	14.04	



			WALLS: EXTERIOR				
#	Item	Туре	Description, Manufacturer, SKU	Unit	Quantity	Unit Price	Total
1	External Stone			SF	0		
2	Stucco Finish			SF	1003		
3	Wall Shteathing (OSB)			SF	1003		
4	Shteathing Fastener	Self-drilling screws(100/pkt)		PKT	10.03		
5	Wall Homewrap			SF	1003.0		
6	Homewrap Fastener	Stapled fastener (200/pkt)		PKT	3.8		
7	Wall Paint			SF	1003		
8	Stone Copping	Masonry stone		SF	0		
9	Stone Veneer	Masonry stone		SF	0		
10	Mortar for Stone Veneer			SF	0		
11	Wall Insulation			SF	1529		



			WALLS: INTERIOR 01				
#	Item	Туре	Description, Manufacturer, SKU	Unit	Quantity	Unit Price	Total
	BATHROOM			SF	56.0		
1	Cementitious Backer Board			SF	219)	
2	Kerdi membrane			SF	219)	
3	Kerdi membrane Fastener			SF	219		
4	Wall Ceramic Tile			SF	219)	
	BEDROOM			SF	141.0		
5	Drywall Board			SF	285		
6	Drywall Fastener	Self-drilling screws(100/pkt)		PKT	2.85		
7	Wall Paint			SF	285		
8	Drywall Tape			FT	53.4		
	HALL			SF	51.0		
9	Drywall Board			SF	160		
10	Drywall Fastener	Self-drilling screws(100/pkt)		PKT	1.6		
11	Wall Paint			SF	160		
12	Drywall Tape			FT	30		



			WALLS: INTERIOR 02				
#	Item	Туре	Description, Manufacturer, SKU	Unit	Quantity	Unit Price	Total
	LIVING ROOM			SF	247.0		
13	Drywall Board			SF	272		
14	Drywall Fastener	Self-drilling screws(100/pkt)		PKT	2.72		
15	Wall Paint			SF	272		
16	Drywall Tape			FT	51.0		
	KITCHEN			SF	94.0		
17	Cementitious Backer Board			SF	53		
18	Drywall Board			SF	245		
19	Drywall Fastener	Self-drilling screws(100/pkt)		PKT	2.45		
20	Kerdi membrane			SF	53		
21	Kerdi membrane Fastener			SF	53		
22	Wall Ceramic Tile			SF	53		
23	Wall Paint			SF	245		
24	Drywall Tape			FT	46.2		



			WALLS: INTERIOR 03				
#	Item	Туре	Description, Manufacturer, SKU	Unit	Quantity	Unit Price	Total
	DINING			SF	101.0		
25	Drywall Board			SF	202		
26	Drywall Fastener	Self-drilling screws(100/pkt)		PKT	2.02		
27	Wall Paint			SF	202		
28	Drywall Tape			FT	37.9)	
	CL			SF	13.0		
29	Drywall Board			SF	96		
30	Drywall Fastener	Self-drilling screws(100/pkt)		PKT	0.96		
31	Wall Paint			SF	96		
32	Drywall Tape			FT	18.0		
	WD	,		SF	8.0		
33	Cementitious Backer Board			SF	77	,	
34	Kerdi membrane			SF	77	,	
35	Kerdi membrane Fastener			SF	77	,	
36	Wall Ceramic Tile			SF	77		
1	Wall Skirting	Ceramic		FT	183	}	



			DOORS				
#	Item	Туре	Description, Manufacturer, SKU	Unit	Quantity	Unit Price	Total
1	Interior Swinging	3' - 0" X 6'-8"		PCS	1		
2	Interior Swinging	2' - 8" X 6'-8"		PCS	2		
3	Interior Sliding	5' - 4" X 6'-8"		PCS	1		
4	Interior Bifold	2' - 8" X 6'-8"		PCS	1		
5	Exterior Door Trim			FT	16.34		
6	Interior Door Trim			FT	217.44		
7	Entry Lock set			PCS	1		
8	Privacy Lock set			PCS	2		
9	Passage Lock set			PCS	2		



			WINDOWS				
#	Item	Туре	Description, Manufacturer, SKU	Unit	Quantity	Unit Price	Total
1	Sliding	3' - 3" X 2'-3"		PCS	2		
2	Sliding	2' - 3" X 3'-3"		PCS	2		
3	Sliding	4' - 3" X 4'-3"		PCS	5		
4	Sliding	6' - 3" X 4'-3"		PCS	1		
5	Exterior Window Trim			FT	140		
6	Interior Window Trim			FT	140		
7							
8							
9							
10							
11							
12							
13							
14							
15							



			ROOF 01				
#	Item	Туре	Description, Manufacturer, SKU	Unit	Quantity	Unit Price	Total
1	Roof Covering			SF	1081.0		
2	Roof Covering Fastener			PCS	541		
3	Roof Felt Paper			SF	1081.0		
4	Roof Felt Paper Fastener			PCS	3243.0		
5	Roof Sheathing			SF	1081.0		
6	Roof Sheathing Fastener			PCS	8648		
7	Batten			FT	536.0		
8	Batten Fastener			PCS	403.0		
9	Soffit			SF	138.0		
10	Soffit Fastener			PCS	69.0		
11	Fascia			FT	151.0		
12	Fascia board fastener			PCS	76		
13	Roof Insulation			SF	1081.0		
14							
15							