


LA COUNTY

The LA County ADU is a three-bedroom, onebathroom ADU designed with a classic Spanish architectural style. The exterior features a lightcolored stucco finish, creating a warm and traditional aesthetic. A simple gable roof, with a shallow slope, provides shelter and complements the overall design.


Inside, this plan boasts a simple rectangular layout designed for comfortable living. The living and dining areas are merged into a single room, creating a versatile space. The bedrooms is thoughtfully located on one side of the plan, offering a private and quiet retreat. The kitchen and bathroom are strategically placed between the living area and the bedroom, creating separation and enhancing functionality.

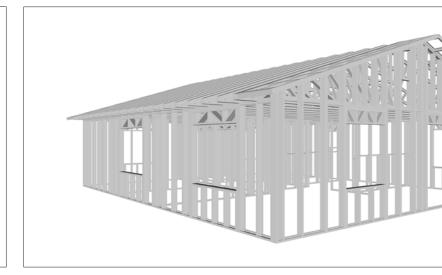

Materials Shopping List

Please print and take this Materials Shopping List to your favorite Home Depot and ask for assistance in selecting the materials, fixtures and fittings to complete your new home.

Record your selection and the price of the item. Then do the math to determine the cost for your selections and the total cost of finishing your home.

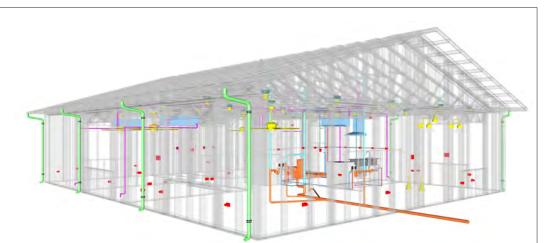

< CLICK HERE >

To Go To Materials Shopping List





FLOOR PLAN

1200 SF

3 Bed Rooms



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COVER SHEET

FLOOR PLAN + DIMENSION PLAN + FOUNDATION PLAN STRUCTURAL FLOOR PLAN -WALL FRAME LAYOUT ROOF TRUSS LAYOUT + ROOF PLAN + ARCHITECTURAL ELEVATIONS -ARCHITECTURAL ELEVATIONS -ARCHITECTURAL SECTIONS -ARCHITECTURAL DETAILS ARCHITECTURAL CASEWORK

03

COVER SHEET GENERAL NOTES WALL FRAME LAYOUT WALL PANEL & LAYOUT PLAN 19 ROOF TRUSS LAYOUT 20 21 **STRUCTURAL SECTIONS** -WALL BRACING LAYOUT 22 HOLD-DOWN PLAN **STRUCTURAL DETAILS 1 STRUCTURAL DETAILS 2 STRUCTURAL DETAILS 3 27** TRUSS BLOCKING LAYOUT 28 SHEETROCK BACKING **ROOF BRACING LAYOUT** 29

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DIMENSION FOR FITTING

MATERIALS SHOPPING LIST MATERIALS SHOPPING LIST

ABOUT



FrameUpNow is a design and manufacturing company providing precision-engineered home framing solutions. We offer a catalog of Affordable Homes, Tiny Homes, Garages, Shops and Barndominiums. FrameUpNow manufactures cold-formed steel (CFS) also known as Light Gauge Steel (LGS) framing components that conform to our engineered metal house frame plans or can be purchased as DIY skeleton kits.

The CFS/LGS framing is lightweight, easily assembled, and does not require heavy equipment or specialized labor, enabling homeowners to erect the frame themselves in just a few days. Unlike wood, the steel framing is impervious termites and bores, warping, expansion, and fire.

Our home plans come complete with a structural engineered stamp for permit approvals. Customers receive a full BOM also known as a Materials Shopping List to purchase finish materials from a Building Materials retailer. FrameUpNow prides itself on the quality and efficiency of our precision-engineered home framing solutions for construction professionals and DIY homeowners.



KEY PLAN

NO.	DESCRIPTION	DATE

NOTE:

LEGEND:

PROJECT

LA County-1200-3Bd1Ba-550

DRAWING NAME

INTRODUCTION

CLIENT NAME:
PROJECT NUMBER:
DATE:
DESIGNED BY:
DRAWN BY:
CHECKED BY:

I101

SCALE:

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DISCLAIMER: This documentation and all it's contents are the intellectual property

DISCLAIMER

DESCRIPTIONS

MATERIALS LIST

The BOM (Bill Of Materials) package, known as the Materials Shopping List document, provides:

Comprehensive Inventory: Detailed lists of essential materials sourced from architectural, mechanical, HVAC, electrical, and plumbing design drawing sets.

Precise Curation: Each item meticulously selected and organized for accuracy and efficiency in project planning.

Customizable Options: Customers can modify listed items to their preferences and calculate costs accordingly, ensuring alignment with personal project needs and budget.

Dedicated Space for Details: Includes tables for customers to note Home Depot SKU numbers or product descriptions for selected items,

facilitating seamless purchasing and coordination with suppliers.

Customer Convenience: Take the list to Home Depot or preferred suppliers for accurate pricing, helping align the total home budget with personal financial plans.

Simplify your construction journey with our Materials Shopping List document, where detailed preparation meets streamlined implementation for your dream home.

HVAC Sections and Riser Diagrams: Technical drawings offering

critical cross-sectional details and piping schematics, ensuring

proper integration of the heating and cooling system into the home's

Bill of Materials: A complete list of all necessary HVAC components.

MECHANICAL

STRUCTURAL

The structural drawings package provides an exhaustive set of detailed plans essential for the precise assembly of your building. This comprehensive package includes:

Framing Plans: Detailed layouts for all framing components. Truss Layouts: Clear instructions for truss placement and

Panel Length Plans: Specifications for panel dimensions. Framing Elevations and Sections: Precise elevation and sectional views for accurate construction.

Truss and Wall Blocking Plans: Plans for truss and wall blocking to ensure structural integrity.

Hold-Down Plan: Detailed hold-down requirements for stability. Snap Sheet: Reference sheet for quick identification of components

Structural Details and Bracing Plans: Complete details and bracing plans for all structural elements.

Accompanying these plans is a comprehensive Bill of Materials (BOM) that lists every necessary building component, from cold formed steel (CFS) frames to fasteners.

ARCHITECTURAL

With the comprehensive architectural package, both builders and DIY homeowners can confidently execute the construction.

The architectural package includes:

Furnished Floor Plans: Complete with furniture layouts for a clear understanding of space utilization.

Detailed Dimension Plans: Ensures precise measurements, from the overall footprint down to the exact placement of windows and

Foundation Plan: Detailed plan to establish a solid foundation.

Wall Framing and Truss Layout: Comprehensive plans for wall framing and truss placement.

Architectural Elevations: Exterior views showcasing the design.

Strategic Building Sections: Critical cross-sectional details for a thorough understanding of the build.

Casework Drawings and Diagrams: Suggested designs for built-in caseworks, such as kitchen cabinets.

ELECTRICAL

The mechanical package includes everything needed to guide HVAC The electrical package includes all the plans and documentation needed to guide the installation of your home's electrical system:

Detailed HVAC Floor Plan: Precisely maps out the placement of air Detailed Power Plan: Precisely maps out the placement of outlets, handlers, ductwork, and vents throughout the home's layout. switches, and other power components throughout the layout.

> Comprehensive Lighting Plan: Shows the optimal locations for lighting fixtures, sconces, and other illumination sources to create a well-lit, functional interior.

> Dimensioned Electrical Layout: Provides exact dimensions and measurements to ensure proper placement of all electrical elements.

Bill of Materials: A complete list of every component needed, from circuit breakers to wiring.

installation of your home's water supply and drainage systems:

Detailed Water Supply System Plan: Precisely maps out the placement of pipes, valves, and plumbing fixtures throughout the

and sizing of drain lines to effectively remove waste and ensure proper drainage.

Detailed Riser Diagrams: Provide information needed to properly install all vertical plumbing risers and vent stacks.

pipes to fixtures.

PLUMBING

The plumbing package includes everything needed to guide the

Comprehensive Sewage System Plan: Shows the optimal routing

Bill of Materials: A complete list of every component needed, from

BOM (Bill Of Materials) (Separately Attached)





structure.


The Bill of Materials (BOM) is a crucial document that compiles the material requirements from different disciplines into a centralized inventory, enabling efficient procurement, inventory management, and cost estimation for a specified project or

ELECTRICAL BOM



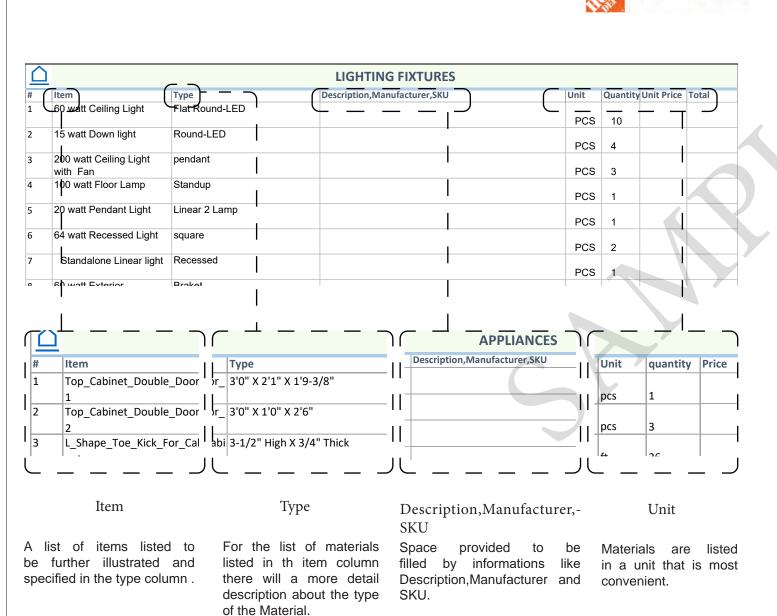

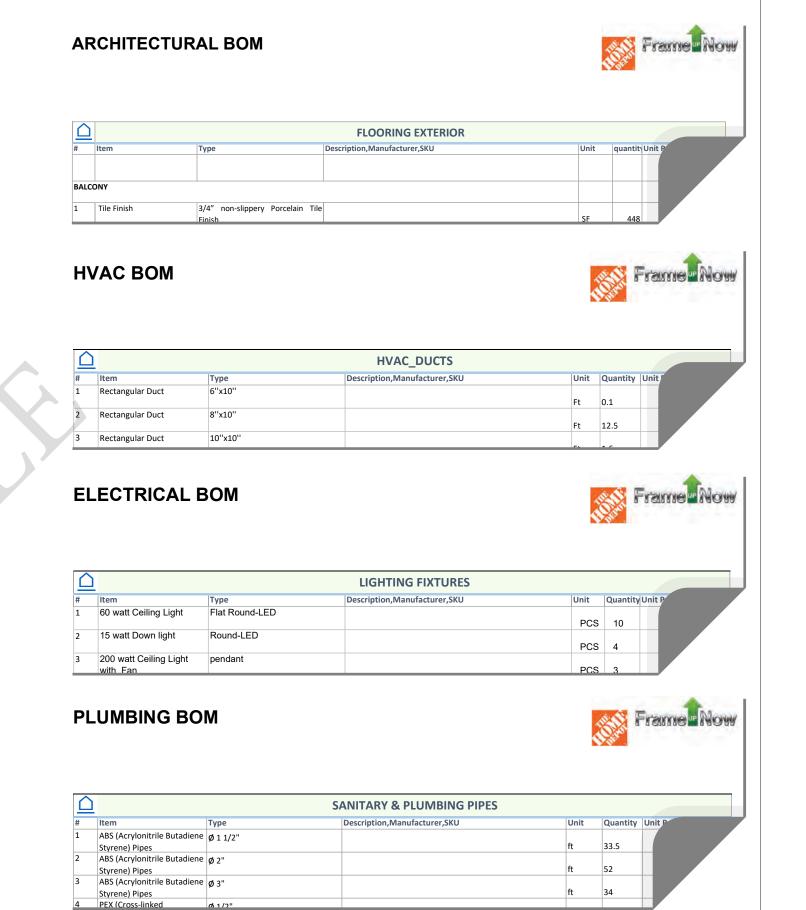

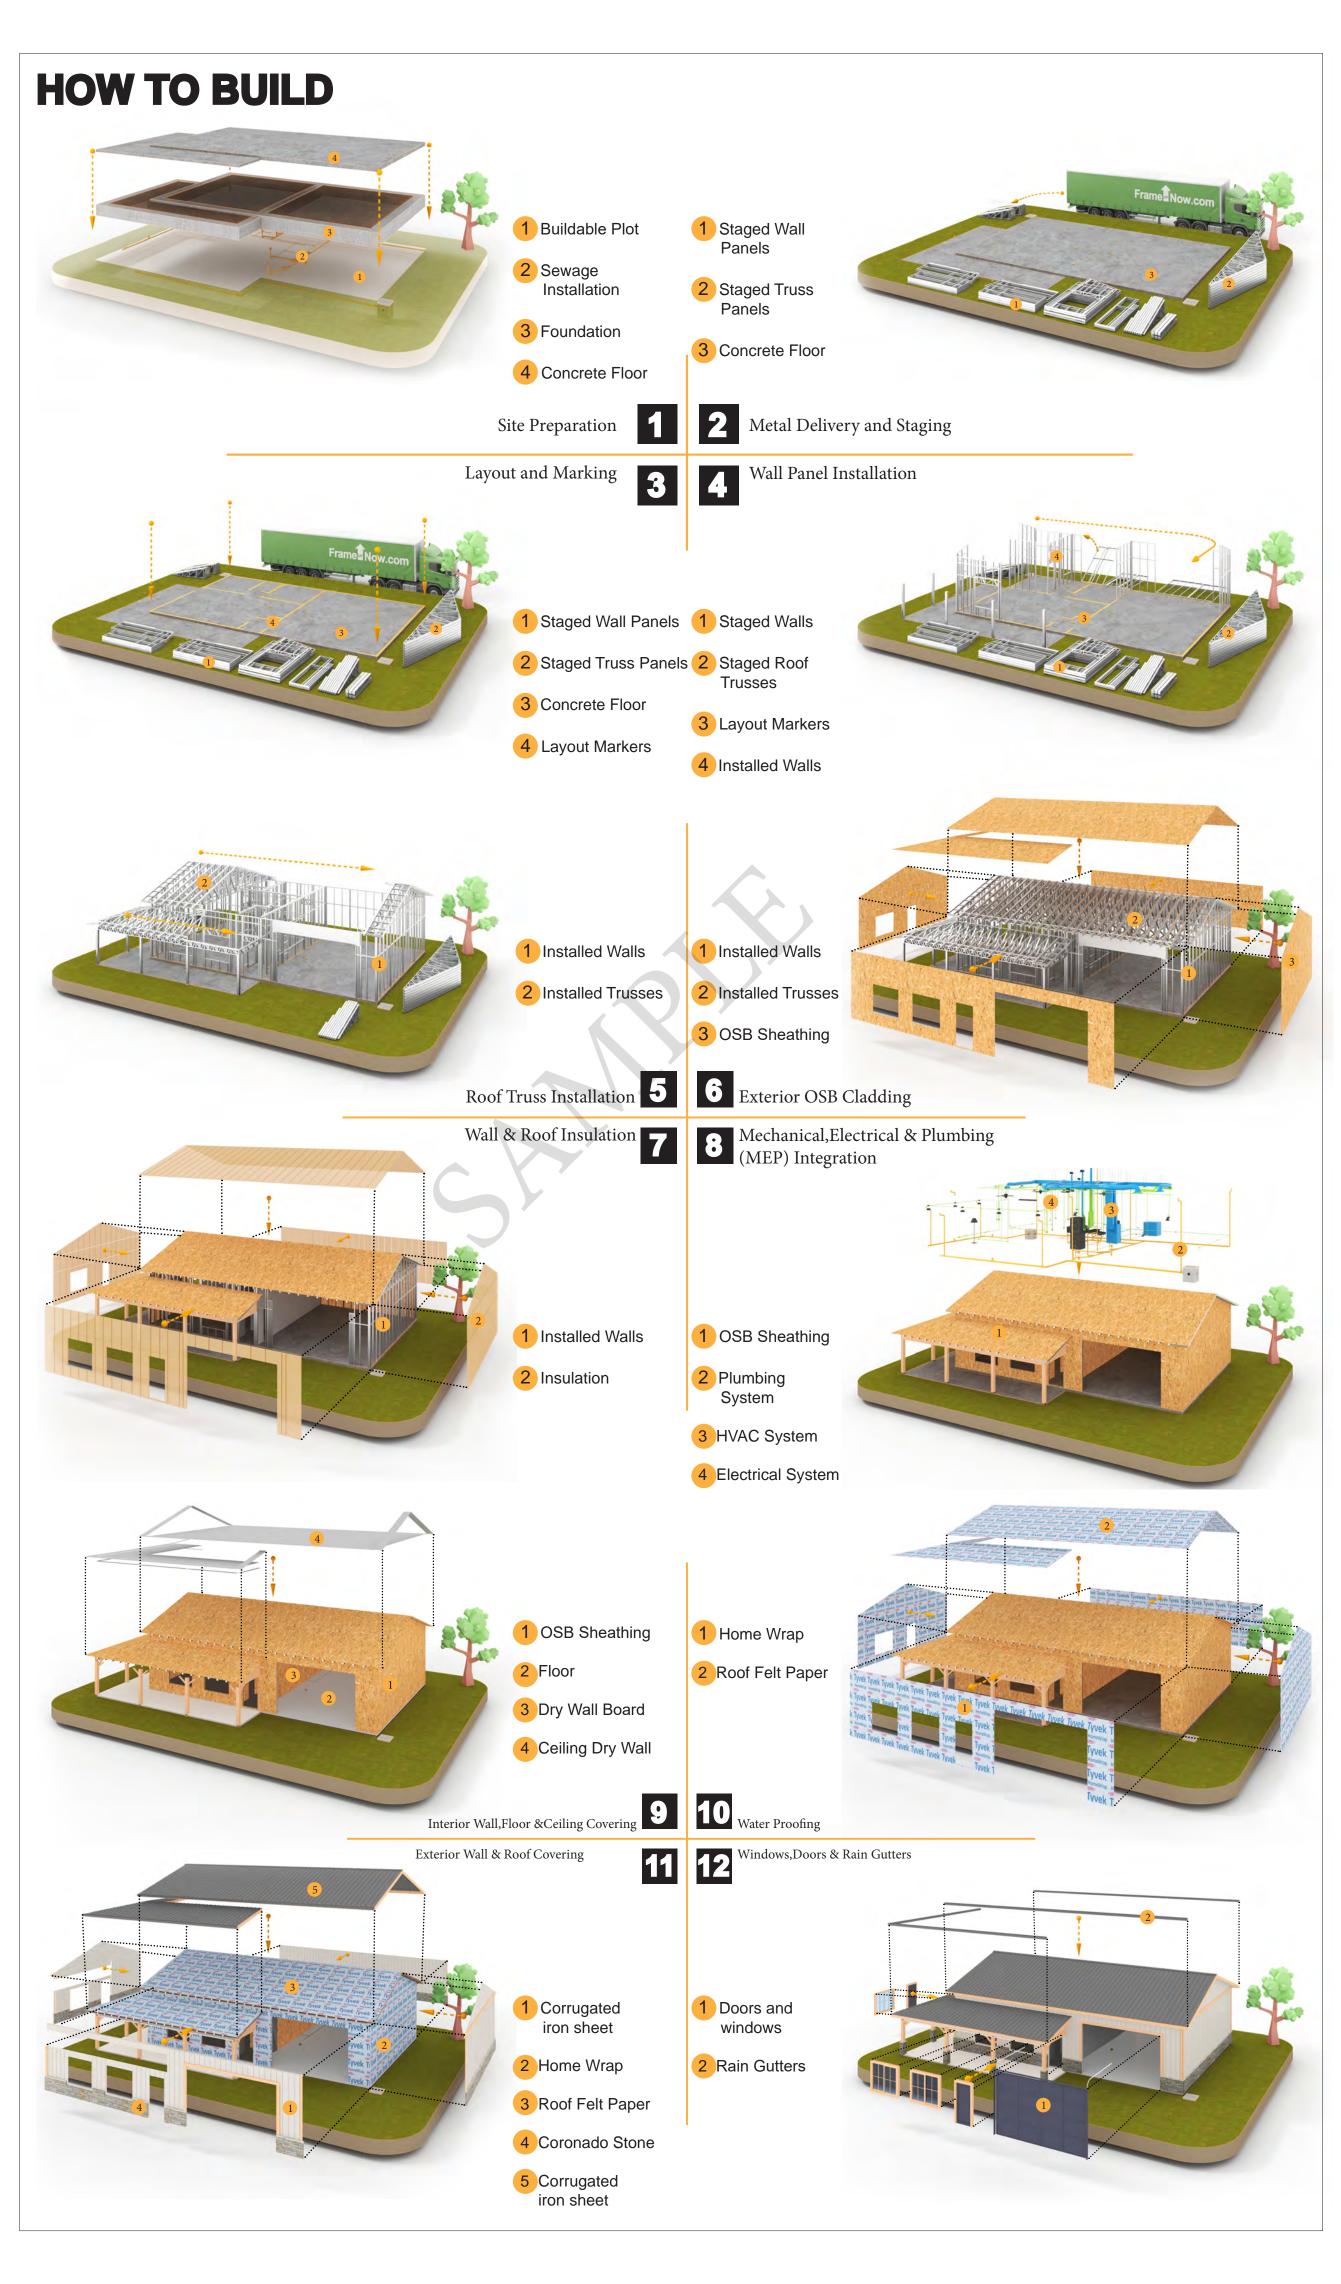



KEY PLAN

NO.	DESCRIPTION	DATE

NOTE:

LEGEND:

PROJECT

LA County-1200-3Bd1Ba-550


DRAWING NAME

INTRODUCTION

CLIENT NAME: PROJECT NUMBER: DATE: **DESIGNED BY** DRAWN BY: CHECKED BY:

1102

SCALE:

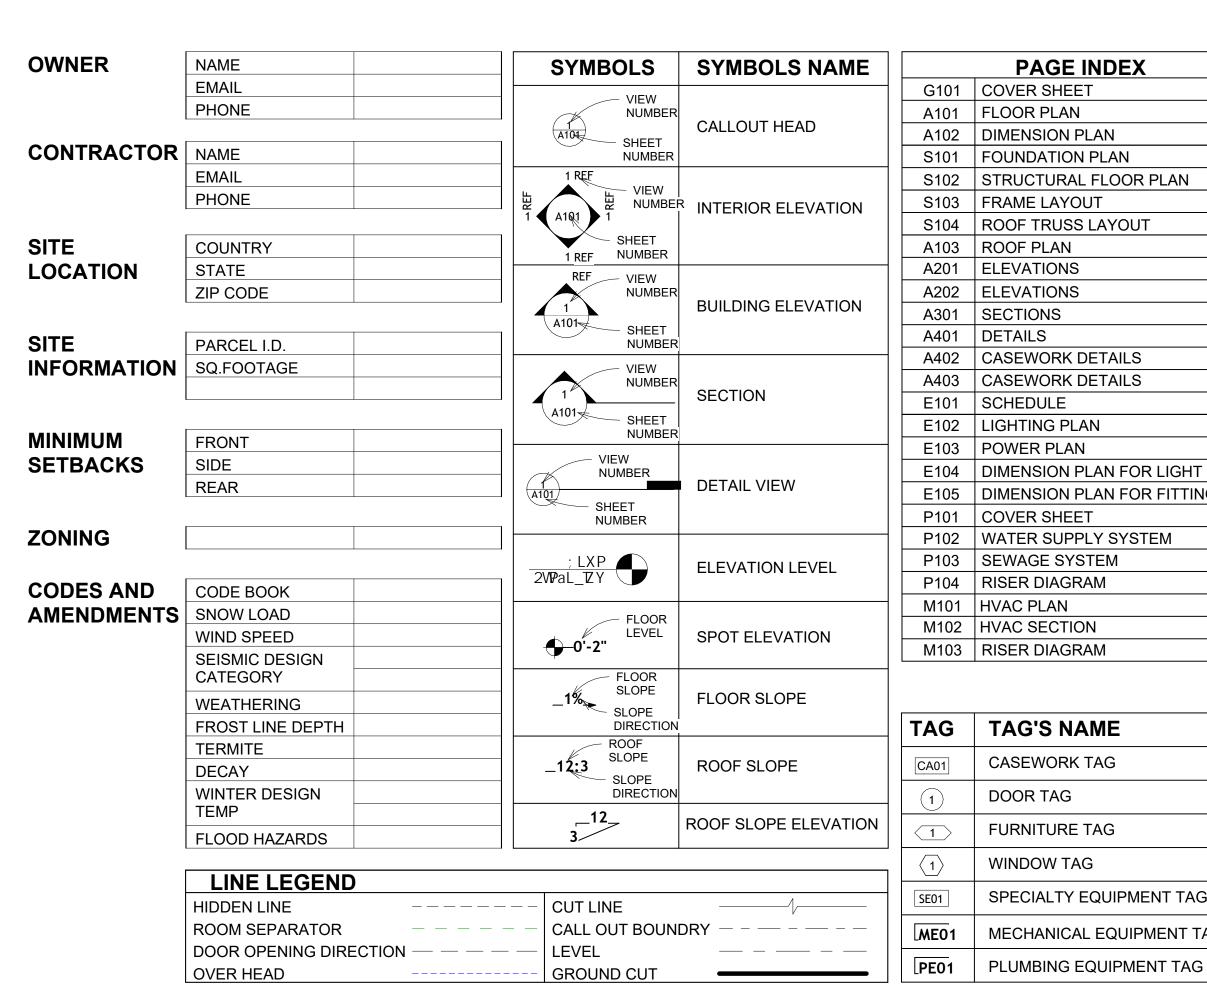

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CASEWORK TAG


FURNITURE TAG

SPECIALTY EQUIPMENT TAG

MECHANICAL EQUIPMENT TAG

WINDOW TAG

DOOR TAG

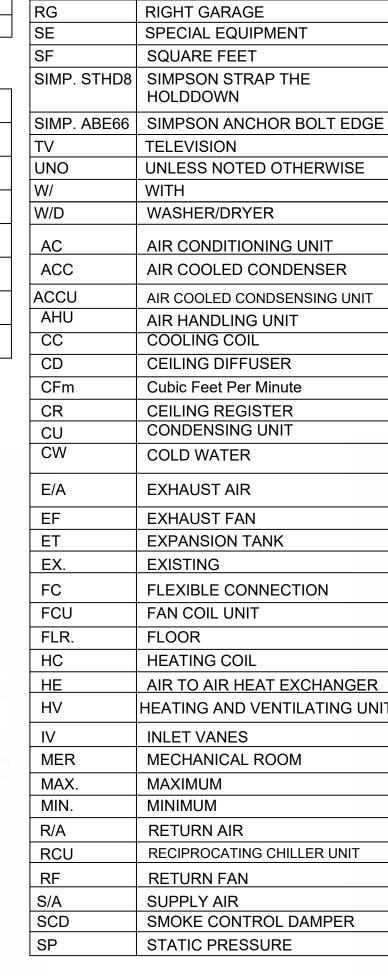

ABBREVIATION

CASEWORK

ELECTRICAL

FOOTINGS

CODE

MAXIMUM

MINIMUM

NUMBER

ON CENTER

PLUMBING

REFERENCE

POLYVINYL CHLORIDE

MECHANICAL

CONDITIONING

F.F.E

F.F.L

HVAC

MAX.

ME


O.C

OSB

PVC


TESTING AND MATERIAL

FINISHED FLOOR LEVEL

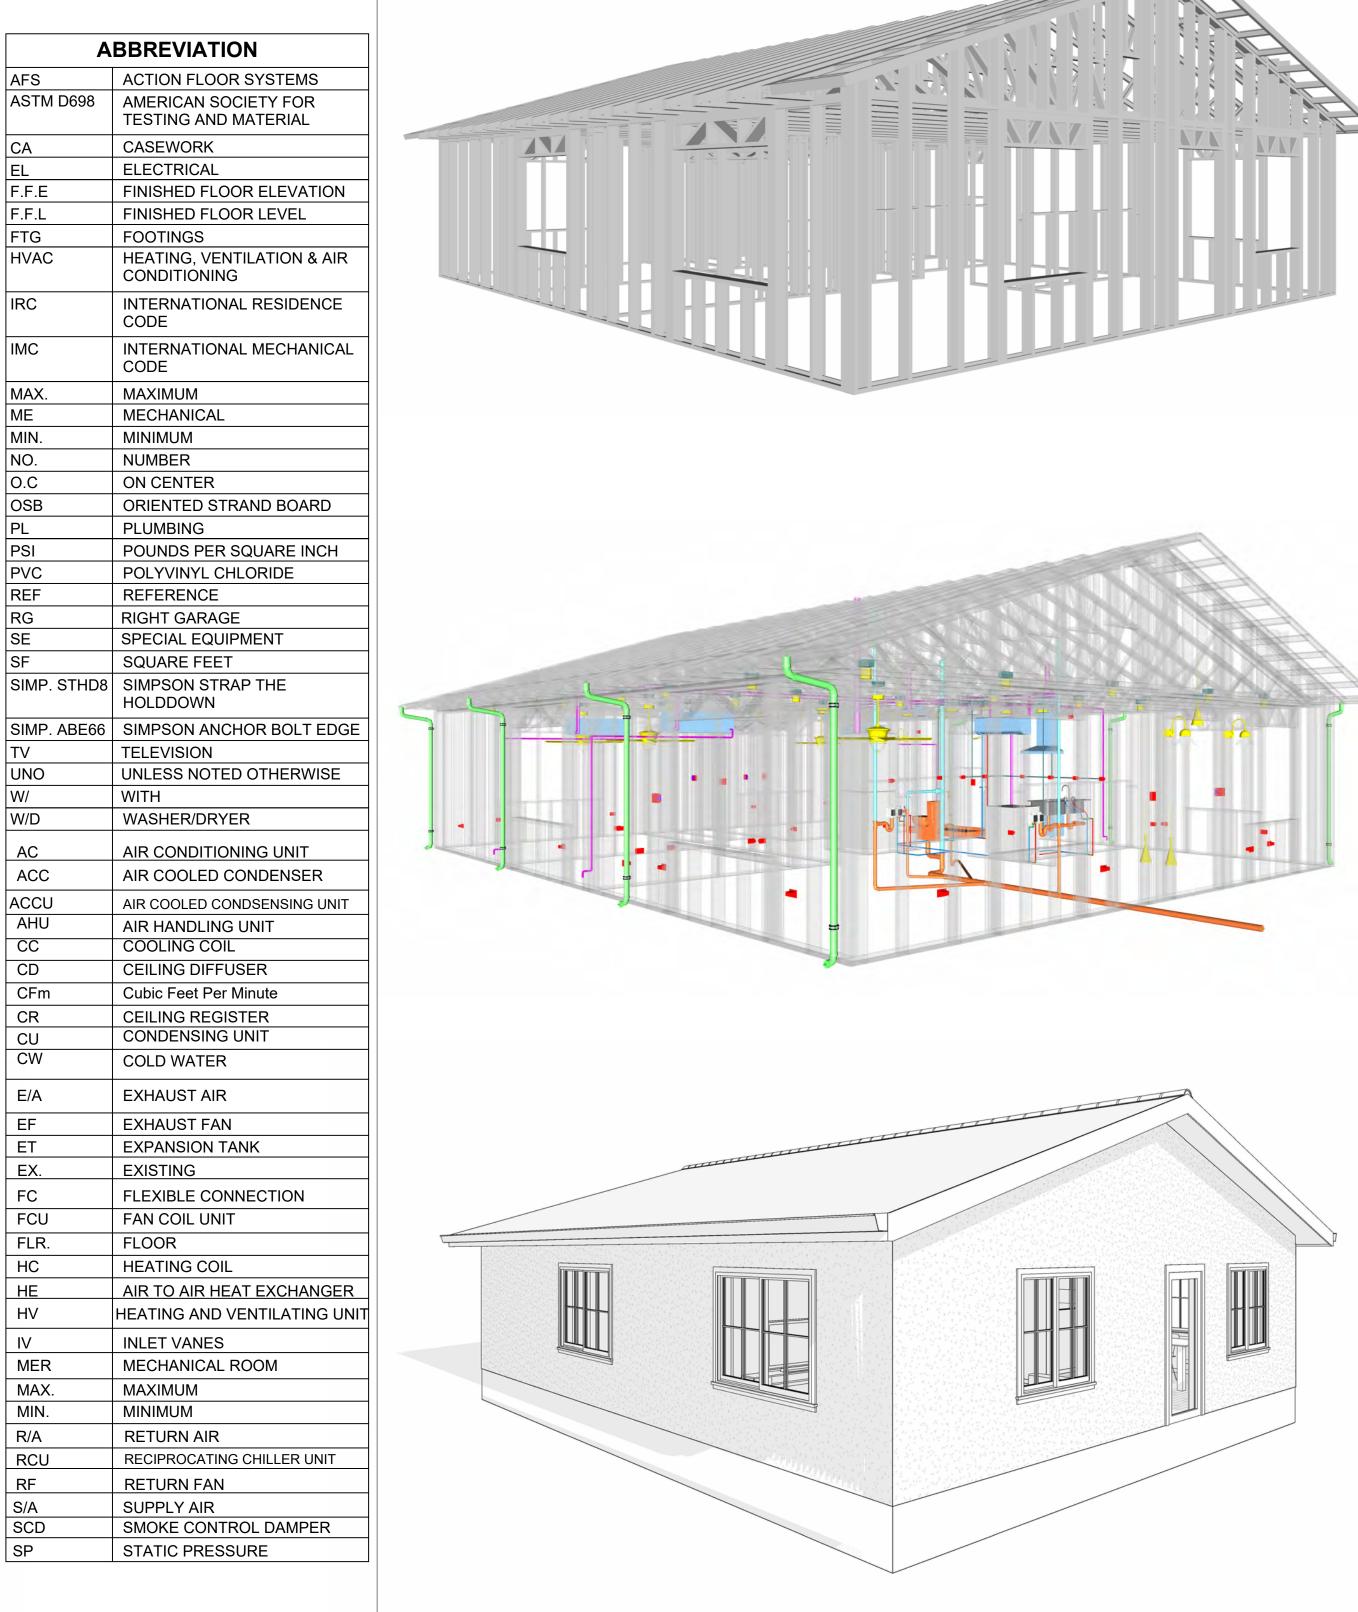

LA County-1200-3Bd1Ba 550

SQUARE FOOT	AGE
LIVING	1200
TOTAL	1200

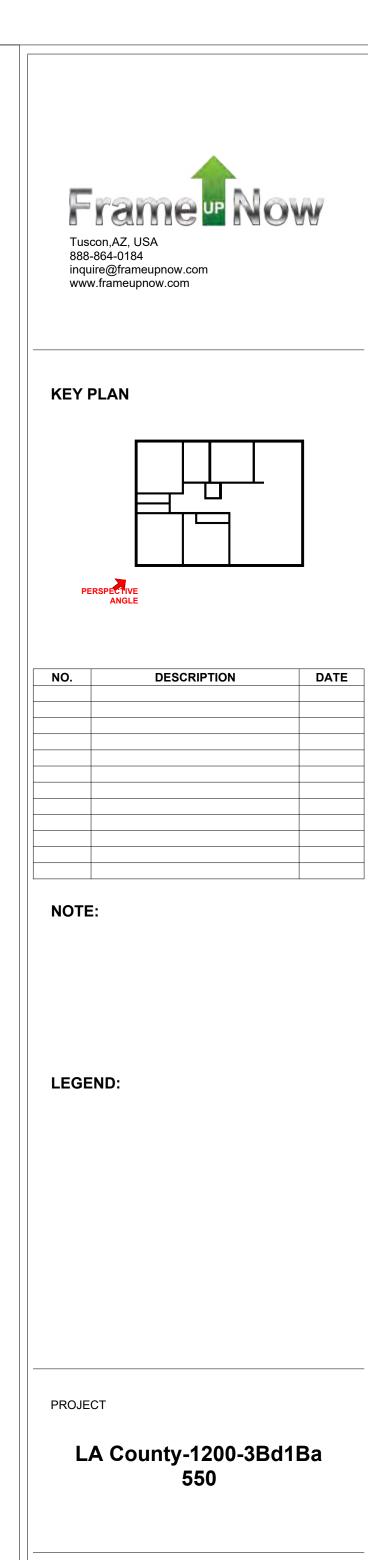

DRAWING NAME

CHECKED BY:

Client Name CLIENT NAME: PROJECT NUMBER: 0061_12 4/10/2025 5:03:59 PM DESIGNED BY: Designer DRAWN BY:

Checker

COVER SHEET

GENERAL NOTES

- 1. THIS DRAWING DEPICTS THE ARCHITECTURAL (SPACE LAYOUT, FURNISHING, FLOOR, WALLS, ROOFS, FOUNDATION, WINDOWS AND DOORS) SYSTEMS. IT PROVIDES A VISUAL REPRESENTATION OF THE ARCHITECTURAL LAYOUT AND COMPONENTS.
- THE ARCHITECTURAL DRAWINGS ARE PREPARED TO MEET THE SPECIFIC REQUIREMENTS OF THE BUILDING, AS PER THE PROJECT SPECIFICATIONS AND APPLICABLE CODES AND STANDARDS. THE CONSTRUCTION OF THIS HOME SHALL COMPLY WITH THE LATEST EDITION OF THE
- INTERNATIONAL RESIDENTIAL CODE (IRC), INTERNATIONAL MECHANICAL CODE (IMC), THE INTERNATIONAL PLUMBING STANDARD, THE NATIONAL ELECTRICAL STANDARD AND ALL OTHER APPLICABLE LOCAL, STATE, AND NATIONAL CODES AND REGULATIONS.
- 4. COORDINATION WITH OTHER TRADES HAS BEEN DONE ON A DESIGN LEVEL. THIS DRAWING SHALL BE READ TOGETHER WITH THE ME, EL AND PL DESIGN DRAWINGS TO ENSURE PROPER CONSTRUCTION AND INTEGRATION OF THE BUILDING SYSTEMS.

ABOUT WALLS:

SHOWER WALL COVERING

BATHTUB AND SHOWER SPACES (WALLS AND FLOORS) WITH INSTALLED SHOWER HEADS AND IN SHOWER COMPARTMENTS SHALL BE FINISHED WITH A NON-ABSORBENT SURFACE.

WALL PAINT (INTERNAL)

THE TYPICAL THICKNESS OF LATEX WALL PAINT IS 1/32 OF AN INCH FOR A SINGLE COAT. AND DOUBLE COAT (1/16") SHALL BE APPLIED FOR DURABILITY.

ADHESIVES:

THE ADVISABLE TYPE OF ADHESIVE FOR THIS PROJECT IS **EPOXY ADHESIVES**BECAUSE THEY ARE KNOWN FOR THEIR HIGH STRENGTH, DURABILITY, AND RESISTANCE TO MOISTURE, CHEMICALS AND

REFER TO SHEETS A201 & A202 FOR GENERAL NOTES ON EXTERNAL FINISHING MATERIALS

ABOUT FLOORS:

1. THE SPOT ELEVATION INDICATES THE FINISHED FLOOR ELEVATION.


FINISHED FLOORS PER PLANS.

FIELD VERIFY FOR DIMENSION DROP 4" FOR SHOWER AND BATHTUB USE. 1% SLOPE ON OUTDOOR BALCONIES FOR WATER RUN OFF.

2% SLOPE TOWARDS THE SHOWER DRAIN FOR SUFFICIENT DRAINAGE.

4" DROP AT THE DOOR LEADING TO EXTERIOR BALCONY FROM THE MAIN LIVING AREA.


5% SLOPE FOR GARAGE IS USED, WHICH SHOULD BE CHECKED WITH THE LOCAL GARAGING ZONING LAWS.

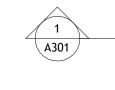





	FURNITURE SCHEDULE			
TYPE MARK	TYPE		COUNT	
01	KING SIZE BED	2		
02	FIVE SIT 68" X 126"	1		
03	DINING CHAIR	6		
04	SAMPLE PARAMETRIC TABLE 2	2		
05	TV STAND	1		
06	DOUBLE 53" X 74"	1		
07	DINING TABLE 1			

	ROOM FINISH SCHEDULE						
ROOM NUMBE R ROOM NAME		FLOOR FINISH	BASE FINISH	WALL FINISH	CEILING FINISH	CEILING HEIGHT	COMMENT
01	LIVING ROOM	HARDWOOD	CONCRETE	WALL PAINT	DRY WALL	8' - 0"	
02	KITCHEN	HARDWOOD	CONCRETE	WALL PAINTT + CERAMIC	DRY WALL	8' - 0"	
03	DINING ROOM	HARDWOOD	CONCRETE	WALL PAINT	DRY WALL	8' - 0"	
04	BATH	VINYL TILES	CONCRETE	CERAMIC TILE	MRD	8' - 0"	
05	BEDROOM 1	HARDWOOD	CONCRETE	WALL PAINT	DRY WALL	8' - 0"	
06	CL 1	HARDWOOD	CONCRETE	WALL PAINT	DRY WALL	8' - 0"	
07	BEDROOM 2	HARDWOOD	CONCRETE	WALL PAINT	DRY WALL	8' - 0"	
08	CL 2	HARDWOOD	CONCRETE	WALL PAINT	DRY WALL	8' - 0"	
09	BEDROOM 3	HARDWOOD	CONCRETE	WALL PAINT	DRY WALL	8' - 0"	
10	CL 3	HARDWOOD	CONCRETE	WALL PAINT	DRY WALL	8' - 0"	
11	HALL	HARDWOOD	CONCRETE	WALL PAINT	DRY WALL	8' - 0"	
12	WD	VINYL TILES	CONCRETE	CERAMIC TILE	DRY WALL	8' - 0"	

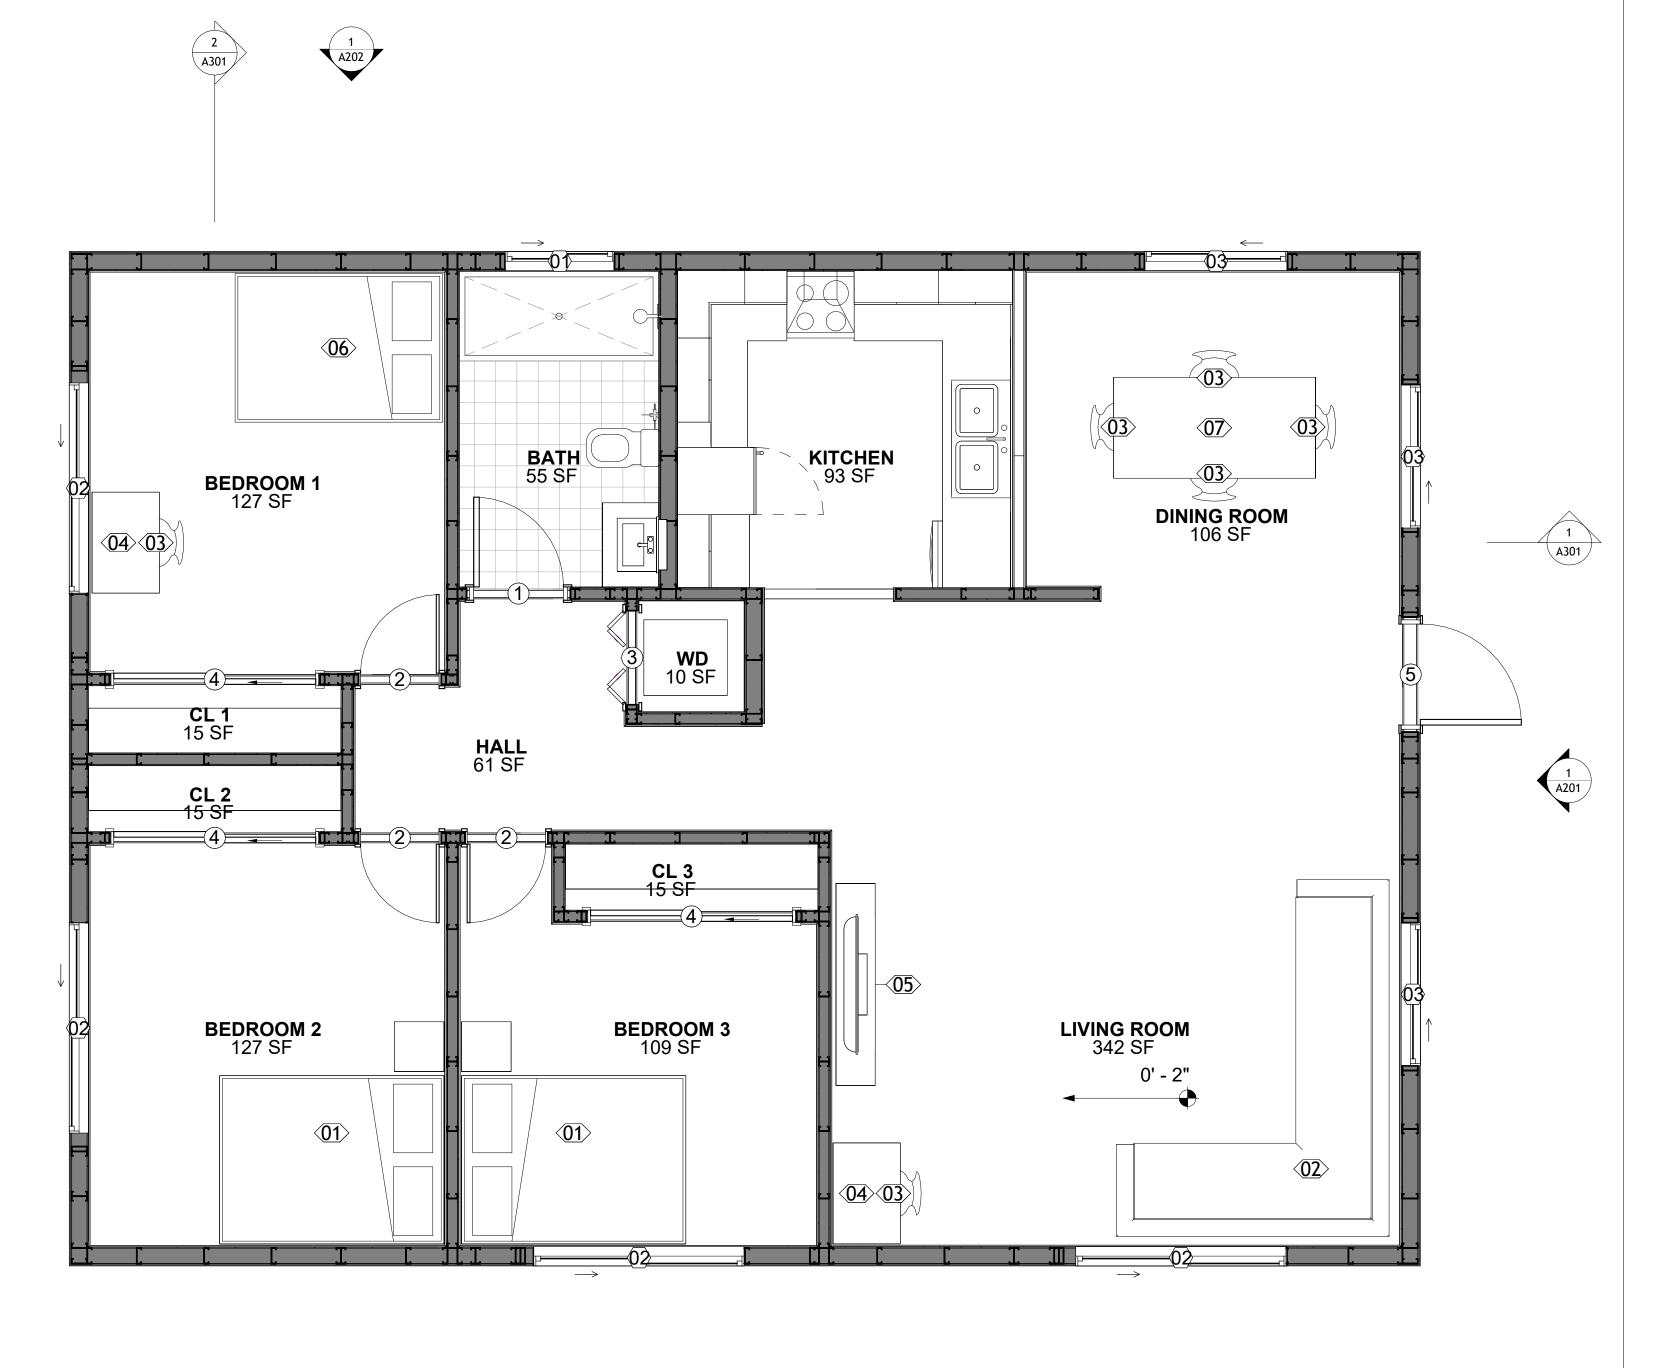

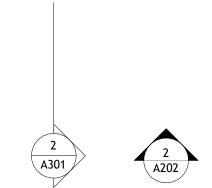



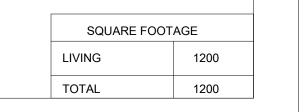



KEY PLAN

NO.	DESCRIPTION	DATI
NOTE:		

NOTE:

LEGEND:

PROJECT


LA County-1200-3Bd1Ba

DRAWING NAME

FLOOR PLAN

CLIENT NAME:	Client Name
PROJECT NUMBER:	0061_12
DATE:	4/10/2025 5:04:00 PM
DESIGNED BY:	Designer
DRAWN BY:	Author
CHECKED BY:	Checker

A101

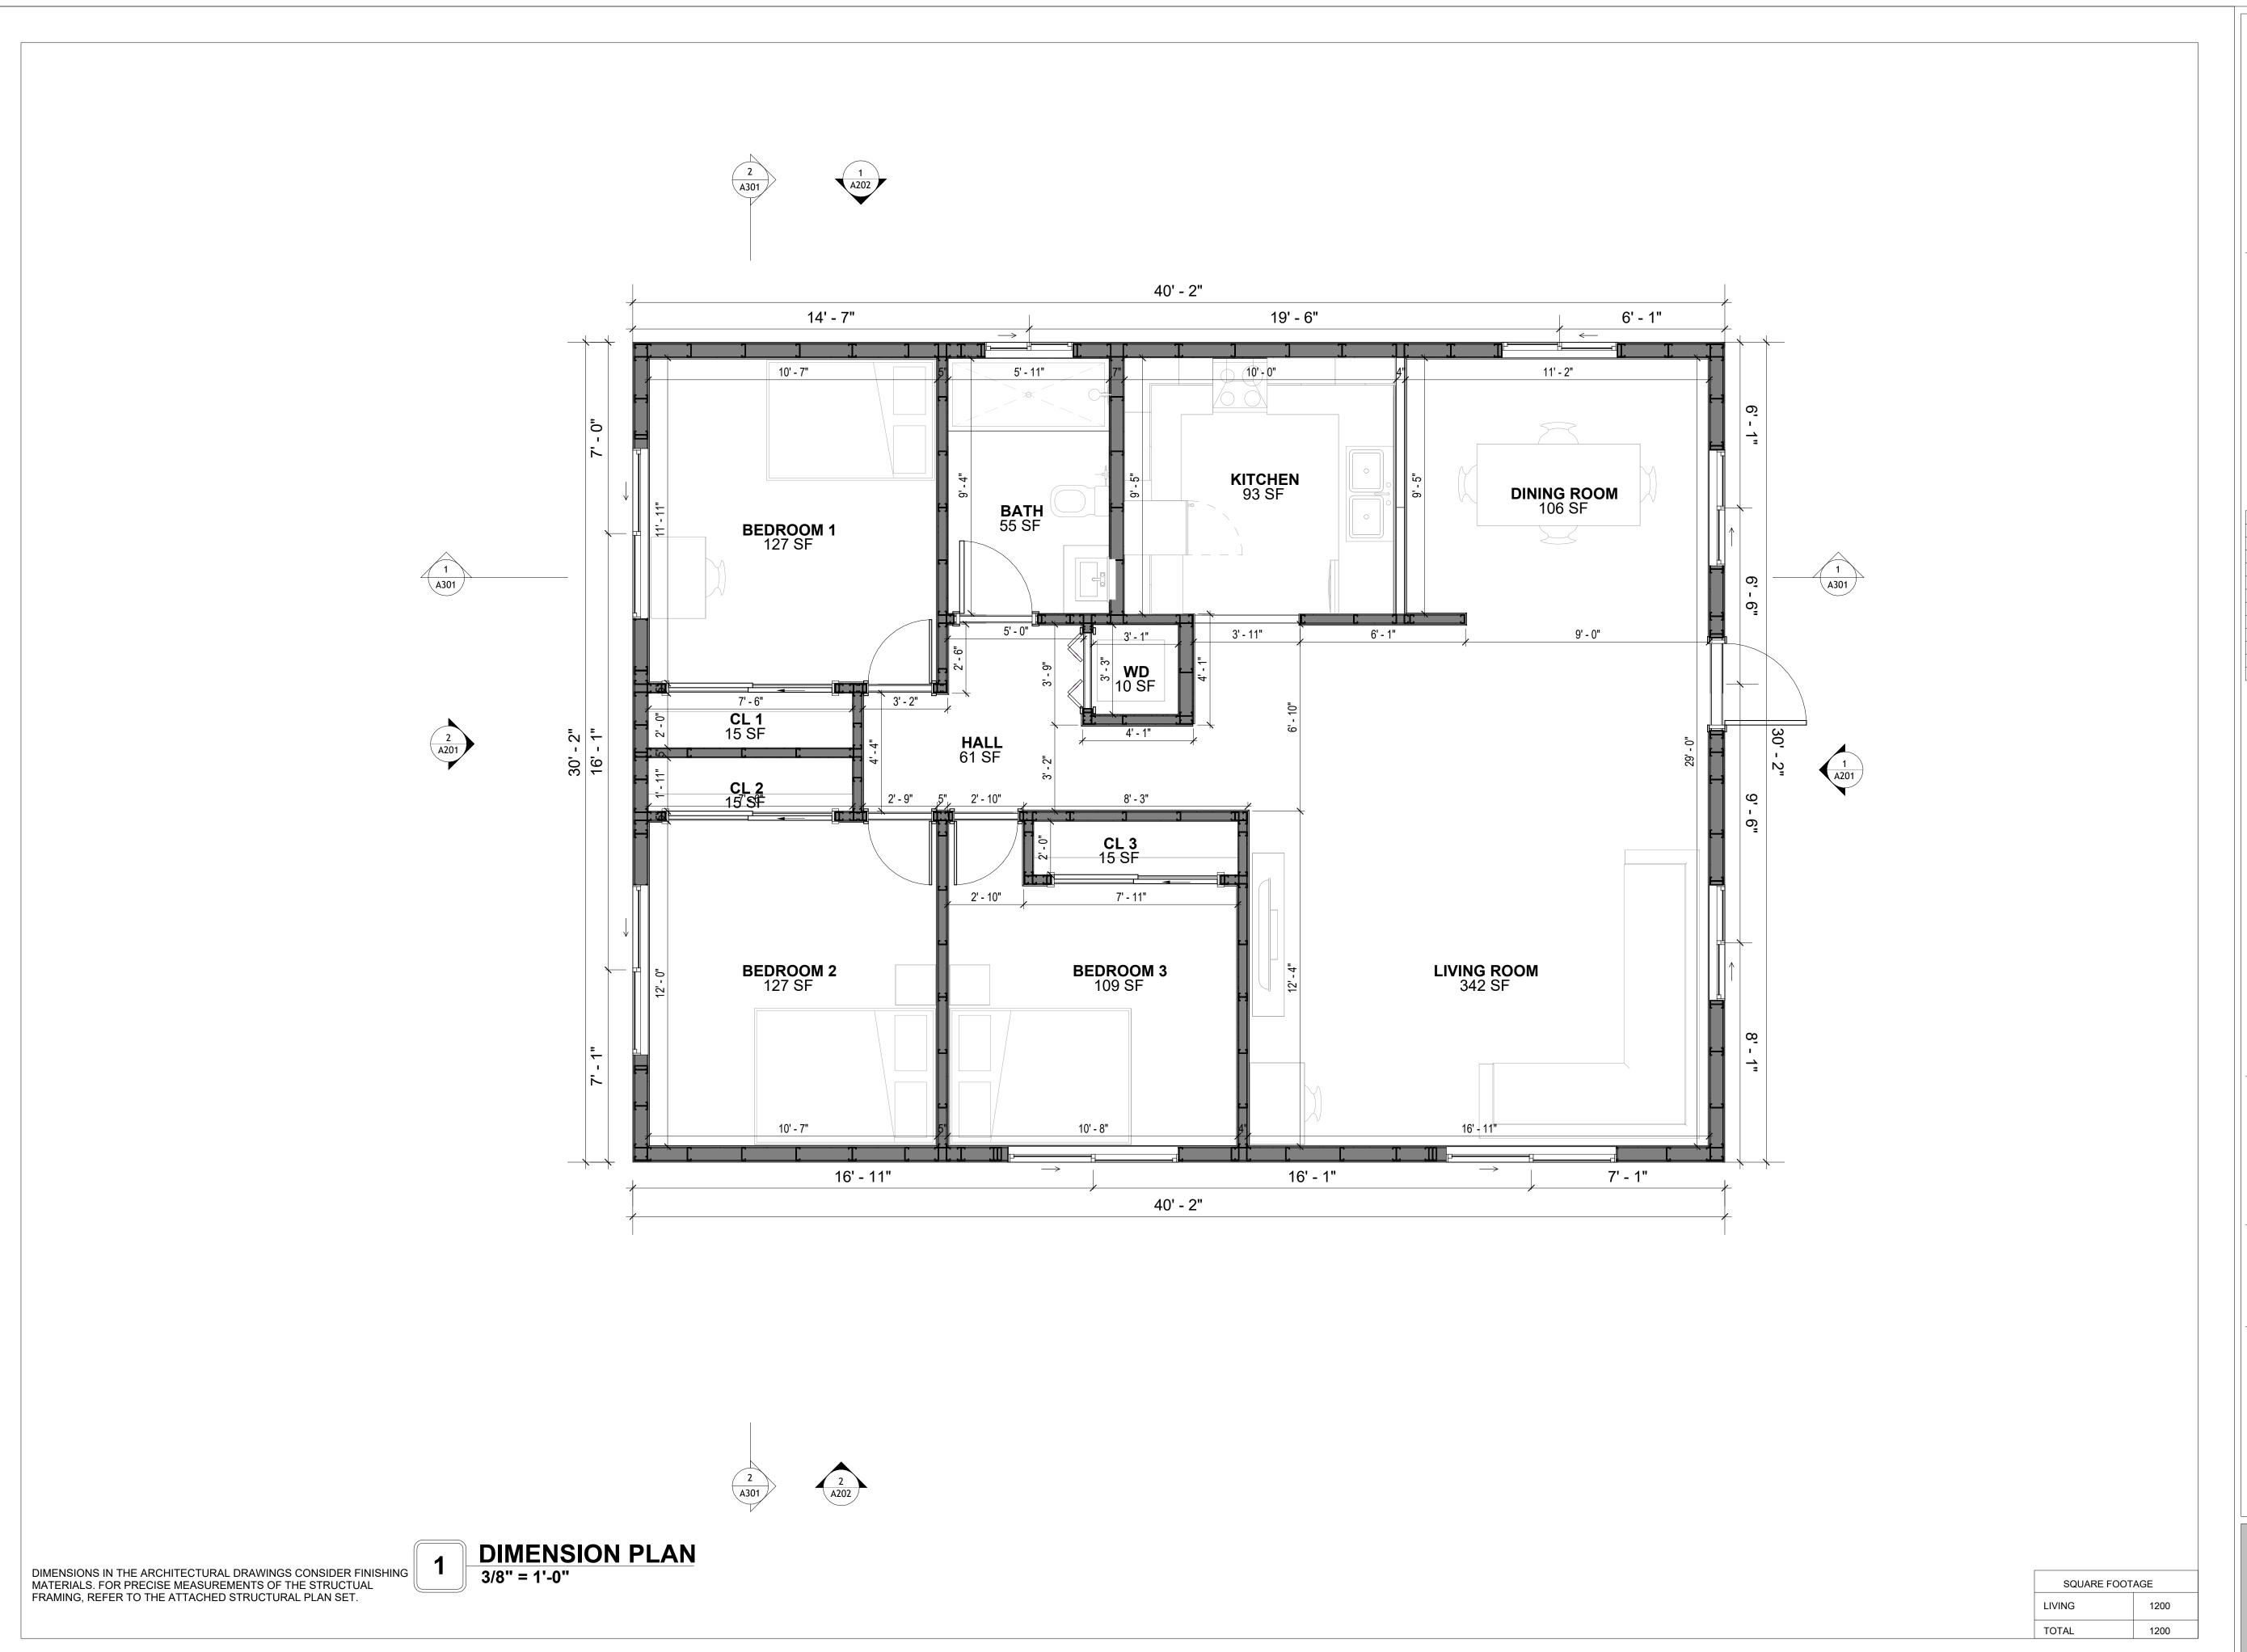



KEY PLAN

NO.	DESCRIPTION	DATE

NOTE:

LEGEND:

PROJECT

LA County-1200-3Bd1Ba 550

DRAWING NAME

DIMENSION PLAN

CLIENT NAME:	Client Name
PROJECT NUMBER:	0061_12
DATE:	4/10/2025 5:04:01 PM
DESIGNED BY:	Designer
DRAWN BY:	Author
CHECKED BY:	Checker

A102

SCALE: 3/8" = 1'-0"

FOUNDATION NOTES

NOTES

TERMITES PRETREATMENT BY LICENSED CONTRACTOR UNDER SLAB AND AROUND FOOTINGS. ALL AREAS BELOW SLABS SHALL BE TREATED NO MORE THAN 24 HOURS PRIOR TO CONCRETE POUR. EVIDENCE OF TREATMENT MUST BE PROVIDED PRIOR TO PLACING OF CONCRETE.

. MATERIALS:

ALL INTERIOR CONCRETE SLABS SHALL BE A MIN. OF 4" THICK CONCRETE OVER 4" COMPACTED AGGREGATE BASE (ASTM D698), FINISH ELEVATIONS AS NOTED ON DRAWINGS, 6" ABOVE ADJACENT GRADE, LEVEL SLABS TO 1/8"-10' MAX.. CONCRETE SLABS SHALL BE 2500# PSI AT 28 DAYS. A 4" ALLOWABLE SLUMP.

2. PAD PREPARATION:

- EXCAVATION FOR FOOTING SHALL BE NEAT.

- FOOTINGS SHALL BE POURED IMMEDIATELY AFTER EXCAVATION AND APPROPRIATE INSPECTION.

- ALL REINFORCING STEEL MARKED "CONTINUOUS" SHALL BE LAPPED 36 BAR DIAMETERS AT SPLICES AND AROUND CORNERS OR INTERSECTIONS WITH A STANDARD 90 DEGREE BEND ON CORNER BARS. LAP WIRE MESH ONE FULL MESH AT SIDE AND END LAPS.
- ALL HARDWARE TO BE SIMPSON OR EQUIVALENT.

- EXTERIOR FRAME WALL TO BE SECURED WITH 1/2"X10" ANCHOR BOLTS 4'-0" O.C. FOR 1-STORY AND 2'-8" O.C. FOR 2-STORY. BOLTS SHALL BE LOCATED WITHIN 1'-0" OF EACH END PIECE AND SHALL HAVE A MIN. OF TWO BOLTS PER PIECE.

-FOUNDATION ANCHOR STRAPS SHALL BE PERMITTED, ACCORDING TO RESIDENTIAL CODE 2021

- ALL INTERIOR WALLS TO BE SECURED WITH POWER DRIVEN PINS PER MANUFACTURER SPECIFICATION USE PIN SPACING EQUIVALENT TO 1/2" ANCHOR BOLTS.
- ALL CONSTRUCTION TO CONFORM TO THE 2012 IRC

- R-10 RIGID INSULATION OUTSIDE OF EXTERIOR FOUNDATION WALLS UNDER LIVING AREA.
- CONCRETE PAD FOR CONDENSER THICKNESS IS 4" MIN UNLESS OTHERWISE NOTED.

3. CONCRETE CONSTRUCTION:

- THE SLAB SHALL BE UNDERLAIN BY A VAPOR BARRIER/RETARDER IN THE LIVING AREA (TYPICALLY POLYETHYLENE, UNLESS MORE STRINGENT PROTECTION REQUIRED BY THE ARCHITECT, ENGINEER, FLOOR COVERING MANUFACTURER, OR ACCEPTED PRACTICE). UNLESS OTHERWISE REQUIRED, BARRIER MAY BE OMITTED AT GARAGES, PORCHES AND PATIOS WITHOUT FLOOR COVERINGS. IT IS BEYOND THE SCOPE OF THESE PLANS TO DETERMINE THE APPLICABILITY OF THESE MORE STRINGENT REQUIREMENTS. BUILDER SHALL VERIFY PRIOR TO CONSTRUCTION.

4. REINFORCEMENT

- IF CONSTRUCTED ON ACTIVE SOILS, THE LONG TERM PERFORMANCE OF THE FOUNDATION IS DEPENDENT ON MAINTENANCE BY THE OWNER. THUS THE BUILDER SHALL ADVISE THE OWNER OF THE FOLLOWING:

1. DRAINAGE MUST BE MAINTAINED. WATER SHALL NEVER BE ALLOWED TO POND NEAR THE FOUNDATION.

2. THE SOIL AROUND THE FOUNDATION SHALL BE MAINTAINED IN A RELATIVELY DAMP CONDITION, SUCH AS THAT REQUIRED TO KEEP A LAWN GREEN. IF IT DRIES OUT IT WILL SHRINK. IF IT GETS WET, IT WILL HEAVE UPWARD.

3. SLABS ON THE SHORTER SIDE USES MAIN BARS ARE USED IN THIS DIRECTION ONLY WITH SMALLER DIAMETER DISTRIBUTION BARS ARE PLACED, FORMING A MAT OR GRID.
4. ALL REINFORCEMENT BARS SIZE 10MM OR LARGER IN ACCORDANCE TO ASTM

ANCHOR BOLTS AT ALL EXTERIOR WALLS SHALL BE MINIMUM 1/2 INCH DIAMETER WITH A MAXIMUM SPACING OF 6'-0" ON CENTER, UNLESS NOTED OTHERWISE.
 ANCHOR BOLTS SHALL BE INSTALLED WITHIN 12 INCHES OF EACH END OF EACH SILL PLATE WITH AT LEAST TWO ANCHOR BOLTS FOR EACH BOLTS FOR EACH SILL PLATE LONGER

THAN 12 INCHES.

5. SIMPSONS SILL ANCHORS MAYBE SUBSTITUTED FOR ANCHOR BOLTS AT THE SAME

SPACING.
6. EXTERIOR CONCRETE SLABS WHICH ARE NOT PART OF THE MAIN SLAB SHALL BE MINIMUM 4 INCHES THICK WITH NO STEEL REINFORCING BARS REQUIRED, UNLESS NOTED OTHERWISE ON FOUNDATION PLAN.

VERIFY THE FOLLOWING PRIOR TO POURING:

. ALL HOLDDOWNS , STRAP, AND POST LOCATIONS.

CONCRETE FINISHES. PANEL RISER LOCATION - WHERE APPLICABLE.

3. UNDERSLAB MECHANICAL REQUIREMENTS.

4. STEM WALL BLOCKOUTS.

5. UNDERSLAB ELECTRICAL REQUIREMENTS AND PANEL RISER LOCATION. WHERE APPLICABLE.


6. PROVIDE THE FOLLOWING:

- PVC SLEEVES THROUGH FTG IF REQUIRED

- 20' #4 COPPER GROUND BAR.

7. SLOPE FINISH GRADE AWAY FROM FOOTING.

NOTE: FIELD VERIFY ALL DIMENSIONS SEE DIMENSIONED ARCHITECTURAL DRAWINGS

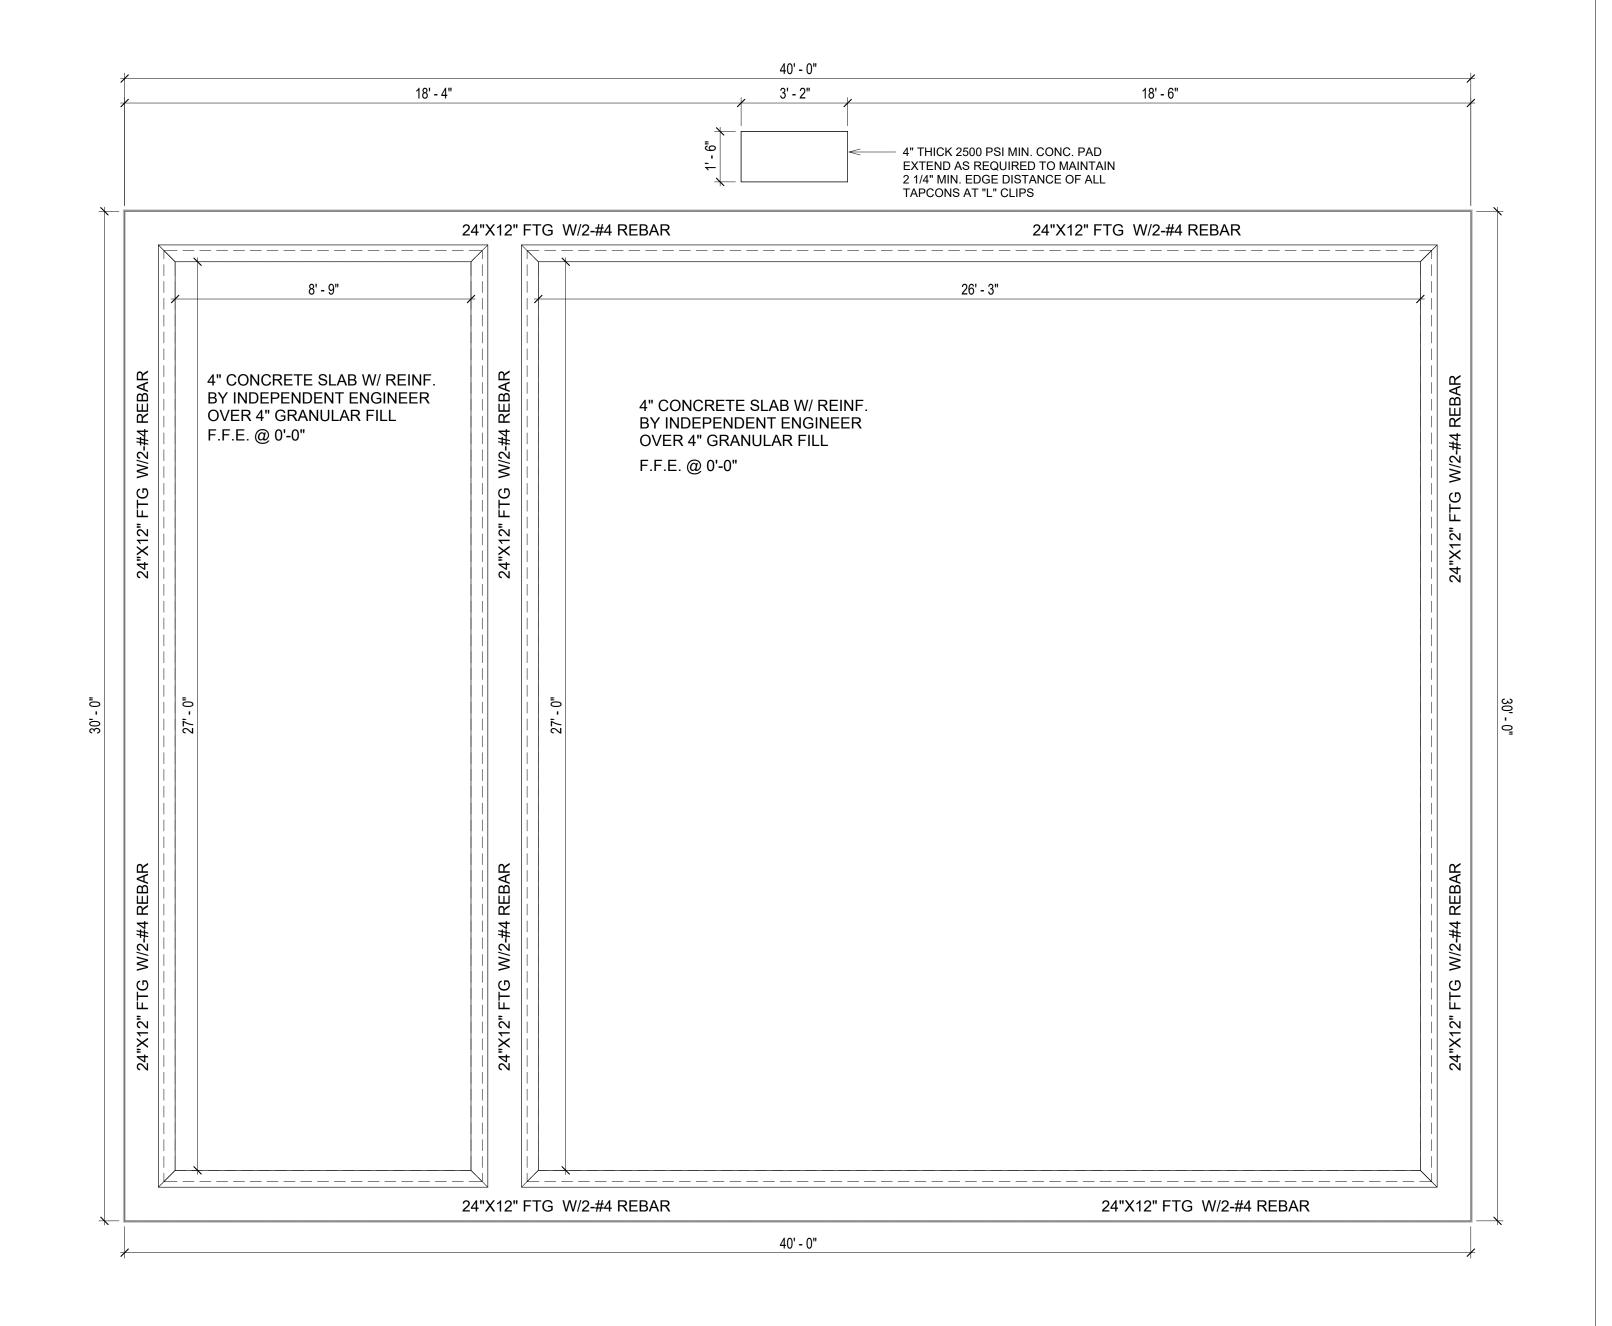

FOUNDATION PLAN
3/8" = 1'-0"

PROJECT LA County-1200-3Bd1Ba DRAWING NAME FOUNDATION PLAN CLIENT NAME: Client Name PROJECT NUMBER: 0061_12 4/10/2025 5:04:01 PM DESIGNED BY: Designer DRAWN BY: Author CHECKED BY: Checker **S101**

SCALE: 3/8" = 1'-0"

888-864-0184

KEY PLAN

NOTE:

LEGEND:

inquire@frameupnow.com www.frameupnow.com

DESCRIPTION

DATE

SQUARE FOOTAGE
LIVING 1200
TOTAL 1200

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GENERAL NOTES

NOTES:

-ALL BEARING WALLS SHOULD HAVE A THICKENED SLAB PER SECTION PER DETAIL A401/5.

A) FOUNDATION PLAN NOTES:

1. CONCRETE SLAB SHALL BE 6" THICK WITH 1/2" DIAMETER TENDONS PER LAYOUT PLAN, CENTERED IN SLAB THICKNESS, OVER APPROVED SUBBASE PER GENERAL STRUCTURE NOTES

TERMITE PROTECTION SHALL BE PROVIDED PER IRC SECTION R318.1
 NONE TYPICAL ANCHOR BOLT SPACING AT SHEAR WALL AND HOLD DOWN

SPECIFICATIONS PER APPROVED ARCHITECTURAL PLANS.

4. INSTALL HOLDOWNS BEFORE CONCRETE SLAB POUR.

5. EXISTING FILL ON-SITE SHALL BE COMPACTED IN ACCORDANCE WITH THE

REQUIREMENTS IN THE GEOTECHNICAL REPORT.

6. ALL FLOOR SLABS ARE REINFORCED ON CONCRETE SLABS.

SPECIAL INSPECTION IS REQUIRED FOR THICKENED FOUNDATION CONSTRUCTION

1. REINFORCEMENT

2. 2300 PSI CONCRETE POUR

B) REINFORCEMENT FOR CONCRETE:

ALL REINFORCING SLABS BARS SIZE 10MM OR LARGER SHALL BE DEFORMED IN ACCORDANCE TO ASTM-A706, AND BARS SMALLER THAN 10 MM MAYBE PLAIN.
 UNLESS OTHERWISE NOTED IN PLANS, THE YIELD STRENGTH OF REINFORCING BARS SHALL BE:


A) FOOTING = 40,000 PSI


B) NON-LOAD BEARING WALLS AND PARAPETS= 40,000 PSI

- 3. SPLICES SHALL BE SECURELY WIRED TOGETHER AND SHALL LAP OR EXTEND
- 4. GRADE OF STEEL FOR RCC WORKS SHALL BE GRADE 4 10.
- 5. BAR NOTATIONS GIVES INFORMATION
 - A) BAR SIZE
 - B) SPACING(IF REQUIRED)
- 6. LAP REINFORCEMENT ONLY AT LOCATION SHOWN IN THE DRAWINGS
 7. REINFORCEMENT SHALL NOT BE CLIT, VENT OR HEATED ON SITE WITH
- 7. REINFORCEMENT SHALL NOT BE CUT, VENT OR HEATED ON SITE WITHOUT ENGINEERS' APPROVAL.
- C) CONCRETE SLAB NOTES
- 1. ALL SLAB REINFORCEMENT SHALL BE 20MM CLEAR MINIMUM FROM BOTTOM AND FROM TOP OF SLAB
- 2. REINFORCEMENT IN CONTINUOUS ELEVATED SLAB SHALL BE CUT AS FOLLOWS.

NOTE:

- THIS IS A SCHEMATIC PLAN FOR THE PURPOSE OF LOCATING AND IDENTIFYING FOUNDATION REINFORCING ELEMENTS ONLY. VERIFY ALL DIMENSIONS, DROPS, OFFSETS AND FEATURES WITH THE ARCHITECTURAL PLANS BEFORE FORMING THE FOUNDATION.

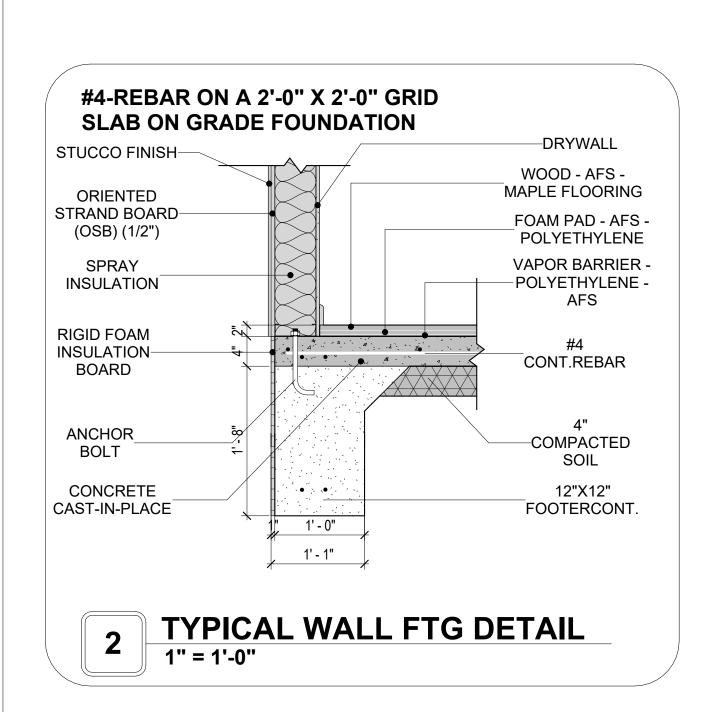

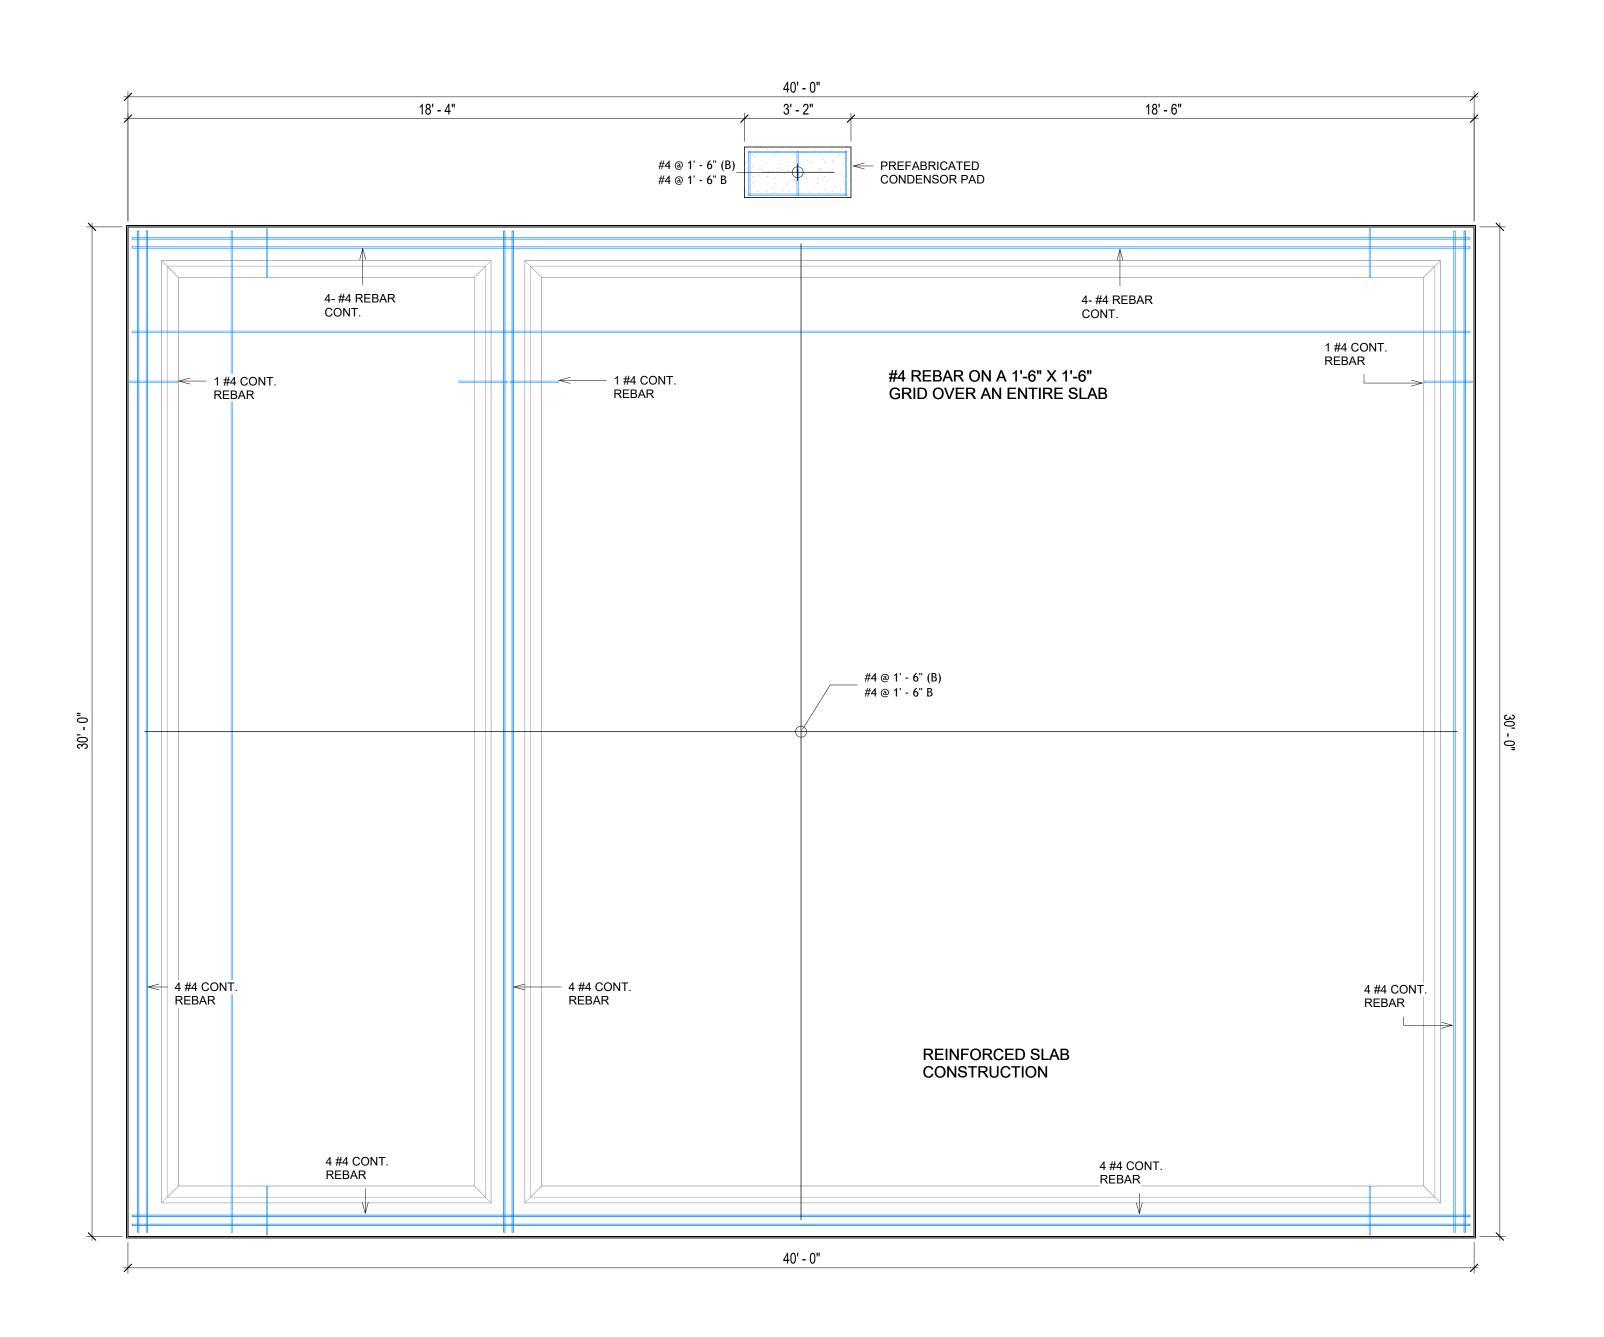

1 FOUNDATION REBAR PLAN
3/8" = 1'-0"



KEY PLAN

NO.	DESCRIPTION	DATE

NOTE:

LEGEND:

PROJECT


LA County-1200-3Bd1Ba 550


DRAWING NAME


STRUCTURAL FLOOR PLAN


Client Name	CLIENT NAME:	
0061_12	PROJECT NUMBER:	
4/10/2025 5:04:02 PN	DATE:	
Designer	DESIGNED BY:	
Author	DRAWN BY:	
Checker	CHECKED BY:	

S102

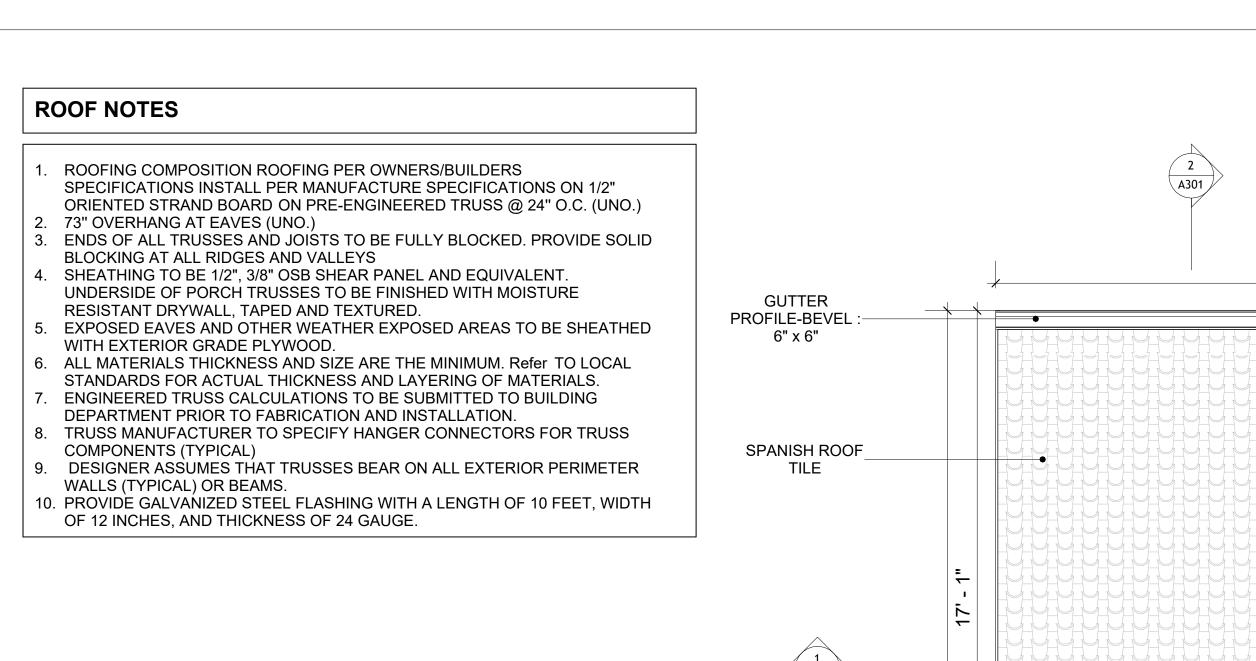

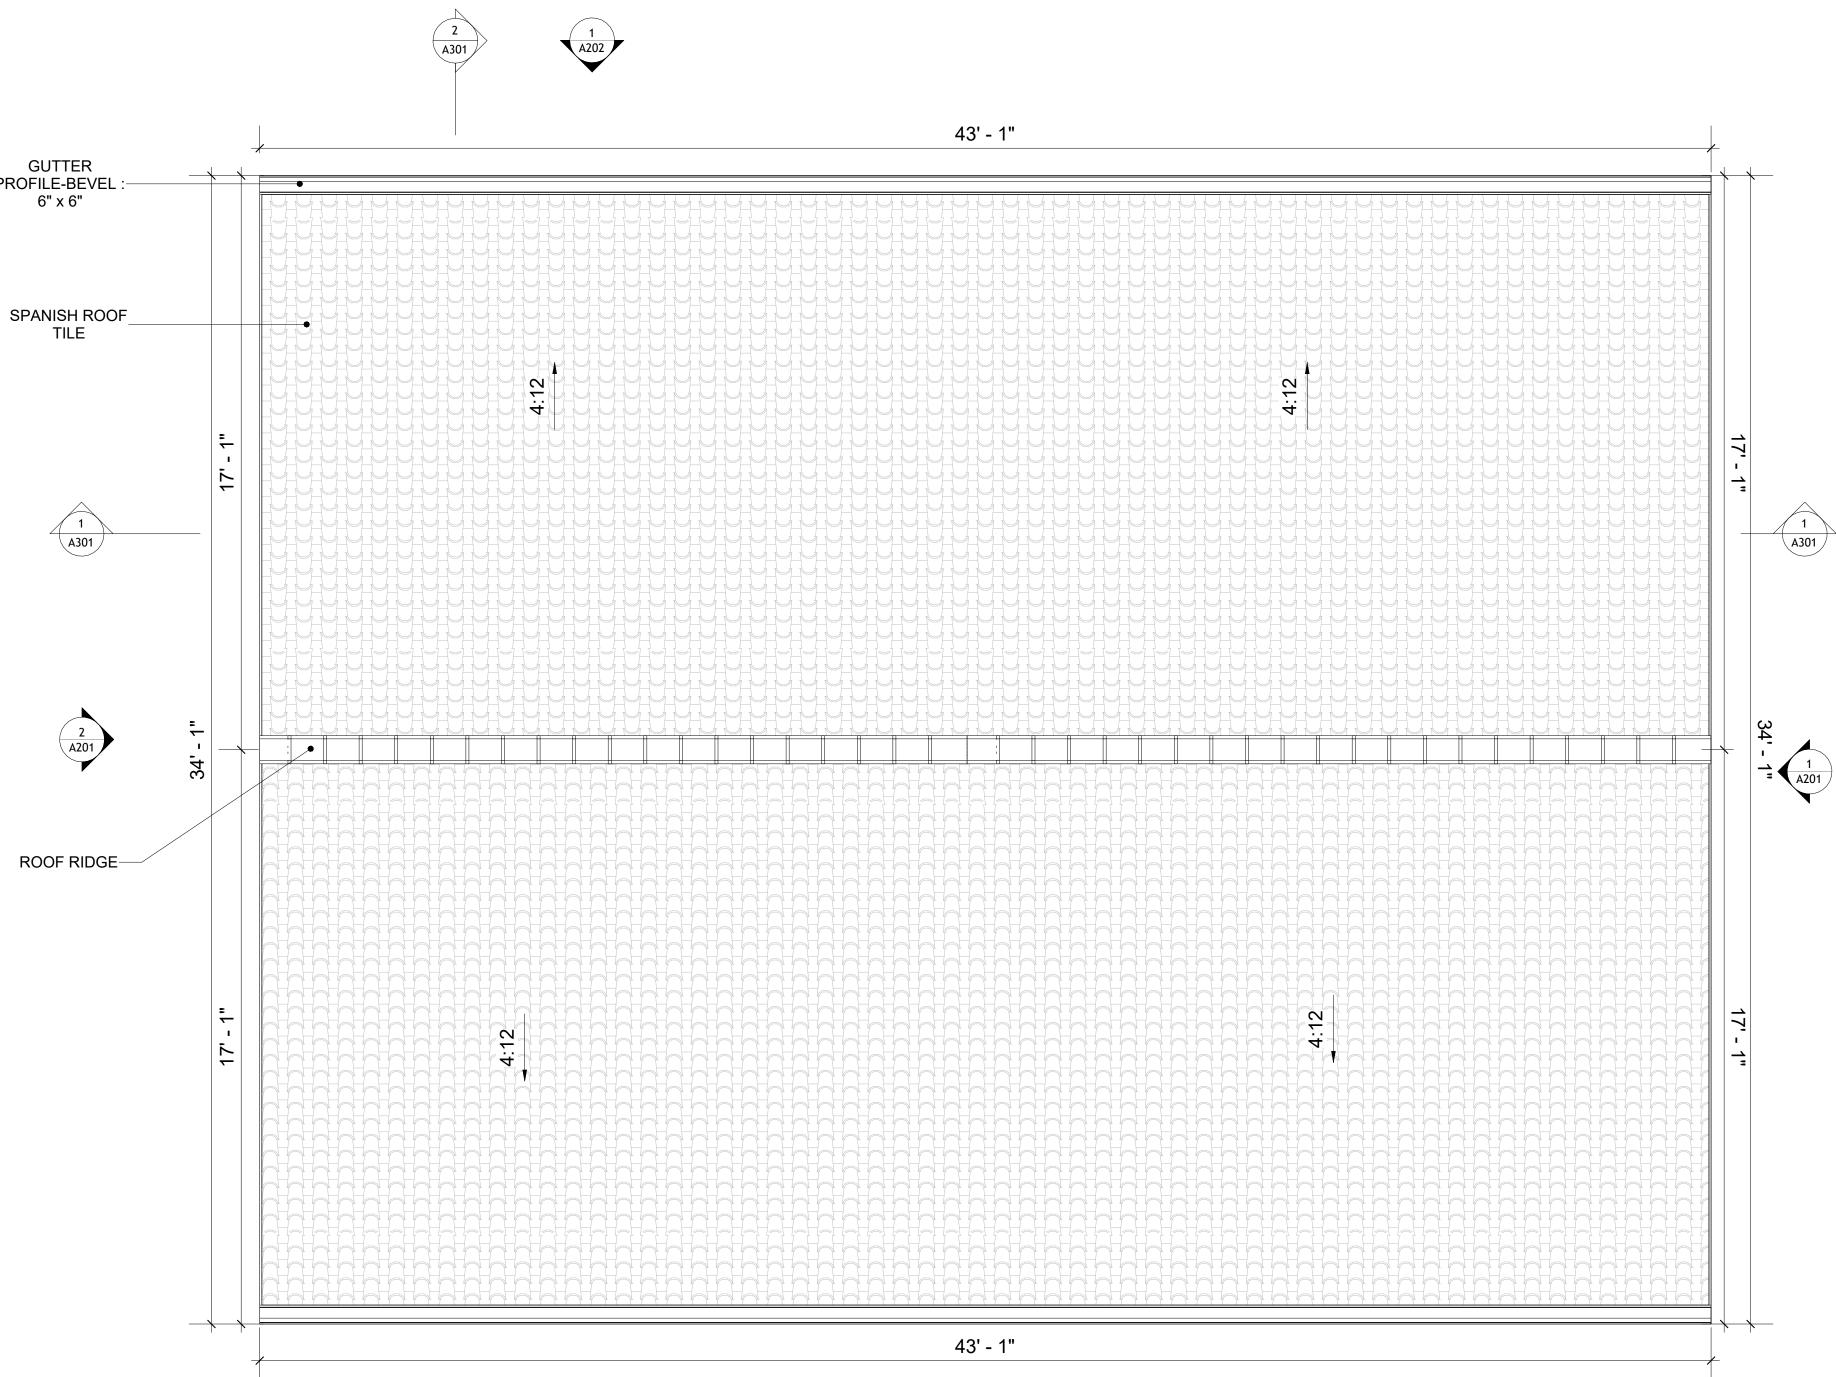

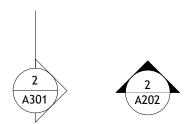

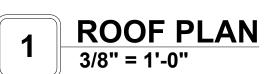

SQUARE FOOT	AGE
LIVING	1200
TOTAL	1200



KEY PLAN

NO.	DESCRIPTION	DATE

NOTE:

LEGEND:

PROJE

LA County-1200-3Bd1Ba 550

DRAWING NAME

ROOF PLAN

Client Name	CLIENT NAME:
0061_12	PROJECT NUMBER:
4/10/2025 5:04:05 PM	DATE:
Designer	DESIGNED BY:
Author	DRAWN BY:
Checker	CHECKED BY:

A103

ABOUT WALL FINISHING

STUCCO FINISH

STUCCO IS A CEMENT-BASED EXTERIOR WALL FINISH THAT OFFERS A DURABLE, WEATHER-RESISTANT, AND CUSTOMIZABLE CLADDING SOLUTION FOR BUILDINGS.


IN THIS SPECIFIC PROJECT, AMERICAN STUCCO SYSTEMS IS USED AS A FINISH MATERIAL BECAUSE IT IS GENERALLY CONSIDERED A WATER-RESISTANT EXTERIOR FINISH AND USES A THREE-COAT APPLICATION PROCESS.


3/8-INCH OF IT IS APPLIED AS AN EXTERNAL WALL FINISH AS IT IS THE MOST COMMON AND WIDELY ACCEPTED STANDARD THICKNESS FOR STUCCO EXTERIOR WALL FINISHES. THIS MULTI-LAYER APPROACH ALSO HELPS CREATE A STRONG, CRACK-RESISTANT STUCCO SURFACE.

THIS STANDARD STUCCO IS APPLIED OVER OSB SHEATHINGS (FOR COLD FORMED STRUCTURE CONSTRUCTION).

IT IS NOT DIRECTLY TROWELED OVER THE OSB BUT OVER A WATER-RESISTANT BARRIER (HOMEWRAP) AND METAL/PLASTIC LATH THAT ARE INSTALLED ON TOP SURFACE OF THE OSB TO PROVIDE AN ADDITIONAL LAYER OF PROTECTION AGAINST MOISTURE INTRUSION.

REGULAR INSPECTION AND PROMPT REPAIR OF ANY CRACKS, CHIPS, OR DAMAGE TO THE STUCCO FINISH IS IMPORTANT. THIS MAINTAINS THE STUCCO'S WATER-RESISTANT PROPERTIES OVER THE BUILDING'S LIFE SPAN.

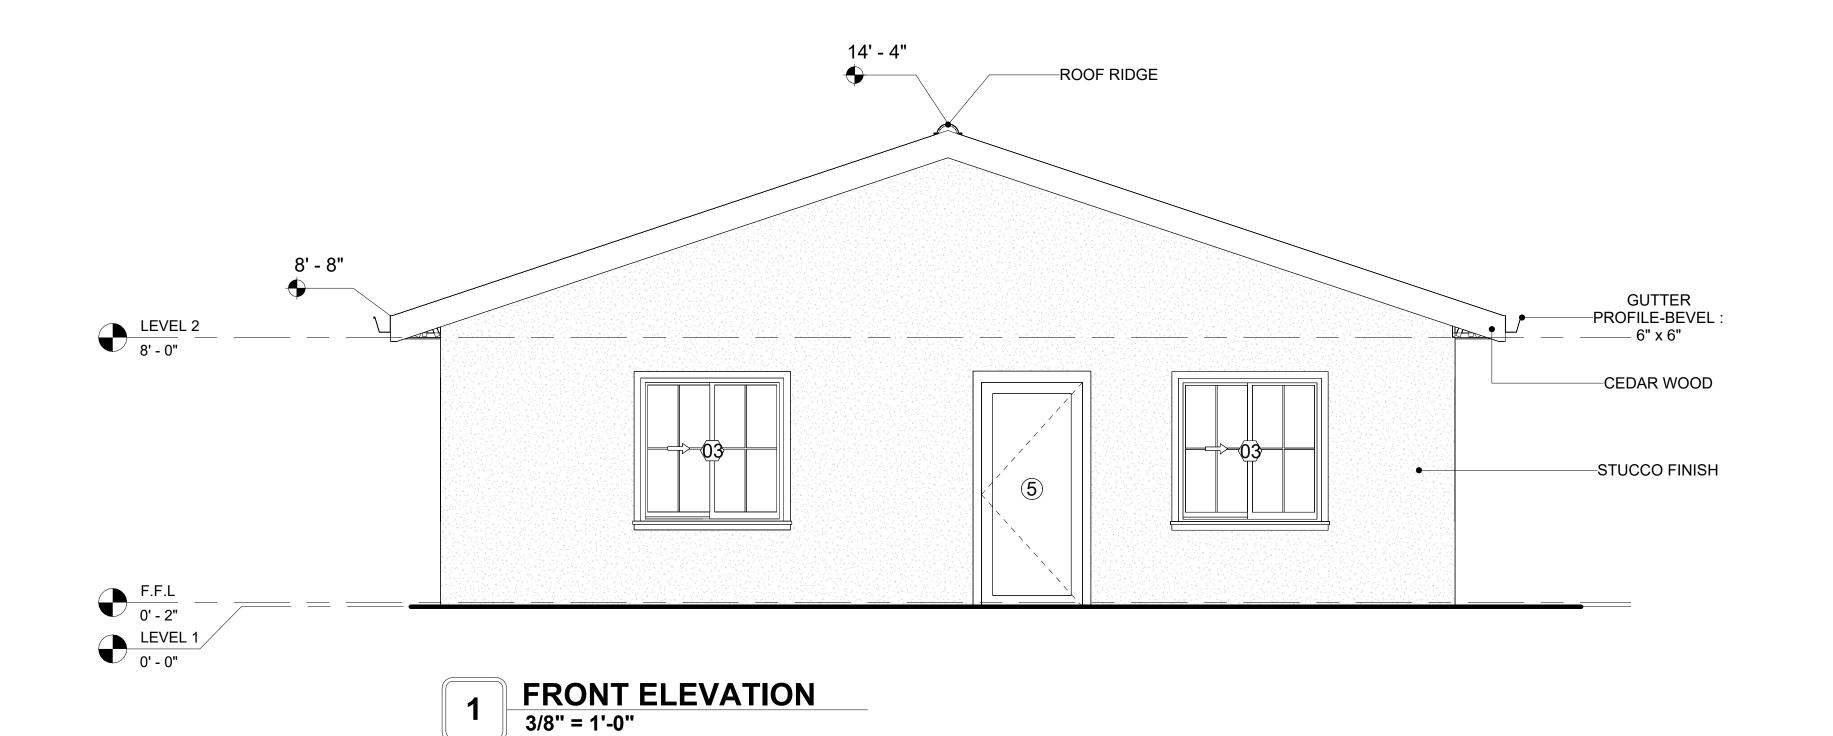


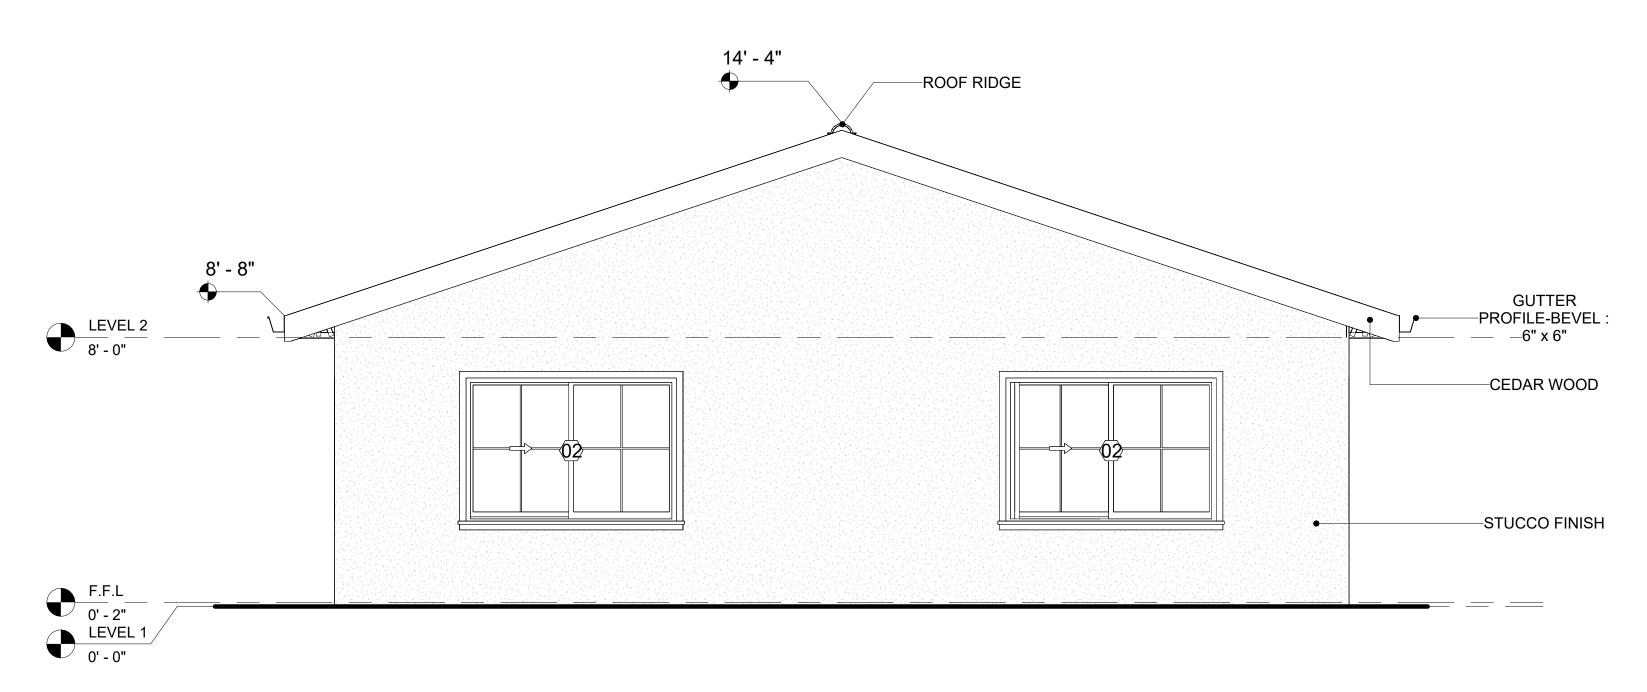

2 REAR ELEVATION 3/8" = 1'-0"

		DOOR SCH	EDULE			
TYPE				S	SIZE	
MAR K	SUPPLIER	DOOR TYPE	LOCATIO	WIDTH	HEIGHT	COUNT
1	HOME DEPOT	INTERIOR SINGLE PANEL SWINGING	INTERIOR	2' - 8"	6' - 8"	1
2	HOME DEPOT	INTERIOR SINGLE PANEL SWINGING	INTERIOR	2' - 4"	6' - 8"	3
3	HOME DEPOT	DOOR-BIFOLD_9052	INTERIOR	2' - 8"	6' - 8"	1
4	HOME DEPOT	INTERIOR DOUBLE PANEL SLIDING	INTERIOR	6' - 0"	6' - 8"	3
5	HOME DEPOT	EXTERIOR SINGLE PANEL SWINGING	INTERIOR	3' - 0"	6' - 8"	1

		WINDOV	SCHEDULE		
				SIZE	
TYPE MARK	SUPPLIER	WINDOW TYPE	WIDTH	HEIGHT	COUNT
01	HOME DEPOT	SLIDING	3' - 3"	2' - 3"	1
02	HOME DEPOT	SLIDING	6' - 3"	4' - 3"	4
03	HOME DEPOT	SLIDING	4' - 3"	4' - 3"	3

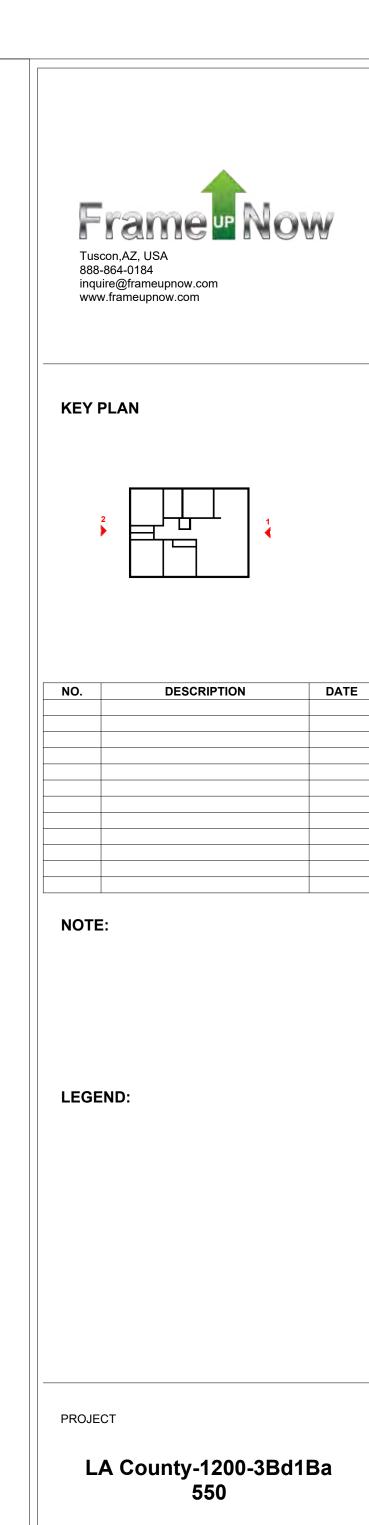

ARCHITECTURAL ELEVATIONS

CLIENT NAME:	Client Name
PROJECT NUMBER:	0061_12
DATE:	4/10/2025 5:04:08 PM
DESIGNED BY:	Designer
DRAWN BY:	Author
CHECKED BY:	Checker

ABOUT WALL FINISHING

STUCCO FINISH

STUCCO IS A CEMENT-BASED EXTERIOR WALL FINISH THAT OFFERS A DURABLE, WEATHER-RESISTANT, AND CUSTOMIZABLE CLADDING SOLUTION FOR BUILDINGS.


IN THIS SPECIFIC PROJECT, AMERICAN STUCCO SYSTEMS IS USED AS A FINISH MATERIAL BECAUSE IT IS GENERALLY CONSIDERED A WATER-RESISTANT EXTERIOR FINISH AND USES A THREE-COAT APPLICATION PROCESS.

3/8-INCH OF IT IS APPLIED AS AN EXTERNAL WALL FINISH AS IT IS THE MOST COMMON AND WIDELY ACCEPTED STANDARD THICKNESS FOR STUCCO EXTERIOR WALL FINISHES. THIS MULTI-LAYER APPROACH ALSO HELPS CREATE A STRONG, CRACK-RESISTANT STUCCO SURFACE.


THIS STANDARD STUCCO IS APPLIED OVER OSB SHEATHINGS (FOR COLD FORMED STRUCTURE CONSTRUCTION).

IT IS NOT DIRECTLY TROWELED OVER THE OSB BUT OVER A WATER-RESISTANT BARRIER (HOMEWRAP) AND METAL/PLASTIC LATH THAT ARE INSTALLED ON TOP SURFACE OF THE OSB TO PROVIDE AN ADDITIONAL LAYER OF PROTECTION AGAINST MOISTURE INTRUSION.

REGULAR INSPECTION AND PROMPT REPAIR OF ANY CRACKS, CHIPS, OR DAMAGE TO THE STUCCO FINISH IS IMPORTANT. THIS MAINTAINS THE STUCCO'S WATER-RESISTANT PROPERTIES OVER THE BUILDING'S LIFE SPAN.

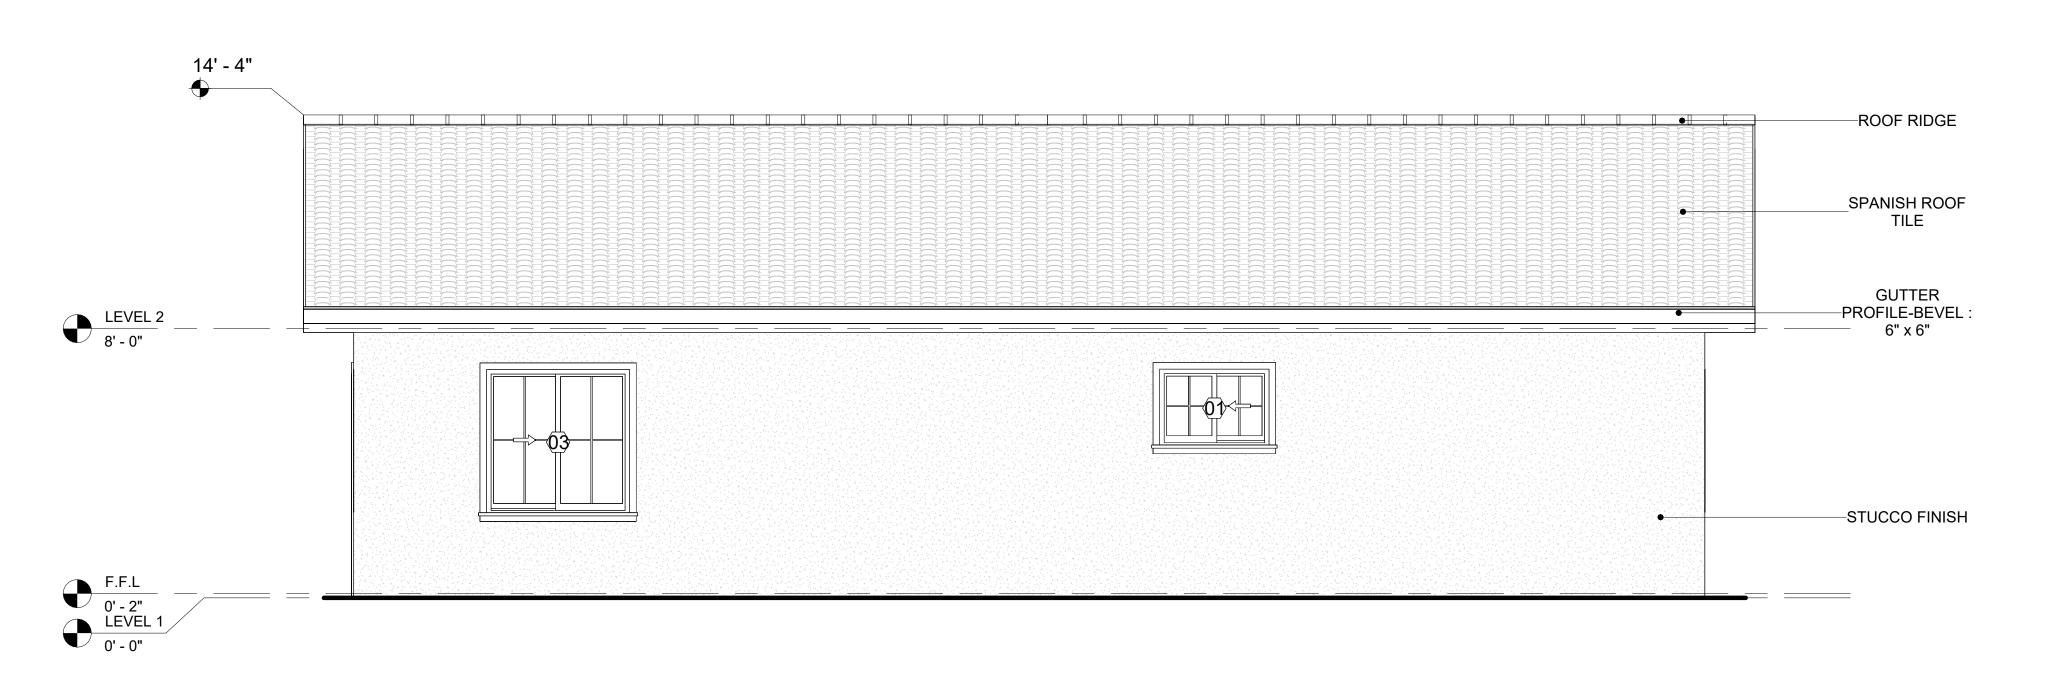


1 RIGHT SIDE ELEVATION
3/8" = 1'-0"

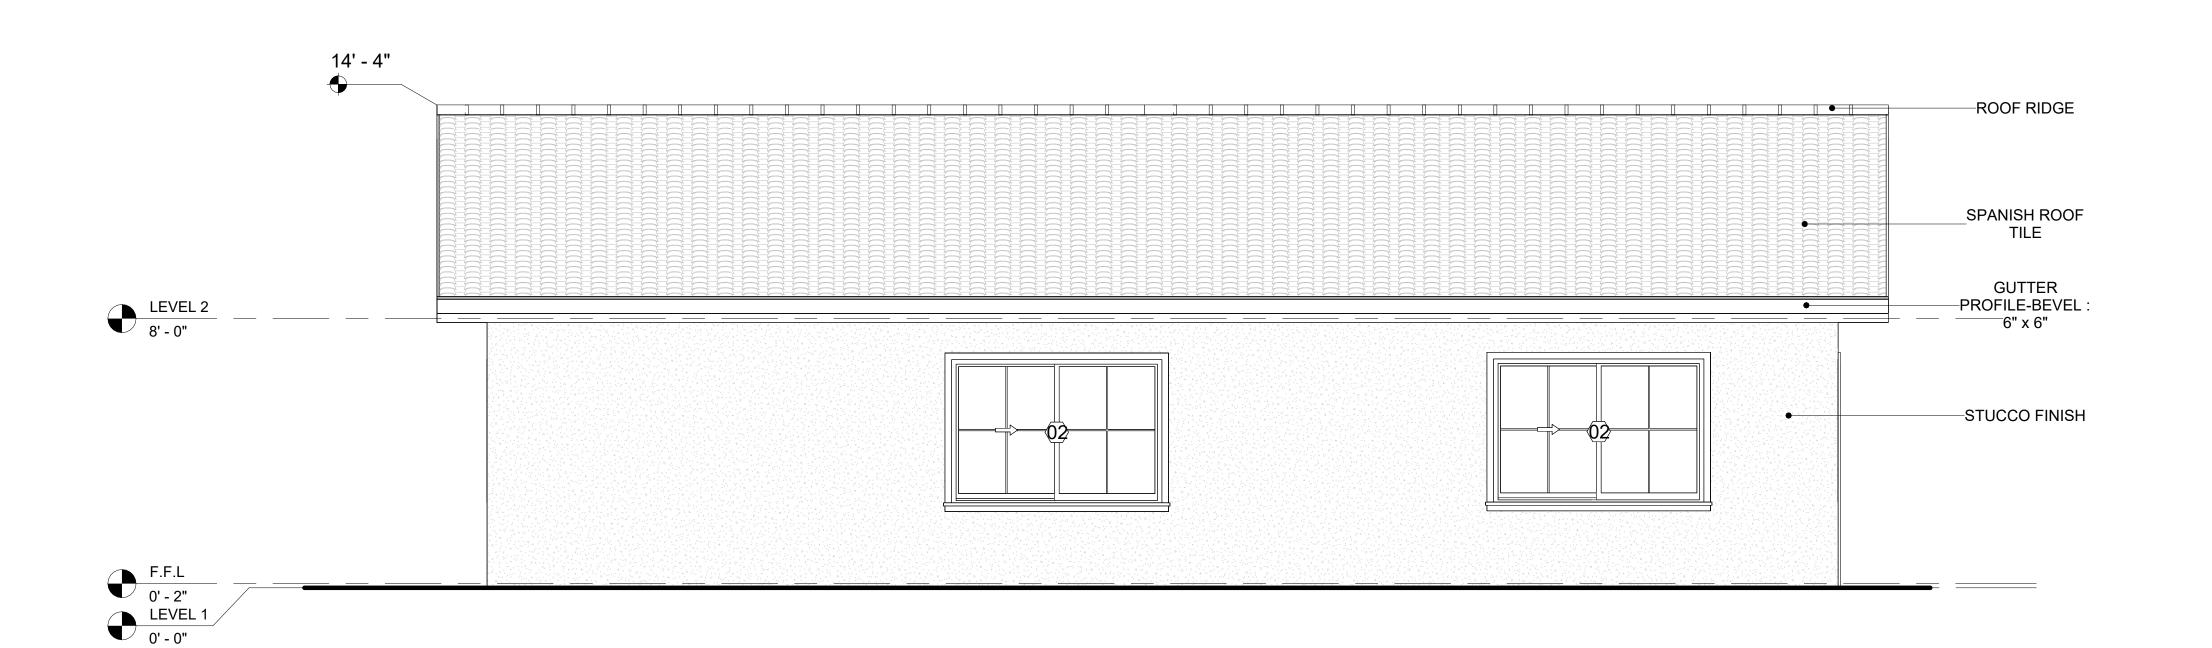

2 LEFT SIDE ELEVATION
3/8" = 1'-0"



KEY PLAN

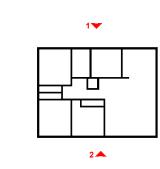

NO.	DESCRIPTION	DAT

NOTE:

LEGEND:

PROJEC


LA County-1200-3Bd1Ba 550

DRAWING NAME

ARCHITECTURAL ELEVATIONS


Client Name	CLIENT NAME:
0061_12	PROJECT NUMBER:
4/10/2025 5:04:11 PM	DATE:
Designer	DESIGNED BY:
Author	DRAWN BY:
Checker	CHECKED BY:

A202

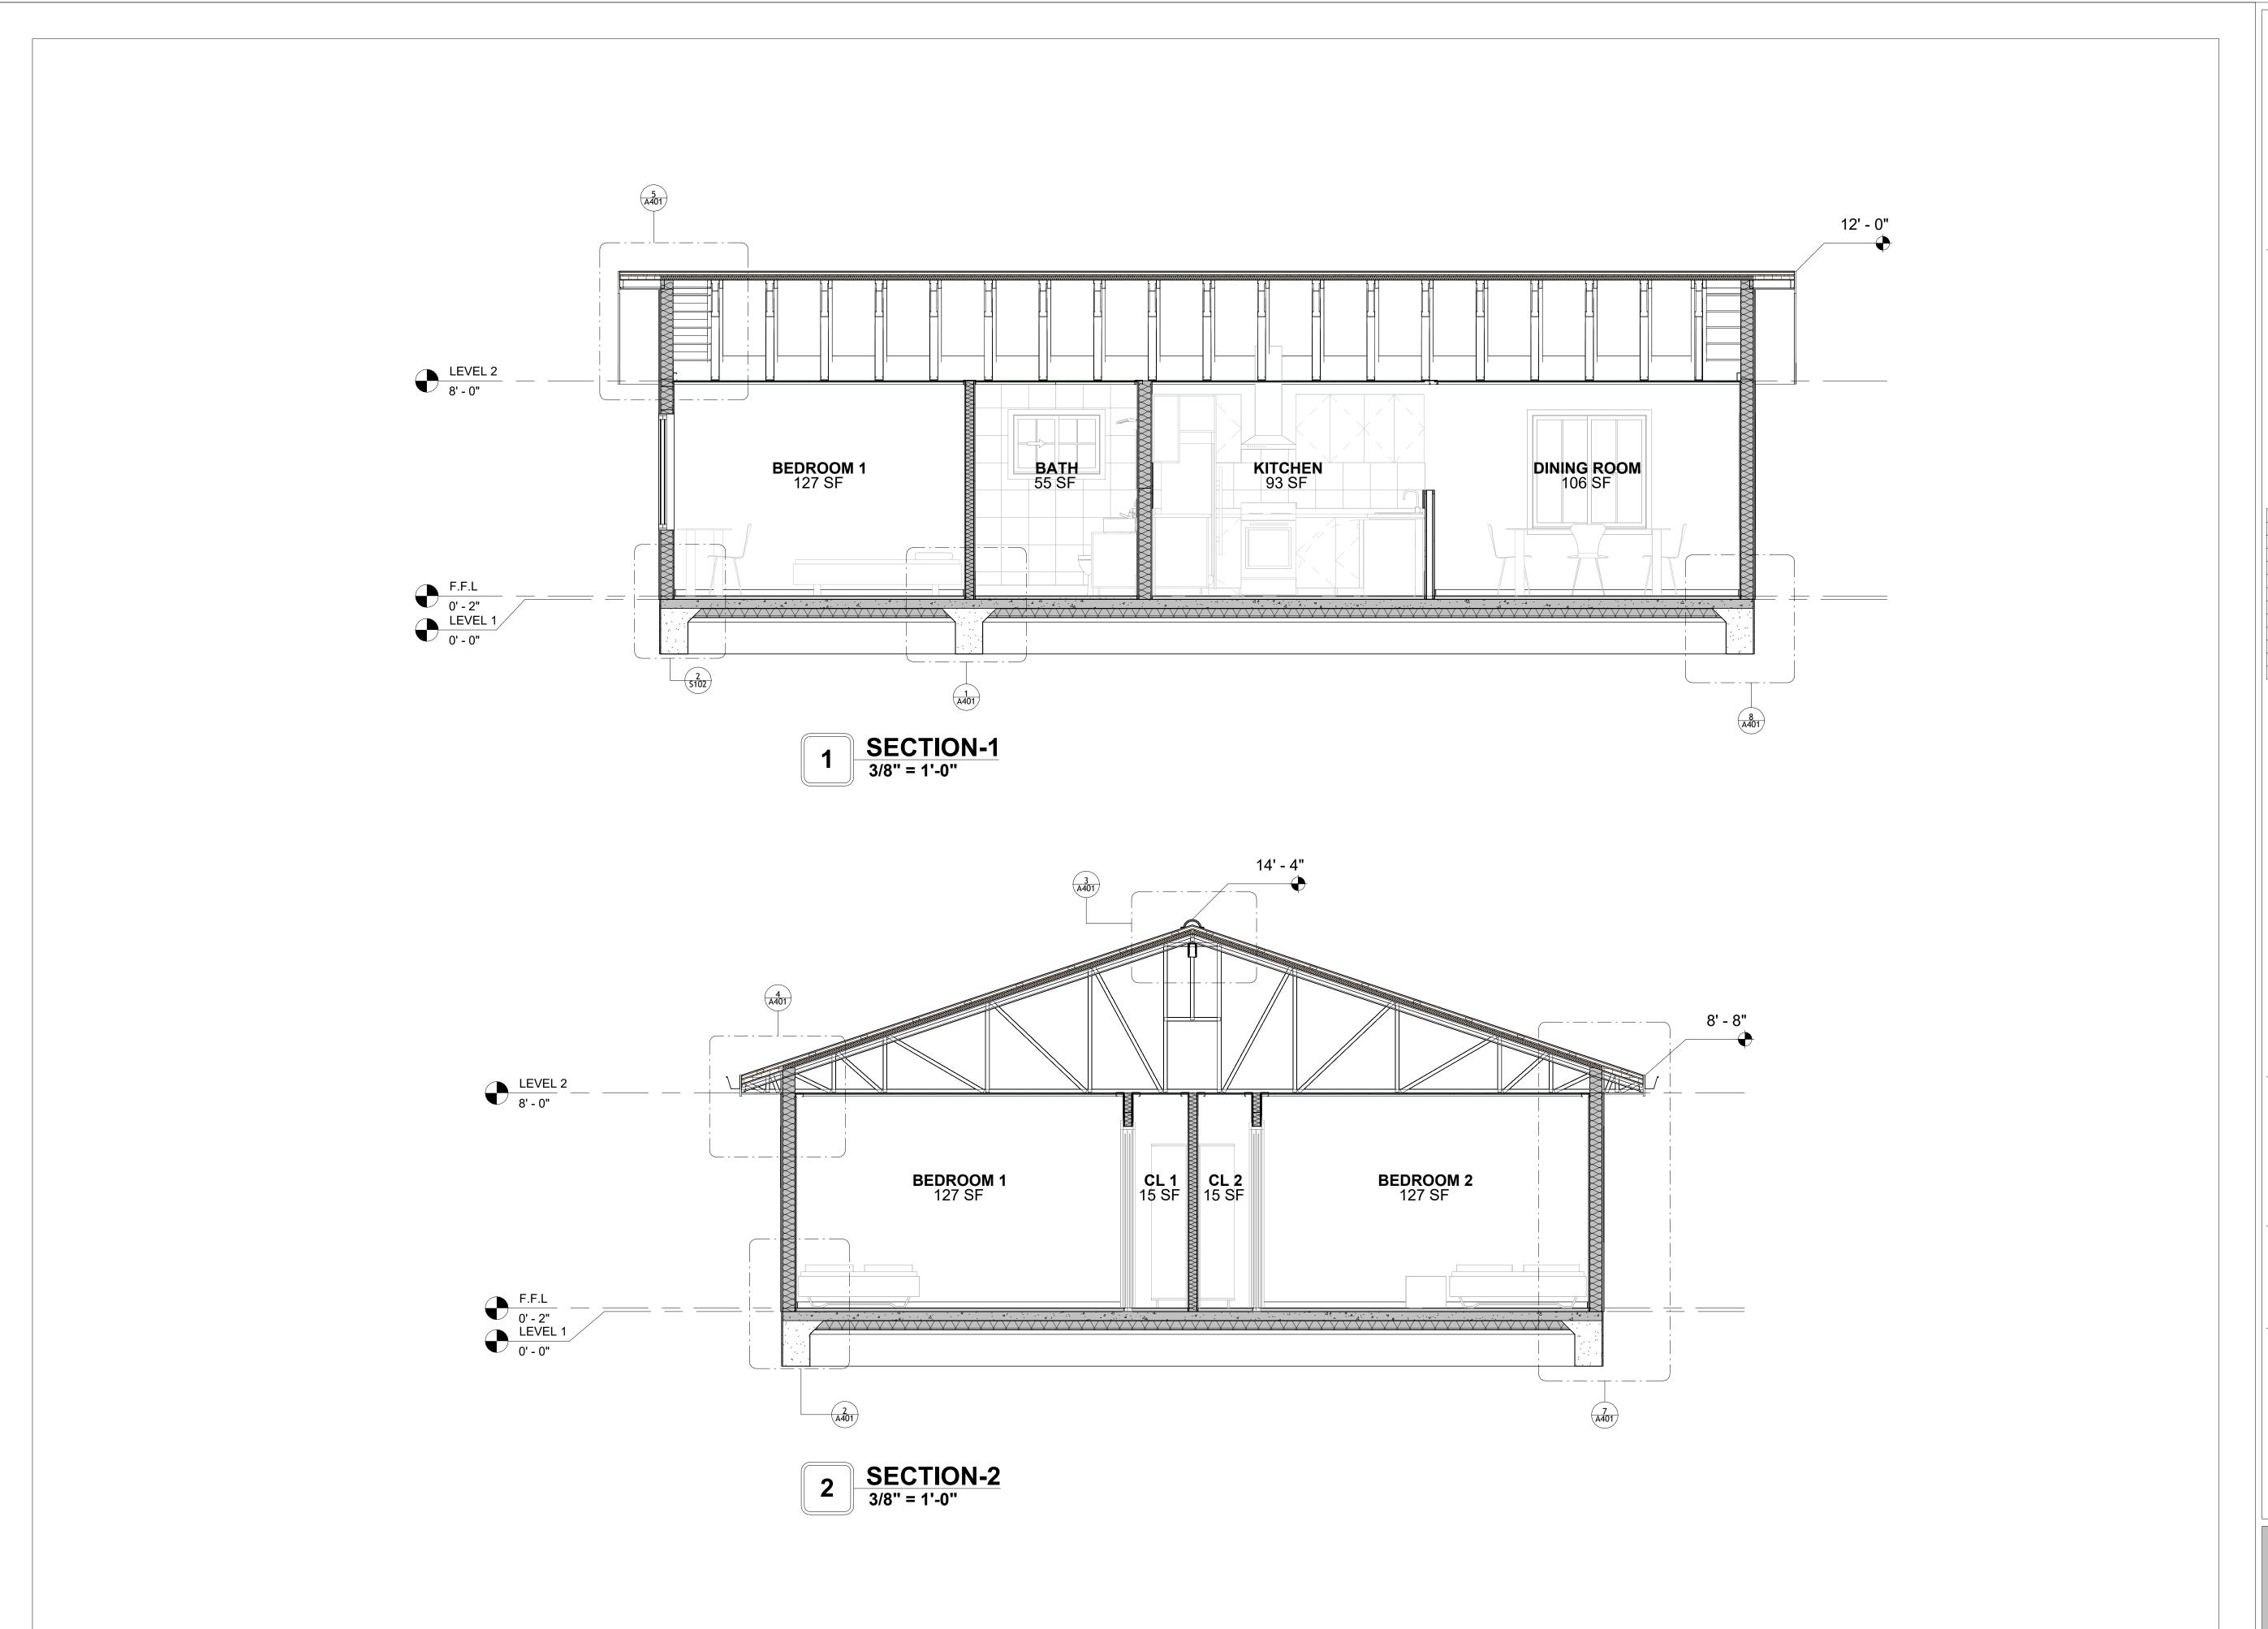



KEY PLAN

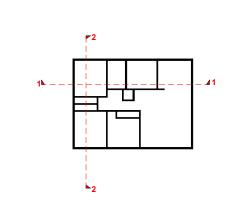

NO.	DESCRIPTION	DATE

NOTE:

LEGEND:

PROJECT


LA County-1200-3Bd1Ba 550

DRAWING NAME

ARCHITECTURAL SECTIONS

Client Name	CLIENT NAME:
0061_12	PROJECT NUMBER:
4/10/2025 5:04:13 PM	DATE:
Designer	DESIGNED BY:
Author	DRAWN BY:
Checker	CHECKED BY:

A301

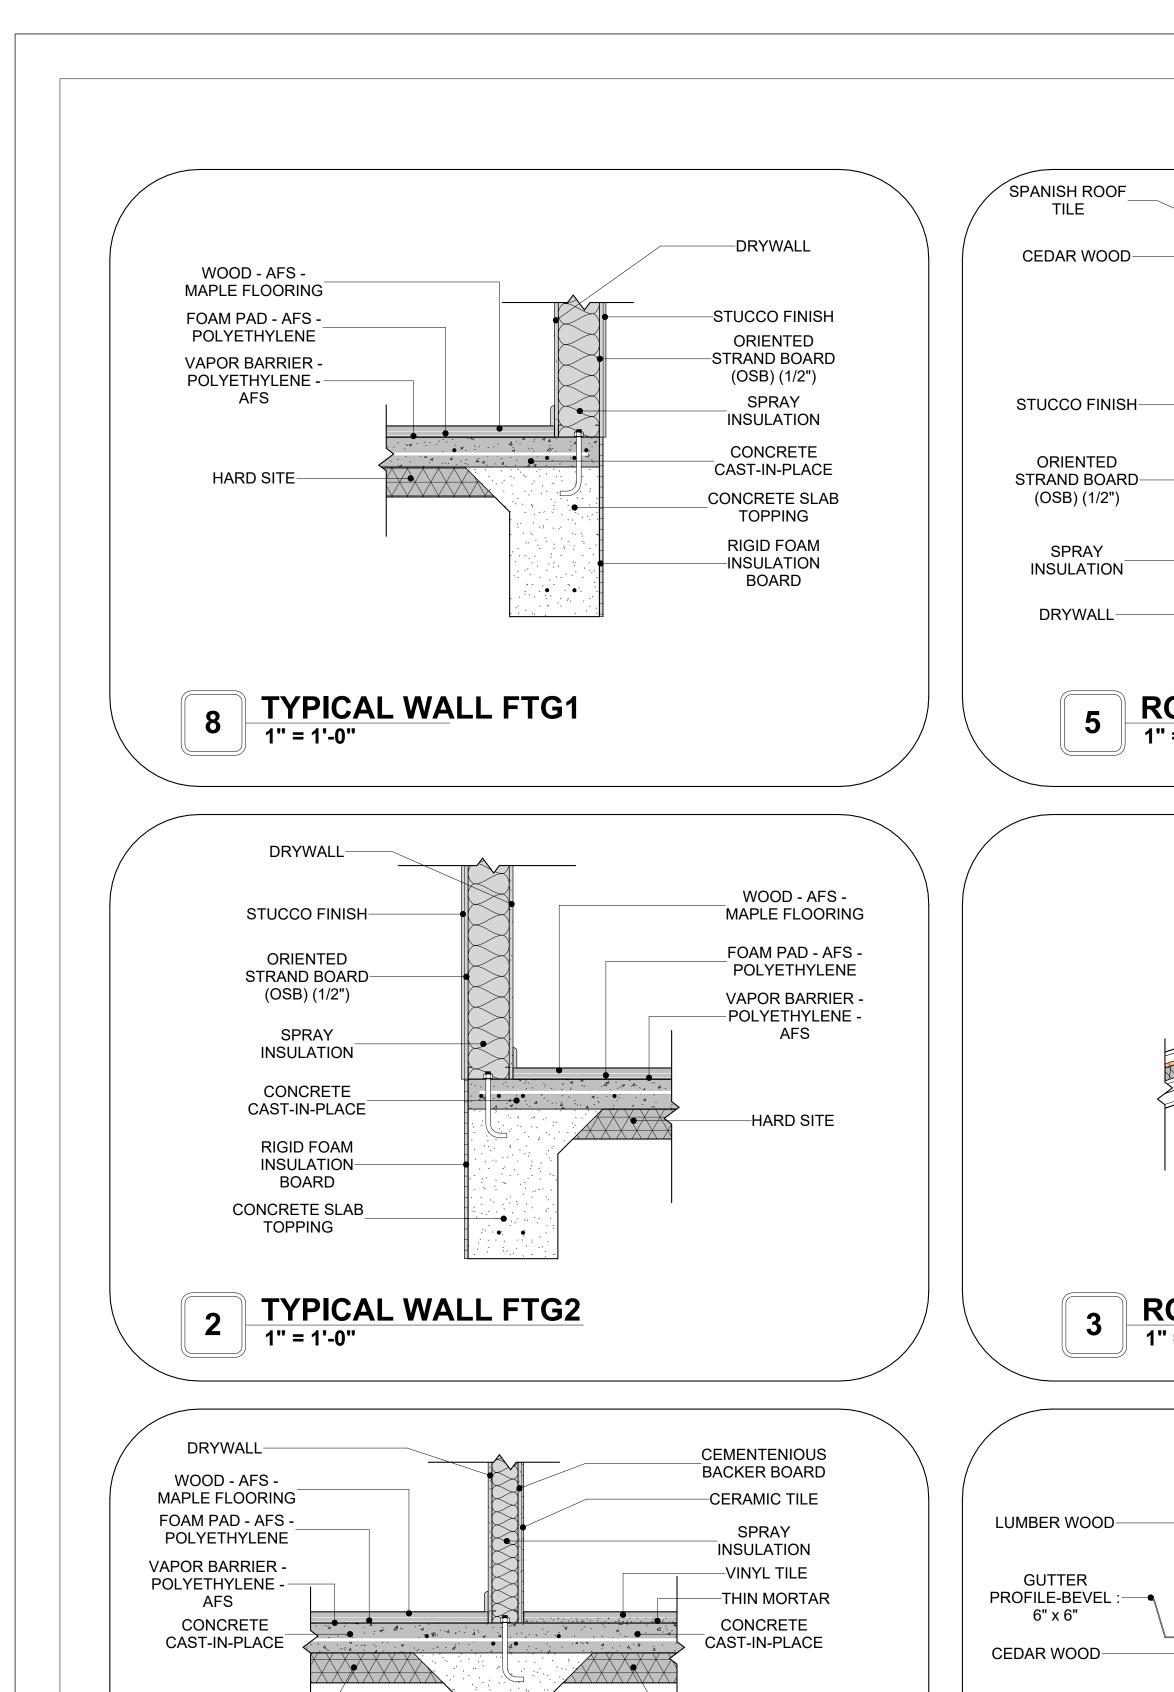

HARD SITE


CONCRETE SLAB

TOPPING

(OSB) (1/2")

•


TYPICAL WALL FTG
1" = 1'-0"

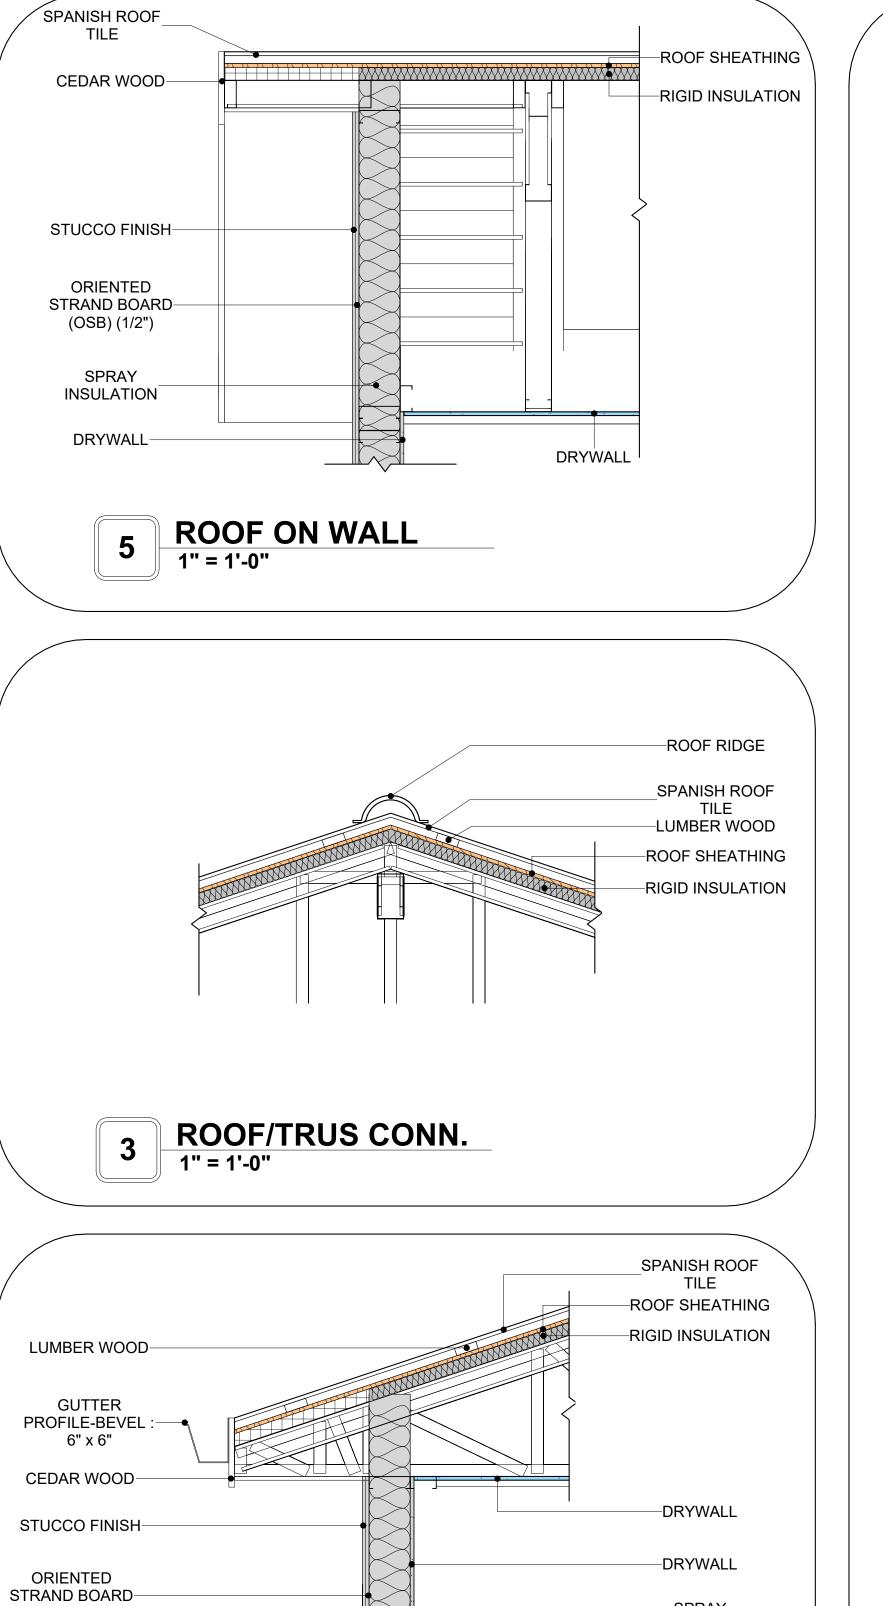

WALL TO ROOF CONN.
1" = 1'-0"

SPRAY

INSULATION

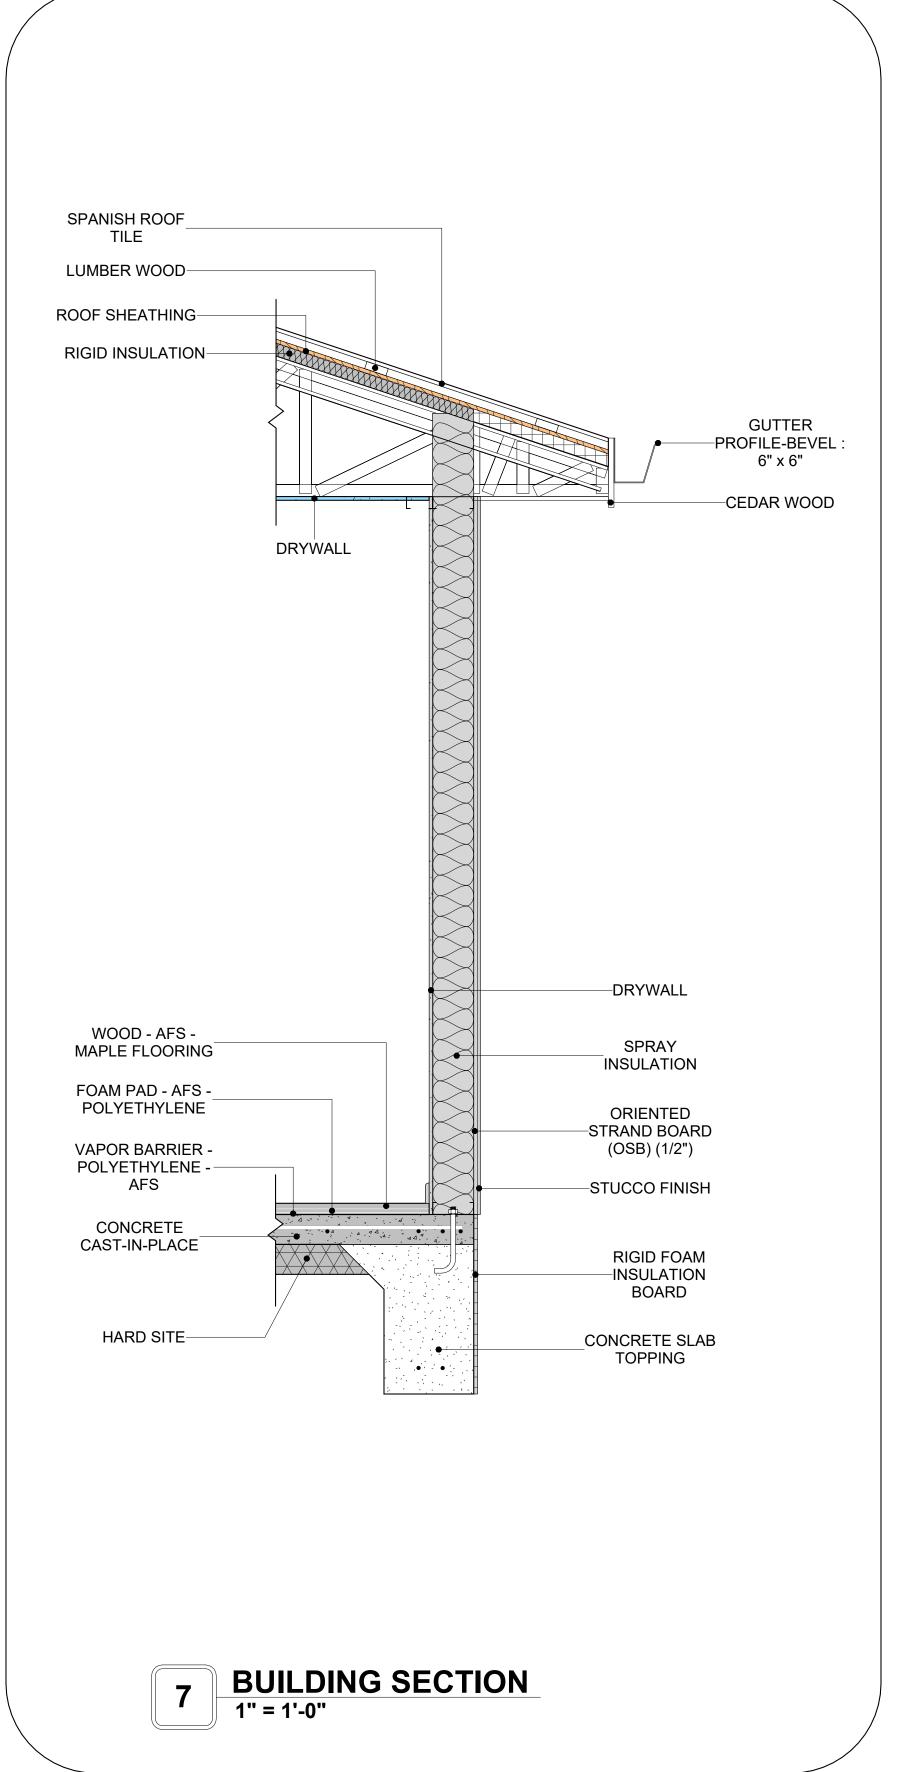



KEY PLAN

NO.	DESCRIPTION	DAT
NOTE:		
NOIE.		

LEGEND:

PROJECT

LA County-1200-3Bd1Ba 550

DRAWING NAME

ARCHITECTURAL DETAILS

Client Name	CLIENT NAME:
0061_12	PROJECT NUMBER:
4/10/2025 5:04:14 PM	DATE:
Designer	DESIGNED BY:
Author	DRAWN BY:
Checker	CHECKED BY:

A401


SCALE: 1" = 1'-0"

HARD SITE-



KEY AND SPECIFICATIONS.


- ALL CABINET HEIGHTS INCLUDE COUNTERTOPS. DIMENSIONS ARE TO THE NEAREST INCH. DIVISIONS IN CASEWORK ARE SHOWN FOR CLARITY AND DO NOT REPRESENT BREAKS IN THE
- PROVIDE CONTINUOUS COUNTERTOP OVER ALL SIMILAR HEIGHT CASEWORK, UNLESS AND OTHERWISE NOTED.
- MANUFACTURER AND CATALOG NUMBERS ARE FOR REFERENCE AND ILLUSTRATION PURPOSES
- DOTTED LINES INDICATE WALL HUNG CABINETS, DIVISIONS OF BASE CABINETS BELOW THE COUNTERTOP, FURNITURE NOT IN THE CONTRACT OR PROJECTION SCREENS -SEE CASEWORK
- ALL CABINETS AND DRAWERS TO HAVE CAM LOCKS EXCEPT FOR SINK BASE CABINETS.
- ALL EXPOSED SURFACES (EXPOSED TO VIEW FROM ANY PERSPECTIVE) TO BE COVERED WITH
- ALL CASEWORK WHICH MEETS A WALL AT ONE OR BOTH ENDS, TO BE PROVIDED WITH FILLER PANELS AND SCRIBED TO THE WALL(S) AS REQUIRED.
- 10. ALL CABINETS AND DRAWERS ARE PROVIDED WITH RECESSED HANDLES. 11. CONTRACTOR TO FIELD VERIFY ALL CLEAR OPENINGS PRIOR TO MILLWORK OR CASEWORK
- FABRICATION.
- 12. CASEWORK DRAWINGS ARE DIAGRAMMATIC IN NATURE TO SHOW DESIGN INTENT.

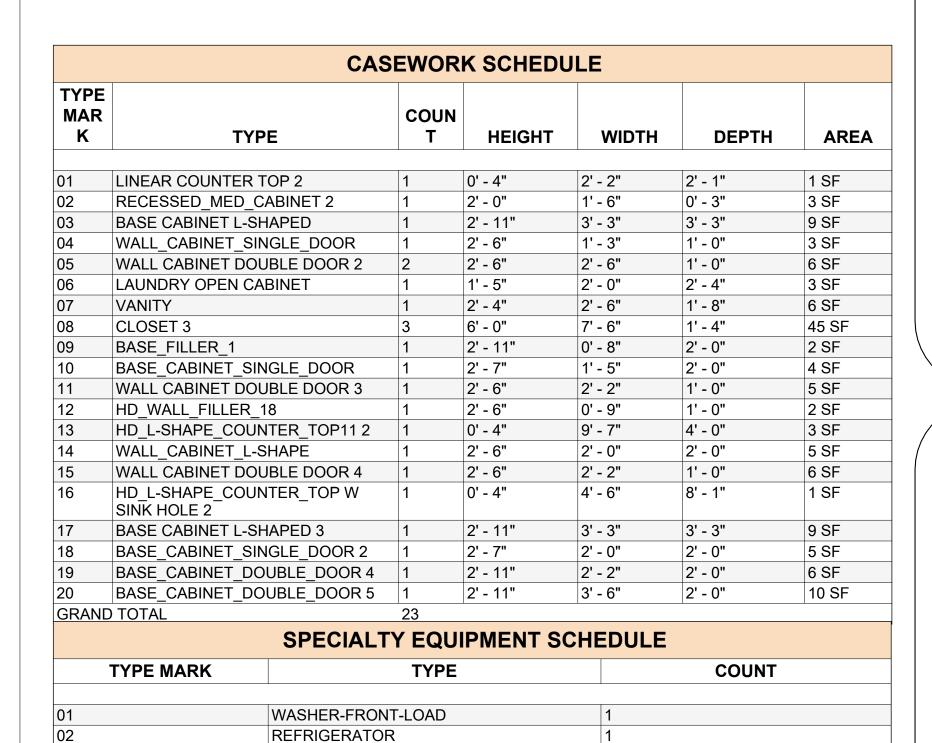



DRYER-FRONT-LOAD


DISHWASHER


GRAND TOTAL: 5

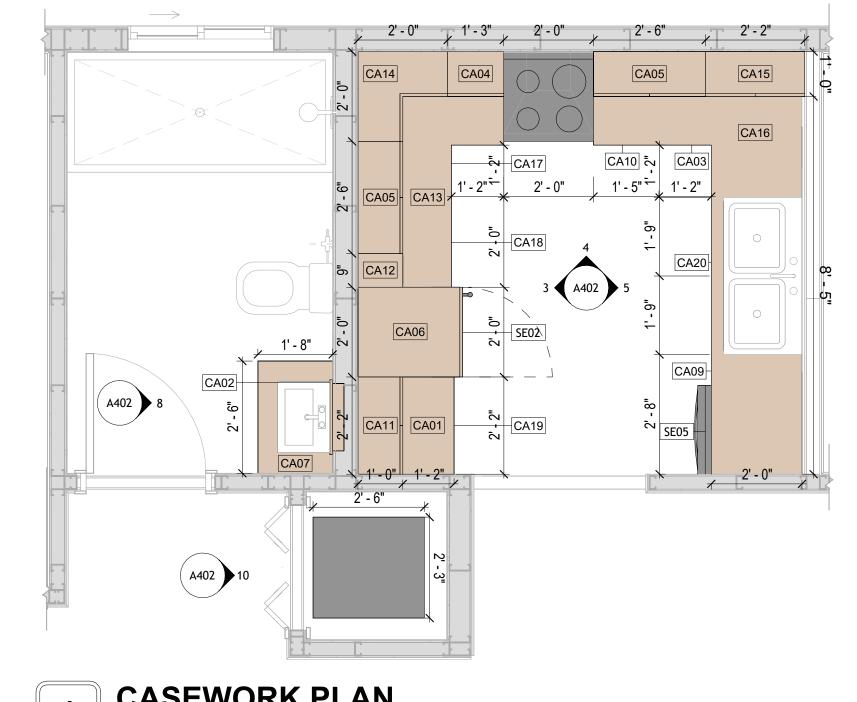

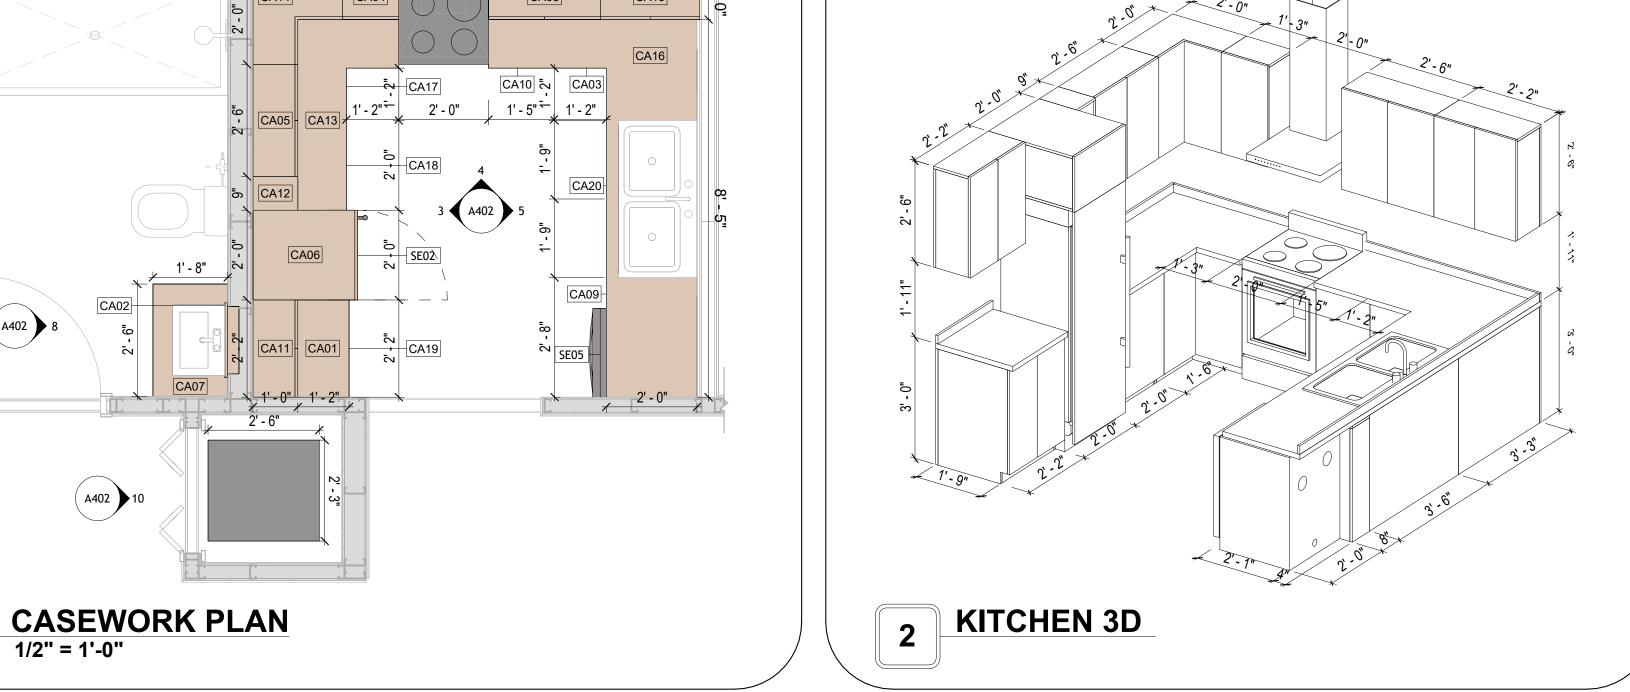


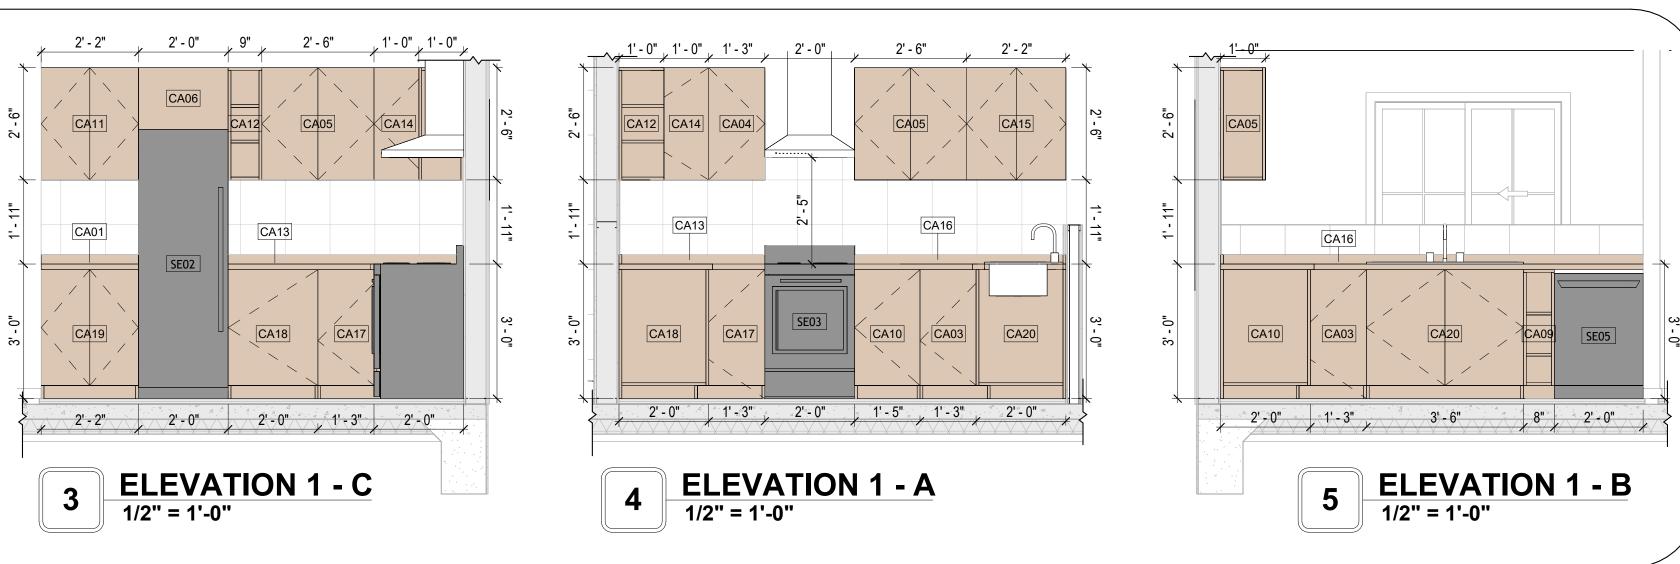


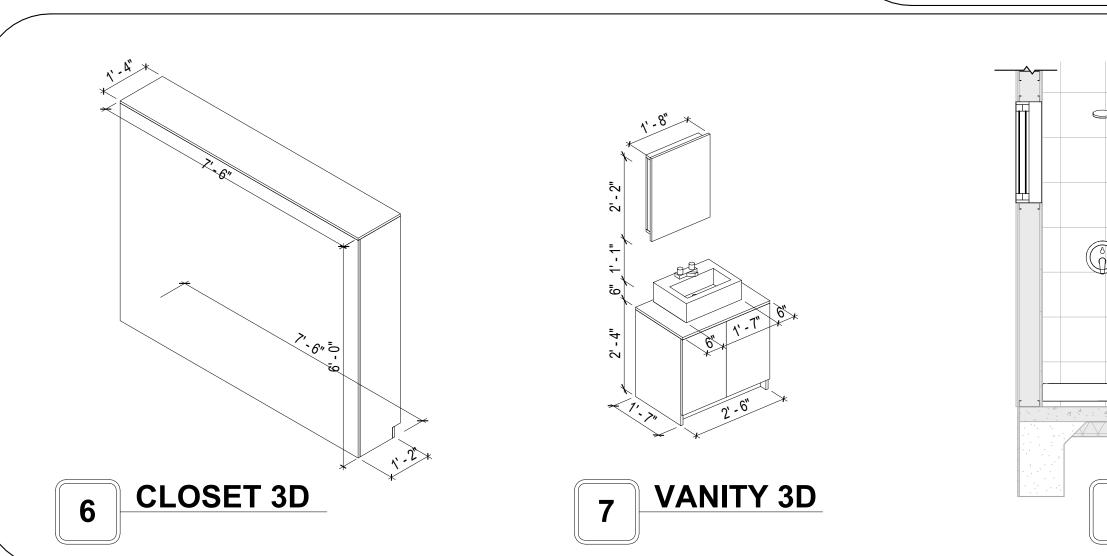

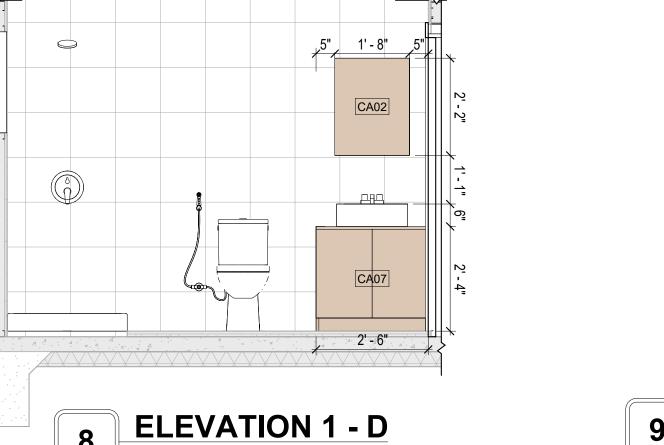

1/2" = 1'-0"

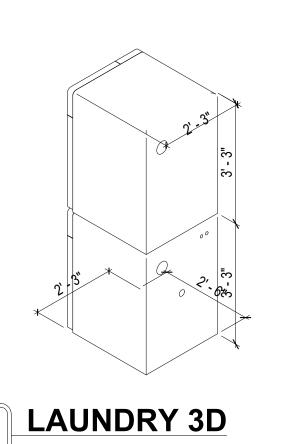


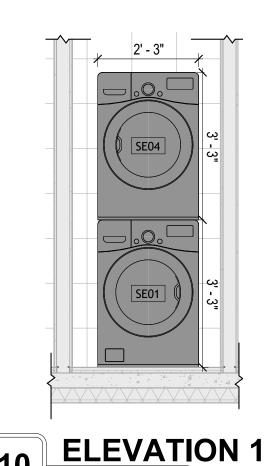

ELEVATION 1 - E 1/2" = 1'-0"



KEY PLAN

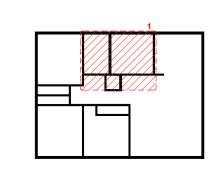

NO.	DESCRIPTION	DATE

NOTE:

LEGEND:

PROJECT

LA County-1200-3Bd1Ba

DRAWING NAME

ARCHITECTURAL CASEWORK

CLIENT NAME:	Client Name
PROJECT NUMBER:	0061_12
DATE:	4/10/2025 5:04:17 PM
DESIGNED BY:	Designer
DRAWN BY:	Author
CHECKED BY:	Checker

GENERAL NOTES

1. THIS DRAWING DEPICTS THE HVAC (HEATING, VENTILATION, AND AIR CONDITIONING) SYSTEM FOR THE LA COUNTY 3BD1BA_NG. IT PROVIDES A VISUAL REPRESENTATION OF THE SYSTEM LAYOUT AND COMPONENTS.

2.THE HVAC SYSTEM IS DESIGNED TO MEET THE SPECIFIC REQUIREMENTS OF THE BUILDING, INCLUDING HEATING, COOLING, AND VENTILATION NEEDS AS PER THE PROJECT SPECIFICATIONS AND APPLICABLE CODES AND STANDARDS.

3. THE HVAC SYSTEM INSTALLATION SHALL COMPLY WITH THE LATEST EDITION OF THE INTERNATIONAL MECHANICAL CODE (IMC), INTERNATIONAL RESIDENTIAL CODE (IRC), AND ALL OTHER APPLICABLE LOCAL, STATE, AND NATIONAL CODES AND REGULATIONS.

4. THE EQUIPMENT SHOWN ON THIS DRAWING INCLUDES BUT IS NOT LIMITED TO AIR HANDLING UNITS (AHUS), CHILLERS, BOILERS, COOLING TOWERS, PUMPS, DUCTWORK, DIFFUSERS, GRILLES, AND CONTROL DEVICES.

5. ALL EQUIPMENT, DUCTWORK, AND PIPING SHALL BE INSTALLED IN ACCORDANCE WITH MANUFACTURER'S SPECIFICATIONS, LOCAL CODES, AND INDUSTRY BEST PRACTICES

6. ALL DUCTWORK SHALL BE SIZED, FABRICATED, AND INSTALLED IN ACCORDANCE WITH THE LATEST EDITION OF THE ACCA MANUAL D AND THE SMACNA HVAC DUCT CONSTRUCTION STANDARDS. DUCTWORK SHALL BE INSTALLED IN A NEAT AND WORKMANLIKE MANNER, PROPERLY SUPPORTED AND BRACED TO PREVENT SAGGING, AIR LEAKAGE, OR VIBRATION.

7. CONDENSATE DRAINAGE PIPING SHALL BE PROPERLY PITCHED TO ENSURE POSITIVE DRAINAGE TO AN APPROVED DISPOSAL LOCATION, SUCH AS A FLOOR DRAIN, SUMP PUMP, OR EXTERIOR GRADE. CONDENSATE LINES SHALL BE INSULATED TO PREVENT SWEATING.

8. THE LOCATION OF CONTROL PANELS AND SENSORS INDICATED ON THIS DRAWING CAN BEMODIFY with THE SPECIFIC LOCATIONS AND WIRING

9. THE HVAC SYSTEM DESIGN CONSIDER ENERGY EFFICIENCY, INDOOR AIR QUALITY, OCCUPANT COMFORT, AND NOISE CONTROL, FOLLOWING APPLICABLE GUIDELINES AND REGULATIONS.

WITH THE LOCAL BUILDING DEPARTMENT AND UTILITY PROVIDERS TO ENSURE A TIMELY AND COMPLIANT INSTALLATION.

DETAILS WILL BE DETERMINED DURING THE CONTROL SYSTEM DESIGN AND INSTALLATION.

10. COORDINATION WITH OTHER TREADS HAS BEEN DONE ON A DESIGN LEVEL. THIS DRAWING SHALL BE READ TOGETHER WITH THE AR, EL AND SN DESIGN DRAWINGS TO ENSURE PROPER INSTALLATION AND INTEGRATION OF THE HVAC SYSTEMS.

11. THE HVAC CONTRACTOR IS RESPONSIBLE FOR OBTAINING ALL NECESSARY PERMITS AND LICENSES, AND FOR SCHEDULING AND COORDINATING

12. ALL DUCTWORK PENETRATIONS THROUGH WALLS, FLOORS, OR CEILINGS SHALL BE PROPERLY SEALED AND FIRE-STOPPED USING APPROVED METHODS AND MATERIALS TO MAINTAIN THE INTEGRITY OF THE BUILDING'S FIRE-RESISTANCE RATINGS.

13. HVAC EQUIPMENT SHALL BE INSTALLED LEVEL AND PLUMB, AND IN STRICT ACCORDANCE WITH THE MANUFACTURER'S INSTALLATION

INSTRUCTIONS AND RECOMMENDATIONS. PROVIDE ADEQUATE CLEARANCES AROUND EQUIPMENT FOR PROPER AIRFLOW, SERVICE ACCESS, AND CODE COMPLIANCE.

14. ALL HVAC EQUIPMENT AND COMPONENTS, INCLUDING THERMOSTATS, DAMPERS, AND ACCESS PANELS, SHALL BE LOCATED IN ACCESSIBLE AREAS FOR EASY SERVICING AND MAINTENANCE. PROVIDE ADEQUATE SPACE AROUND EQUIPMENT FOR PROPER AIRFLOW AND SERVICE ACCESS.


15. THE HVAC SYSTEM SHALL BE BALANCED AND ADJUSTED TO ENSURE PROPER AIRFLOW, TEMPERATURE DISTRIBUTION, AND SYSTEM PERFORMANC THROUGHOUT THE RESIDENCE. PROVIDE A WRITTEN REPORT DOCUMENTING THE FINAL SYSTEM BALANCE.


16. ANY DEVIATIONS OR MODIFICATIONS TO THE HVAC SYSTEM DESIGN SHALL BE REVIEWED AND APPROVED BY THE RESPONSIBLE DESIGN

PROFESSIONALS AND COMMUNICATED TO ALL RELEVANT PARTIES INVOLVED IN THE CONSTRUCTION PROCESS.

17. FOR ANY INQUIRIES OR CLARIFICATIONS REGARDING THE HVAC SYSTEM DESIGN, PLEASE CONSULT THE RESPONSIBLE DESIGN PROFESSIONALS OR THE PROJECT MANAGEMENT TEAM.

SYMBOLS

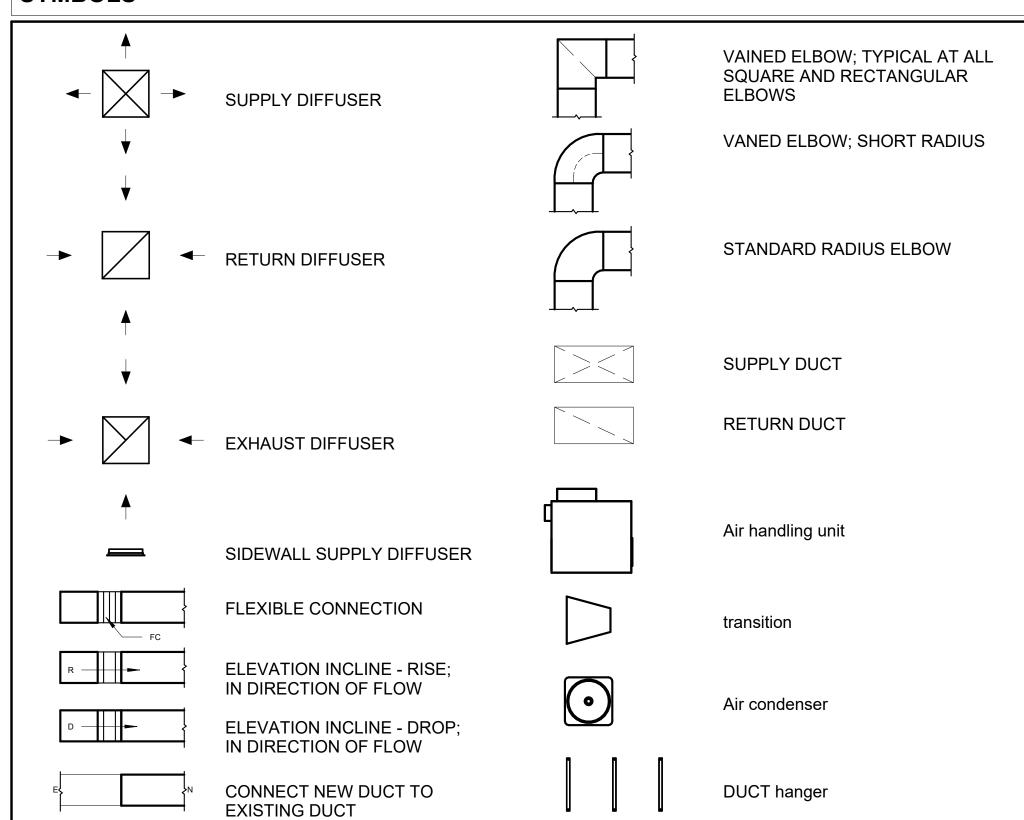

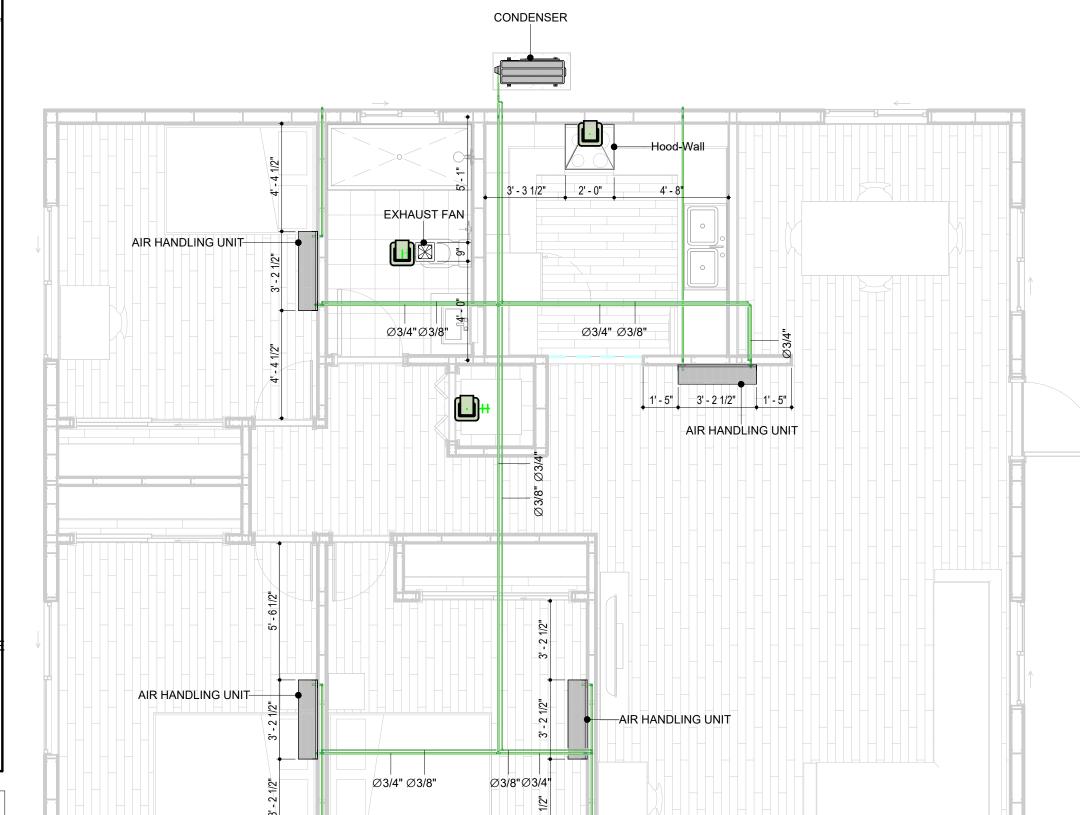

1 HVAC PLAN
1/4" = 1'-0"

Hvac Color scheme

air conditioning pipe line

REFRIGERANT LINE SCHEDULE			
CATAGORY	DESCRIPTION	DIAMETER	LENGTH
Pipe Types	Copper	3/8"	75.89
Pipe Types	Copper	3/4"	131.40

OATACODY DECODIDITION C: Co				
CATAGORY	DESCRIPTION	Size	Count	
Cross - Generic	Cross - Generic: Standard	3/4"ø-3/4"ø-3/	1	
Cioss - Generic	Cross - Generic, Standard	4"ø-3/4"ø	1	
Cross - Generic	Cross - Generic: Standard	3/8"ø-3/8"ø-3/ 8"ø-3/8"ø	1	
Elbow - Generic	Elbow - Generic: Standard/HVAC	1/2"ø-1/2"ø	2	
Elbow - Generic	Elbow - Generic: Standard/HVAC	3/4"ø-3/4"ø	34	
Elbow - Generic	Elbow - Generic: Standard/HVAC	3/8"ø-3/8"ø	22	
Tee - Generic	Tee - Generic: Standard	3/4"ø-3/4"ø-3/ 4"ø	1	
Tee - Generic	Tee - Generic: Standard	3/8"ø-3/8"ø-3/ 8"ø	1	
Transition - Generic	Transition - Generic: Standard	3/4"ø-1/2"ø	9	
Transition - Generic	Transition - Generic: Standard	3/4"ø-5/8"ø	4	
Transition - Generic	Transition - Generic: Standard	3/8"ø-1/4"ø	1	

MECHANICAL EQUIPMENT SCHEDULE		
CATAGORY	DESCRIPTION COU	
AIR HANDLING UNIT	AIR HANDLING UNIT: WALL MOUNTED	5
CONDENSER	CONDENSER: OUT DOOR 1	
Exhaust Fan	EXHAUST FAN: 75 CFM 1	
Hood-Wall: VENT 1		1

DUCT FITTING SCHEDULE		
CATAGORY	DESCRIPTION	COUNT
Round Transition - Angle	45 Degree	2

DESCRIPTION	COUNT
3" DIAMETER	

	FLEX DU	JCT SCHEDULI	E	
DESCRIPTION	DESCRIPTION	LENGTH	DIAMETER	COUNT
Flex Duct Round	FLEX-ROUND	17.49	4"	3
Grand total: 3		17.49		



KEY PLAN

NO.	DESCRIPTION	DATE

NOTE:

LEGEND:

PROJECT

LA County-1200 3Bd1Ba-550

DRAWING NAME

HVAC PLAN

CLIENT NAME:	Owner
PROJECT NUMBER:	15_0001
DATE:	4/8/2025 6:55:53 AM
DESIGNED BY:	Designer
DRAWN BY:	Author
CHECKED BY:	Checker

M101

ELECTRICAL NOTES

- 1. THIS DRAWING DEPICTS THE ELECTRICAL SYSTEM FOR THE LA County-1200-3Bd1Ba-550. IT PROVIDES A VISUAL REPRESENTATION OF THE ELECTRICAL LAYOUT AND COMPONENTS, INCLUDING POWER DISTRIBUTION, LIGHTING, AND CONTROL SYSTEMS.
- 2. THE ELECTRICAL SYSTEM IS DESIGNED TO MEET THE SPECIFIC REQUIREMENTS OF THE BUILDING, INCLUDING POWER DISTRIBUTION, LIGHTING, AND SPECIALIZED ELECTRICAL EQUIPMENT NEEDS, AS PER THE PROJECT SPECIFICATIONS AND APPLICABLE CODES AND STANDARDS.
- 3. THE ELECTRICAL SYSTEM INSTALLATION SHALL COMPLY WITH THE LATEST EDITION OF THE NATIONAL ELECTRICAL CODE (NEC), INTERNATIONAL BUILDING CODE (IBC), AND ALL OTHER APPLICABLE LOCAL, STATE, AND NATIONAL CODES AND REGULATIONS.
- 4. LOCATIONS AS NEEDED, DEVICES ARE SHOWN ON PLANS IN APPROXIMATE IDEAL LOCATIONS, UNLESS SPECIFICALLY DIMMENSIONED.
- 5. OPEN WALLS AS NEEDED TO ALLOW FOR NEW ELECTRICAL INSTALLATIONS.
- 6. LABEL ALL CIRCUITS ON JUNCTION BOXES, RECEPTACLES, DATA, SMOKE DETECTOR, AND EQUIPMENT IN PANEL BOX.
- 7. INSTALL RACEWAY AS NEEDED FOR DDC, ACCESS CONTROL, LOW VOLTAGE WIRING & DATA.
- 8. RELABEL POWER, DATA & FIRE ALARM FOR ROOM #CHANGES.
 9. VERIFY ALL CIRCUITS LABELED ON PRINT ARE CORRECT BEFORE WORKING ON THEM.
- 10. NOTE ON SITE PLAN ALL CHANGES OR MISSING DETAIL TO BE INCORPORATED INTO THE MASTER PLAN.
- 11. DRAWINGS ARE DIAGRAMMATIC ONLY FOR THE PURPOSE OF SHOWING FIXTURE AND OUTLET LOCATIONS.
- 12. ELECTRICAL CONTRACTOR TO VERIFY SERVICE SIZE BY CALCULATION BASED UPON ACTUAL NAME PLATE RATINGS OF SELECTED FOLIPMENT
- PLATE RATINGS OF SELECTED EQUIPMENT.

 13. VERIEV LOCATION OF SERVICE ENTRANCE WITH POWER COMPANY PROVIDE LIFER GROUND IN
- 13. VERIFY LOCATION OF SERVICE ENTRANCE WITH POWER COMPANY. PROVIDE UFER GROUND IN BUILDING FOUNDATION AT SERVICE ENTRANCE LOCATION.
- 14. PROVIDE A MIN. OF 20 FEET OF ONE *4 BARE COPPER UFER WIRE EMBEDDED IN CONCRETE FOOTING
- AT THE SERVICE ENTRANCE LOCATION WHERE APPROVED BY LOCAL SERVICE PROVIDER.

 15. PROVIDE WATERPROOF FIXTURES IN ALL HIGH MOISTURE AREAS (EXTERIOR, SHOWER AND TUB
- CEILINGS ETC.)
- 16. PROVIDE DEDICATED CIRCUITS TO EACH BATH, DEN, FAMILY ROOM, BEDROOM, LOFT, KITCHEN
- REFRIGERATOR, KITCHEN FREEZER DISHWASHER, AND ANY AREA/ITEM SPECIFIED BY OWNER.

 17. INCANDESCENT FIXTURES WITH OPEN OR PARTIALLY ENCLOSED LAMPS, PENDANT FIXTURES, AND
- LAMP HOLDERS ARE NOT PERMITTED IN CLOSETS.

 18. ALL WORKMANSHIP AND MATERIALS TO CONFORM WITH THE 2015 IRC.
- 19. PROVIDE A MIN. OF 20 FEET OF ONE *4 BARE COPPER UFER WIRE EMBEDDED IN CONCRETE FOOTING AT THE SERVICE ENTRANCE LOCATION WHERE APPROVED BY LOCAL SERVICE PROVIDER.
- 20. PROVIDE A BONDING CONDUCTOR CONSISTING OF A MINIMUM OF ONE *4 BARE COPPER WIRE CONNECTING THE BUILDING'S METAL WATER PIPING SYSTEM TO THE SERVICE EQUIPMENT ENCLOSURE GROUNDING.

MAIN PANEL CALCS

ELECTRICAL CALCS				
LIGHT AND OUTLETS 1,200 @ 3W	3,200 W			
3 APPLIANCE CIRCUITS	4,500 W			
DRYER	2,000 W			
WASHER	2,000 W			
RANGE	5,000 W			
WATER HEATER	5,000 W			
REFRIG.	1,800 W			
DISHWASHER & DISPOSAL	3000 W			
TOTAL	26,500 W			
FRIST 10,000 @ 100% REMAINDER @ 40% MINI. SPLIT UNITS	10,000 W 6,600W 10,000 W			
TOTAL	26,600 W			

26,600 W DIVIDED BY 240V = 111 AMPS TOTAL

(USE 200 AMP SERVICE)

ELECTRICAL ABBREVIATIONS LIST

1P	1 POLE (2P, 3P, 4P, ETC.)	CTR	CENTER	HT	HEIGHT
A	AMPERÈ	CU	COPPER	HTG	HEATING
AC	ABOVE COUNTER OR AIR CONDITIONER	DCP	DOMESTIC WATER CIRCULATING PUMP	HTR	HEATER
ACLG	ABOVE CEILING	DEPT	DEPARTMENT	HV	HIGH VOLTAGE
ADO	AUTOMATIC DOOR OPENER	DET	DETAIL	HVAC	HEATING, VENTILATING AND AIR
AF	AMP FRAME	DIA	DIAMETER	CONDITIONING	CONDITIONING
AFF	ABOVE FINISHED FLOOR	DISC	DISCONNECT	HWP	HYDRONIC WATER PUMP
AFG	ABOVE FINISHED GRADE	DIST	DISTRIBUTION	IC	INTERRUPTING CAPACITY
AFI	ARC FAULT CIRCUIT INTERRUPTER	DN	DOWN	IG	ISOLATED GROUND
AHU	AIR HANDLING UNIT	DPR	DAMPER	IMC	INTERMEDIATE METAL CONDUIT
AL	ALUMINUM	DS	SAFETY DISCONNECT SWITCH	INCAND	INCANDESCENT
ALT	ALTERNATE	DT	DOUBLE THROW	IR	INFRARED
AMP	AMPERE	DWG	DRAWING	I/W	INTERLOCK WITH
AMPL	AMPLIFIER	DDC	DIRECT DIGITAL CONTROL	J-BOX	JUNCTION BOX
ANNUN	ANNUNCIATOR APPROX APPROXIMATELY	EC	ELECTRICAL CONTRACTOR	KV	KILOVOLT
AQ-STAT	AQUASTAT	ELEC	ELECTRIC, ELECTRICAL	KVA	KILOVOLT-AMPERE
ARCH	ARCHITECT, ARCHITECTURAL	ELEV	ELEVATOR	KVAR	KILOVOLT-AMPERE REACTIVE
AS	AMP SWITCH	EM	EMERGENCY	KW	KILOWATT
AT	AMP TRIP	EMS	ENERGY MANAGEMENT SYSTEM	KWH	KILOWATT HOUR
ATS	AUTOMATIC TRANSFER SWITCH	EMT	ELECTRICAL METALLIC TUBING	LOC	LOCATE OR LOCATION
AUTO	AUTOMATIC	EP	ELECTRIC PNEUMATIC	LT	LIGHT
AUX	AUXILIARY	EQUIP	EQUIPMENT	LTG	LIGHTING
AV	AUDIO VISUAL	EWC	ELECTRIC WATER COOLER	LTNG	LIGHTNING
AWG	AMERICAN WIRE GAUGE	EXIST	EXISTING	LV	LOW VOLTAGE
BATT	BATTERY	EXH	EXHAUST	MAX	MAXIMUM
BD	BOARD	EXP	EXPLOSION PROOF	MAG.S	MAGNETIC STARTER
BLDG	BUILDING	FA	FIRE ALARM	M/C	MOMENTARY CONTACT
BMS	BUILDING MANAGEMENT SYSTEM	FABP	FIRE ALARM BOOSTER POWER	MC	MECHANICAL CONTRACTOR
С	CONDUIT	SUPPLY PANEL	SUPPLY PANEL	MCB	MAIN CIRCUIT BREAKER
CAB	CABINET	FACP	FIRE ALARM CONTROL PANEL	MCC	MOTOR CONTROL CENTER
CAT	CATALOG	FCU	FAN COIL UNIT	MDC	MAIN DISTRIBUTION CENTER
CATV	CABLE TELEVISION	FIXT	FIXTURE	MDP	MAIN DISTRIBUTION PANEL
СВ	CIRCUIT BREAKER	FLR	FLOOR	MFR	MANUFACTURERMAIN FUSED
CCTV	CLOSED CIRCUIT TELEVISION	FLUOR	FLUORESCENT		DISCONNECT SWITCH
CKT	CIRCUIT	FU	FUSE	MH	MANHOLE
CLG	CEILING	FUDS	FUSED SAFETY DISCONNECT SWITCH	MIC	MICROPHONE
COMB	COMBINATION	GA	GAUGE	MIN	MINIMUM
CMPR	COMPRESSOR	GAL	GALLON	MISC	MISCELLANEOUS
CONN	CONNECTION	GALV	GALVANIZED	MLO	MAIN LUGS ONLY
CONST	CONSTRUCTION	GC	GENERAL CONTRACTOR	MMS	MANUAL MOTOR STARTER
CONTR	CONTINUATION OR CONTINUOUS	GEN	GENERATOR	MOA	MULTIOUTLET ASSEMBLY
CONTR	CONTRACTOR	GFI	GROUND FAULT CIRCUIT INTERRUPTER	MSP	MOTOR STARTER PANELBOARD
CONV	CONVECTOR	GFP	GROUND FAULT PROTECTOR	MSBD	MAIN SWITCHBOARD
CP	CIRCULATING PUMP	GND	GROUND	MT	MOUNT
CRT CT	CATHODE-RAY TUBE	GRS	GALVANIZED RIGID STEEL (CONDUIT)	MT.C	EMPTY CONDUIT
	CURRENT TRANSFORMER	GYP BD	GYPSUM BOARD	UL	UNDERWRITERS LABORATORIES
			1		

Branch Panel:

Location: KITCHEN 02
Supply From:
Mounting: Recessed

Enclosure: Type 1

Volts: 120/240 Single
Phases: 1
Wires: 3

A.I.C. Rating:
Mains Type:
Mains Rating: 200 A
MCB Rating: 1 A

Not

Circuit Numb er		Number of Elements	Rating	Length	Wire Size	A		ı	3	Wire Size	Length	Rating	Number of Elements	Circuit Description	Circui Numb er
1	BED 1& 2 LIGHT	17	20 A	54' - 3 11/32"	1-#12, 1-#12, 1-#12	956 VA	576 VA			1-#12, 1-#12, 1-#12	27' - 8 3/4"	20 A	6	BATH GFCI	2
3	BED 3 LIGHT	14	15 A	43' - 3 7/32"	1-#14, 1-#14, 1-#14			748 VA	240 VA	1-#14, 1-#14, 1-#14	16' - 2 15/16"	15 A	5	KITCHEN LIGHT	4
5	DINNING LIGHT	9	15 A	32' - 8 11/16"	1-#14, 1-#14, 1-#14	412 VA	321 VA			1-#12, 1-#12, 1-#12	44' - 0 3/4"	20 A	11	LIVING LIGHT	6
7	KITCHEN GFCI	5	20 A	19' - 4 5/8"	1-#12, 1-#12, 1-#12			900 VA	2500 VA	2-#8, 1-#8, 1-#10	11' - 6 5/8"	50 A	1	RANGE	8
9	REFRIGERATOR	1	20 A	21' - 7 1/8"	1-#12, 1-#12, 1-#12	1800 VA	2500 VA								10
11	OVEN HOOD	1	20 A	6' - 1 5/8"	1-#12, 1-#12, 1-#12			180 VA	1200 VA	1-#12, 1-#12, 1-#12	21' - 8 1/8"	20 A	1	DISHWASHER	12
13	BED 1 & 2 RECEPTACLE	8	20 A	61' - 11 3/32"	1-#10, 1-#10, 1-#10	1440 VA	900 VA			1-#12, 1-#12, 1-#12	48' - 2 1/2"	20 A	5	BED 3 RECEPTACLE	14
15	DIN./LIV. RECEPTACLE	10	20 A	51' - 8 3/8"	1-#10, 1-#10, 1-#10			1800 VA	540 VA	1-#12, 1-#12, 1-#12	41' - 6 13/16"	20 A	3	OUTDOOR GFCI	16
17	WASHER	1	20 A	27' - 9"	1-#12, 1-#12, 1-#12	1200 VA	2500 VA			2-#10, 1-#10, 1-#10	24' - 9 5/8"	30 A	1	DRYER	18
19	CONDENSER	1	60 A	15' - 9 1/4"	2-#6, 1-#6, 1-#10			2500 VA	2500 VA						20
21						2500 VA	2250 VA			2-#10, 1-#10, 1-#10	21' - 0 7/8"	30 A	1	WATER HEATER	22
23									2250 VA						24
25															26
	1					17350) VA	1535	7 VA						

Legend	:

Load Classification	Connected Load	Demand Factor	Estimated Demand	Panel	Totals
LIGHTING - DWELLING UNIT	100 VA	100.00%	100 VA		
OTHER	2412 VA	100.00%	2412 VA	Total Conn. Load:	32707 VA
RECEPTACLE	8520 VA	100.00%	8520 VA	Total Est. Demand:	31707 VA
LIGHTING	400 VA	100.00%	400 VA	Total Conn.:	136 A
CONDENSER	5000 VA	100.00%	5000 VA	Total Est. Demand:	132 A
WATER HEATER	4500 VA	100.00%	4500 VA		
RANGE	5000 VA	80.00%	4000 VA		
DRYER	5000 VA	100.00%	5000 VA		
REFRIGERATOR	1800 VA	100.00%	1800 VA		

128 A

Tuscon,AZ, USA 888-864-0184 inquire@frameupnow.com www.frameupnow.com

KEY PLAN

NO. DESCRIPTION DATE

NOTE:

LEGEND:

PROJECT

LA County-1200-3Bd1Ba-550

DRAWING NAME

SCHEDULE

CLIENT NAME:

PROJECT NUMBER:

0388_13

DATE:

4/7/2025 4:49:19 PM

DESIGNED BY:

DRAWN BY:

CHECKED BY:

Checker

E101

SCALE: 1/4" = 1'-0"

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ELECTRICAL NOTE

- A. PROVIDE INTERCONNECTED SMOKE ALARMS IN EACH SLEEPING ROOMS, OUTSIDE EACH SLEEPING ROOM, ON EACH STORY, IN THE HALL OR ADJACENT ROOM LUHERE THE CEILING HEIGHT OF A ROOM OPEN TO THE HALL EXCEEDS THE HALL BY 24'. SMOKE ALARMS SHALL BE PERMANENTLY HARD WIRED WITH BATTERY BACKUP.
- B. RECEPTACLE OUTLETS FOR RANGES AND CLOTHES DRYERS SHALL BE A THREE POLE WITH GROUND TYPE. FOUR WIRE GROUNDING-TYPE FLEXIBLE CORDS WILL BE REQUIRED FOR CONNECTION OF RANGES AND CLOTHES DRYERS. THE BONDING JUMPER SHALL NOT BE CONNECTED BETWEEN NEUTRAL TERMINAL AND THE FRAME OF THE APPLIANCE.
- C. TWO OR MORE 20 AMP SMALL APPLIANCE CIRCUITS SHALL BE PROVIDED TO SERVE THE KITCHEN, BREAKFAST NOOK, AND DINING ROOM. SUCH CIRCUITS SHALL HAVE NO OTHER OUTLETS.
- D. AT LEAST ONE 20 AMP BRANCH CIRCUIT SHALL BE PROVIDED TO SERVICE THE LAUNDRY ROOM. THIS CIRCUIT SHALL HAVE NO OTHER OUTLETS.
- E. ALL RECEPTACLES WITH IN 6' OF A WET BAR SINK OR KITCHEN SINK TO SERVE COUNTER TOP SURFACES MUST BE GFCI. ON KITCHEN COUNTERS 12' OR WIDER NO POINT ALONG THE WALL SHALL BE MORE THAN 2' FROM A RECEPTACLE. ALL RECEPTACLES WITH IN 6' OF KITCHEN SINK MUST BE GFCI. AT LEAST ONE GFCI RECEPTACLE SHALL BE INSTALLED IN THE BATHROOM ADJACENT TO EACH BASIN.
- F. FIXTURES INCLUDING CEILING FANS THAT ARE LOCATED IN DAMP LOCATIONS SHALL BE LISTED TO BE SUITABLE FOR
- SUCH LOCATIONS PER 2012 IRC
- G. PROVIDE ONE (1) SWITCHED OUTLET @ ALL BEDROOMS AND DEN
- H. CEILING FANS NOT EXCEEDING 35 LBS. (WITH OR WITHOUT ACCESSORIES MAY BE SUPPORTED BY OUTLET BOXES PROVIDED THE OUTLET BOXES ARE IDENTIFIED FOR SUCH USE PER 2012 IRC
- I. ELECTRICAL OUTLET BOXES ON OPPOSITE SIDES OF FIRE RATED WALLS SHALL BE SEPARATED BY A HORIZONTAL DISTANCE OF NOT LESS THAN 24".
- J. OUTLET BOXES IN THE WALLS BETWEEN THE GARAGE AND DWELLING SHALL BE METAL OR U.L. APPROVED FIRE RESISTIVE PLASTIC. BOXES IN GARAGE CEILING SHALL BE METAL.
- K. ALL BRANCH CIRCUITS THAT SUPPLY 120 VOLTS SINGLE PHASE 15 AND 20 AMPS RECEPTACLE OUTLETS INSTALLED IN THE DWELLING SHALL BE PROTECTED BY AN ARC FAULT CIRCUIT INTERRUPTER, EXCEPT GFCI RECEPTICLES.

NOTE:

A. RECEPTACLES MUST BE PROVIDED IN HALLWAYS 10'-0" OR MORE IN LENGTH. FOR A ONE FAMILY DWELLINGS AND EACH OF A TWO FAMILY DWELLING THAT IS AT GRADE LEVEL, AT LEAST ONE WP-GFCI RECEPTACLE OUTLET ACCESSIBLE AT GRADE LEVEL AND NOT MORE THAN 6'-6" ABOVE GRADE SHALL BE INSTALLED AT THE FRONT AND BACK OF THE DWELLING.

NOTE: APPLIANCE DISCONNECT

E4001.5 GROUNDING OF ENCLOSURES.

METAL ENCLOSURES FOR SWITCHES OR CIRCUIT BREAKERS SHALL BE CONNECTED TO AN

EQUIPMENT GROUNDING CONDUCTOR.

METAL ENCLOSURES FOR SWITCHES OR CIRCUIT BREAKERS USED AS SERVICE EQUIPMENT SHALL COMPLY WITH THE PROVISIONS OF SECTION E3609.4. WHERE


NONMETALLIC ENCLOSURES ARE USED WITH METAL RACEWAYS OR METAL-ARMORED


CABLES. PROVISIONS SHALL BE MADE FOR CONNECTING THE EQUIPMENT GROUNDING

CONDUCTOR.


NONMETALLIC BOXES FOR SWITCHES SHALL BE INSTALLED WITH A WIRING METHOD THAT

PROVIDES OR INCLUDES AN EQUIPMENT GROUNDING CONDUCTOR. (404.12)

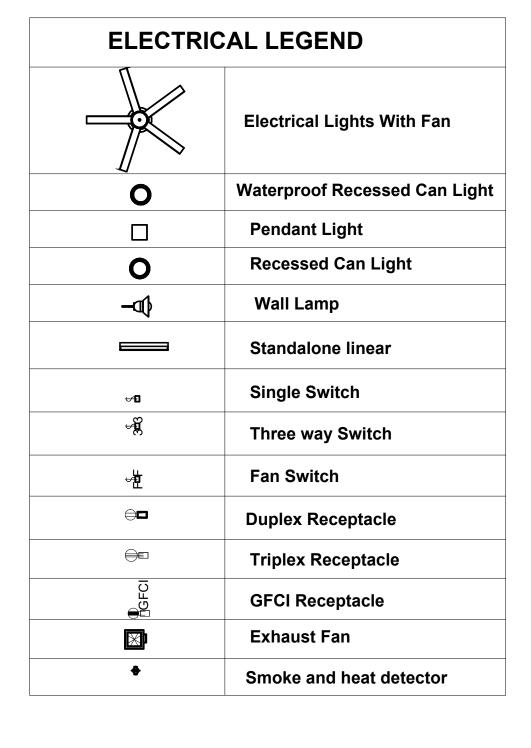

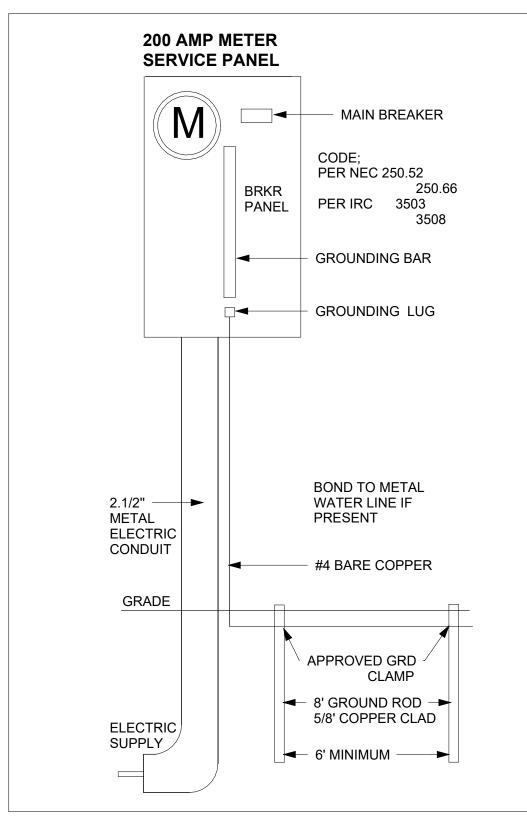



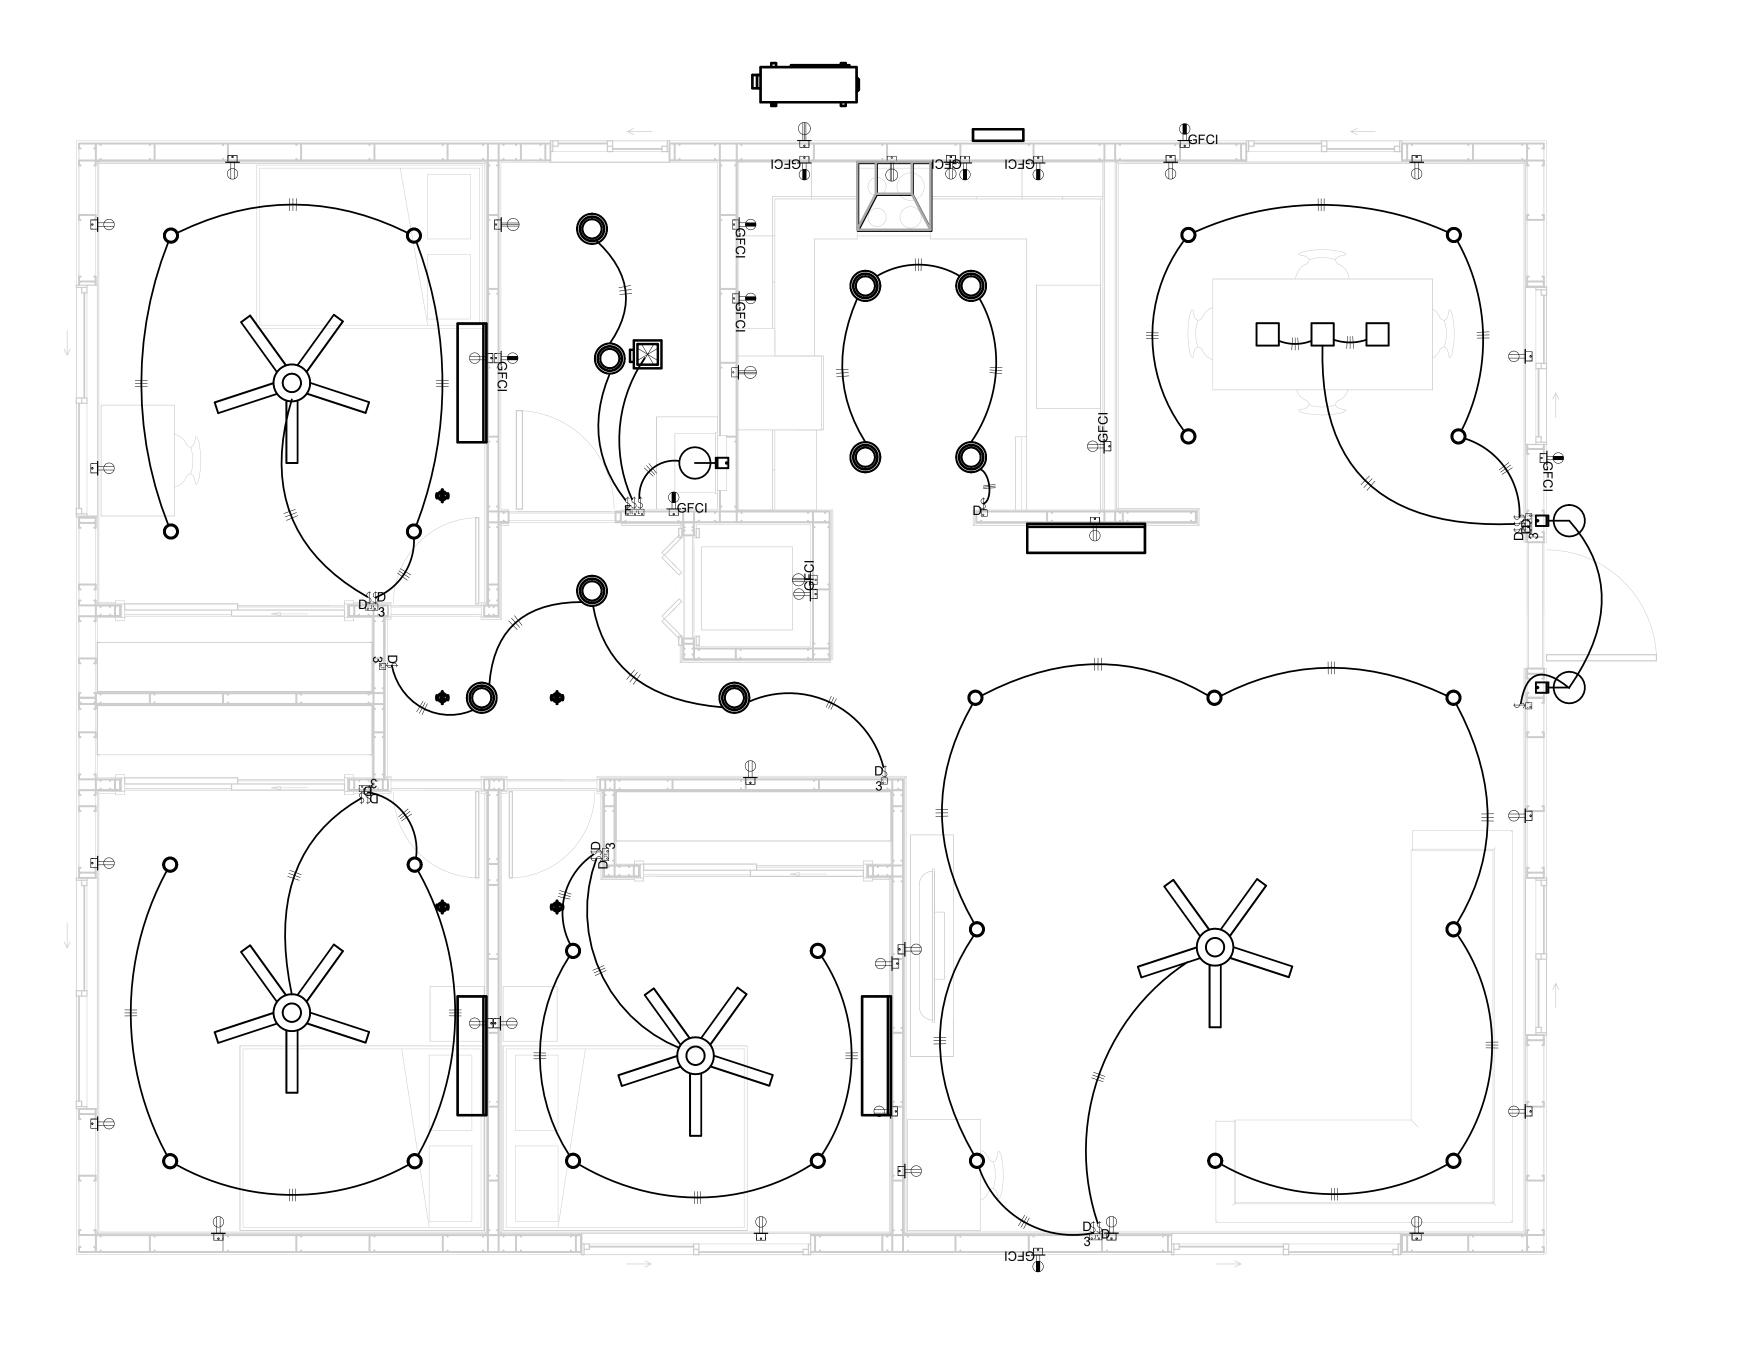

1 - Lighting 3/8" = 1'-0"



KEY PLAN

NO.	DESCRIPTION	DATE

NOTE:

LEGEND:

PROJECT

LA County-1200-3Bd1Ba-550

DRAWING NAME


LIGHTING

CLIENT NAME:	Owner
PROJECT NUMBER:	0388_13
DATE:	4/7/2025 4:49:22 PM
DESIGNED BY:	Designer
DRAWN BY:	Author
CHECKED BY:	Checker


E102

NOTES: CONDUIT, CABLE AND WIRING


- Use Metalic Conduits (IMC) for cables running under concrete slabs.
 Use IMC for circuits with high voltage appliances (240 volts and above)
 For circuits with 120 volts consider using EMT or PVC conduits if needed.
 For Low voltage applications up to 50 volts consider using non metalic conduits.
 All conduits to be used in the project must conform to the latest National Electrical Code (NEC),
- 6. All wiring and cables to be used in the project must also conform to the latest National Electrical Code (NEC), 2015.
 7. All cables and wires used should be rated for their respective loading and should be gauged and conform to the NEC.

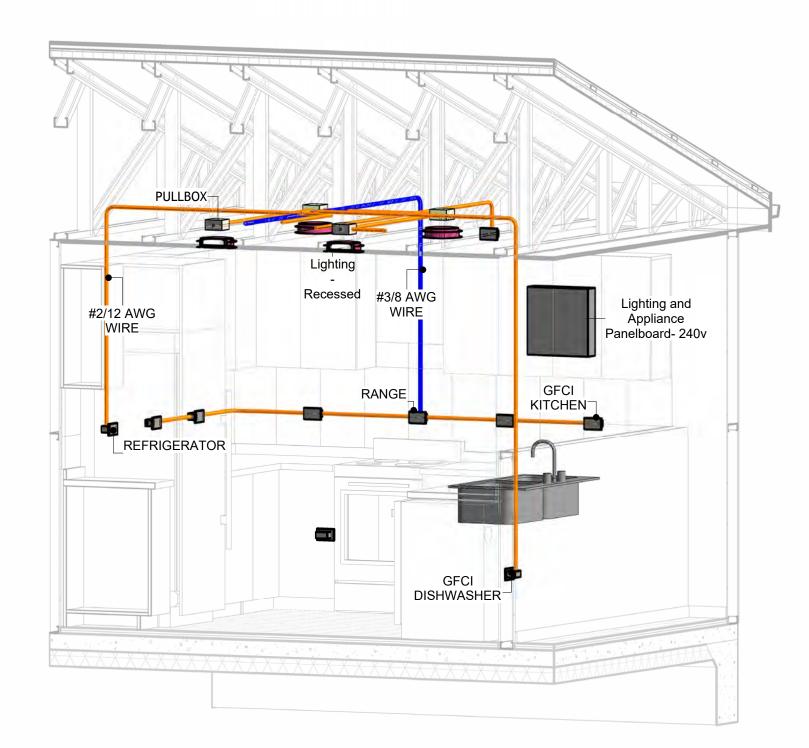


3D-KITCHEN

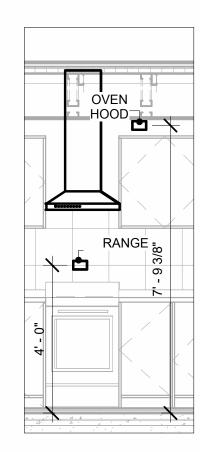


RANGE & OVENHOOD

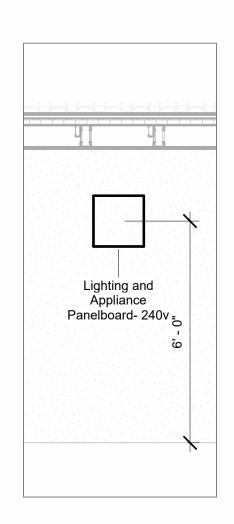

PANEL 3/8" = 1'-0"

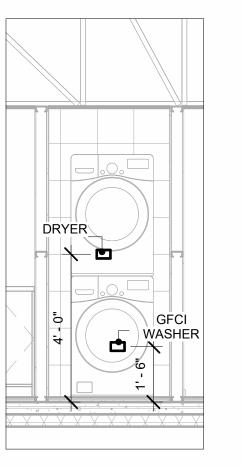


DRYER& WASHER 3/8" = 1'-0"

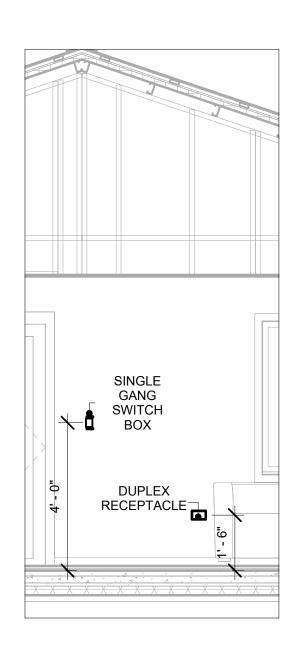

SWITCH & RECEPTACLE
3/8" = 1'-0"



KEY PLAN

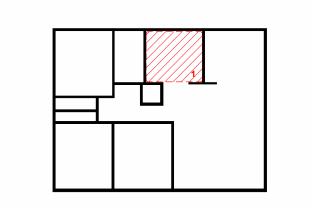

NO.	DESCRIPTION	DATE

NOTE:

LEGEND:

PROJECT

LA County-1200-3Bd1Ba-550

DRAWING NAME

POWER

CLIENT NAME:	Owner
PROJECT NUMBER:	0388_13
DATE:	4/7/2025 4:49:47 PM
DESIGNED BY:	Designer
DRAWN BY:	Author
CHECKED BY:	Checker

E103

SCALE: As indicated

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NOTES: LIGHT

- 1. LIGHT FIXTURES AND LUMINARIES SHALL CONFORM TO THE NEC, THE IRC AND LOCAL SAFETY & BUILDING CODE.
- 2. ALL LIGHTING FIXTURES SHOULD CONFORM TO THE DESIGN ELECTRICAL LOAD AND SHALL BE PROPERLY WIRED AND MOUNTED BY QUALIFIED ELECTRICIAN FOLLOWING MANUFACTURERS SPECIFICATIONS.
- CEILING FANS AND FANS WITH LIGHT WITH WEIGHT EXCEEDING 35 LBS SHOULD BE PROVIDED WITH STRUCTURAL BACKING FOR SUPPORT AND SHALL BE FIXED AS PER MANUFACTURERS SPECIFICATIONS.
- 4. EXTERIOR LIGHTS SHALL CONFORM TO LOCAL BUILDING CODE AND GUIDELINES.

NOTES: SWITCH JUNCTION BOX


- THE MINIMUM SIZE OF JUCTION BOX TO BE USED IS 2"X4"X(1.5" OR 3.5" DEEP) THIS ARE TO BE USED FOR SINGLE GANG SWITCH OR OUTLETS.
- 2. FOR DOUBLE GANG (2 GANG) OUTLETS AND SWITCHS THE MINIMUM SIZE OF THE
- JUCTION BOX TO BE PROVIDED SHALL NOT BE LESS THAN 4"X4"X(1.5" OR 3.5" DEEP)
- 3. FOR THREE GANG (3 GANG) OUTLETS AND SWITCHS THE MINIMUM SIZE OF THE JUĆTION BOX SHALL NOT BE LESS THAN 6"X4"X(1.5" OR 3.5" DEEP).

FITTING SCHEDULE(PULL BOX)					
FAMILY	COUNT	DESCRIPTION			
PULLBOX1	45	#1/4 PULLBOX			

ELECTRICAL FIXTURE SCHEDULE (SWITCH BOX)					
TYPE	COUNT				
DOUBLE GANG SWITCH BOX	4				
SINGLE GANG SWITCH BOX	4				
TRIPLE GANG SWITCH BOX	2				

LIGHTING DEVICE						
TYPE	COUNT					
DIMMER	7					
FAN SWITCH	1					
SINGLE POLE	3					
THREE WAY WITH DIMMER	7					

LIGHTING FIXTURE							
LIGHTING FIXTURE TYPE	VOLTAGE	ELECTRICAL LOAD	COUNT				
ELECTRICAL_LIGHTS_FAN-LIGHT1	120 V/1-100 VA- 120 V/1-100 VA	200 A, 120 V/240 V, SINGLE PHASE, 3 WIRES	4				
LIGHTING - RECESSED	120 V/1-60 VA	200 A, 120 V/240 V, SINGLE PHASE, 3 WIRES	9				
LIGHTING_PENDANT_TOM-DI XON_BEAT-TALL-PENDANT1	120 V/1-100 VA	200 A, 120 V/240 V, SINGLE PHASE, 3 WIRES	3				
SASSO 100 ROUND WALLWASHER TRIM	120 V/1-28 VA	200 A, 120 V/240 V, SINGLE PHASE, 3 WIRES	24				
WALL LAMP - BRACKET	120 V/1-100 VA	<varies></varies>	3				

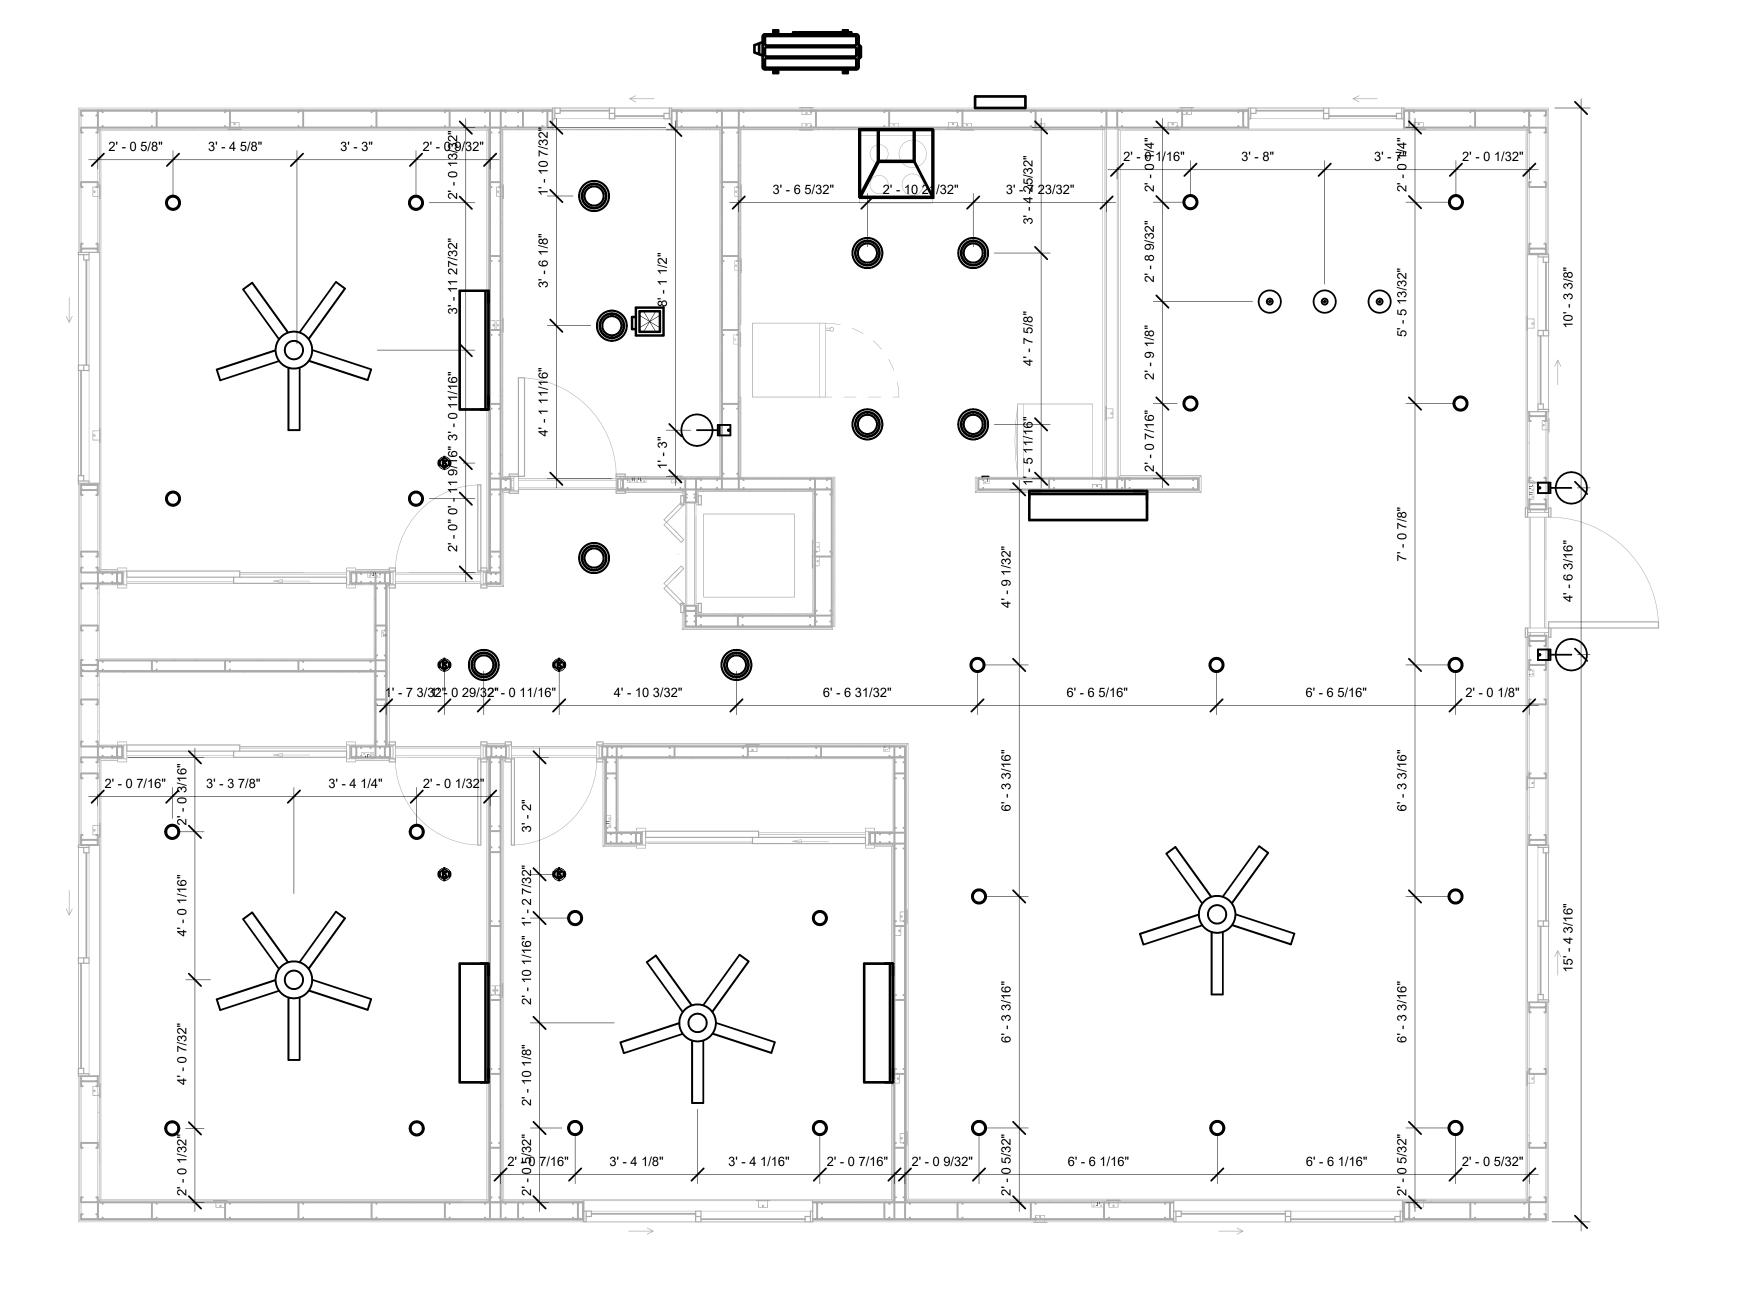

1 DIMENSION FOR LIGHT FIXTURES
3/8" = 1'-0"



KEY PLAN

NO.	DESCRIPTION	DATE

NOTE:

LEGEND:

PROJECT

LA County-1200-3Bd1Ba-550

DRAWING NAME

DIMENSION PLAN FOR LIGHT FIXTURES

CLIENT NAME:	Owner
PROJECT NUMBER:	0388_13
DATE:	4/7/2025 4:49:49 PM
DESIGNED BY:	Designer
DRAWN BY:	Author
CHECKED BY:	Checker


E104

NOTES;

- 1. VERIFY EQUIPMENT PLUG CONFIGURATION BEFORE PURCHASING RECEPTACLES
- 2. FOR ALL EQUIPMENT.
- 3. COORDINATE EXACT LOCATION OF LIGHT FIXTURES, WALL SWITCHES, RECEPTACLES AND OTHER DEVICES WITH ARCHITECTURAL DRAWINGS.
- 4. USE METALLIC JUNCTION BOX WITH THE GFCI RECEPTACLES, WITH HIGHT VOLTAGE.

ELECTRICAL FIXTURE SCHEDULE (RECEPTACLE)					
TYPE	COUNT				
CONDENSER	1				
DRYER	1				
DUPLEX RECEPTACLE	23				
GFCI BATH ROOM	2				
GFCI DISHWASHER	1				
GFCI KITCHEN	5				
GFCI OUT DOOR	3				
GFCI WASHER	1				
OVEN HOOD	1				
RANGE	1				
REFRIGERATOR	1				
WATER HEATER	1				

ELECTRICAL OUTLET SCHEDULE							
TYPE	CIRCUIT NUMBER	ELECTRICAL DATA	COUNT				
		100.111.100.11					
GFCI BATH ROOM	2	120 V/1-180 VA	2				
GFCI KITCHEN	7	120 V/1-180 VA	5				
RANGE	8,10	240 V/2-5000 VA	1				
REFRIGERATOR	9	120 V/1-1800 VA	1				
OVEN HOOD	11	120 V/1-180 VA	1				
GFCI DISHWASHER	12	120 V/1-1200 VA	1				
DUPLEX RECEPTACLE	13	120 V/1-180 VA	8				
DUPLEX RECEPTACLE	14	120 V/1-180 VA	5				
DUPLEX RECEPTACLE	15	120 V/1-180 VA	10				
GFCI OUT DOOR	16	120 V/1-180 VA	3				
GFCI WASHER	17	120 V/1-1200 VA	1				
DRYER	18,20	240 V/2-5000 VA	1				
CONDENSER	19,21	240 V/2-5000 VA	1				
WATER HEATER	22,24	240 V/2-4500 VA	1				

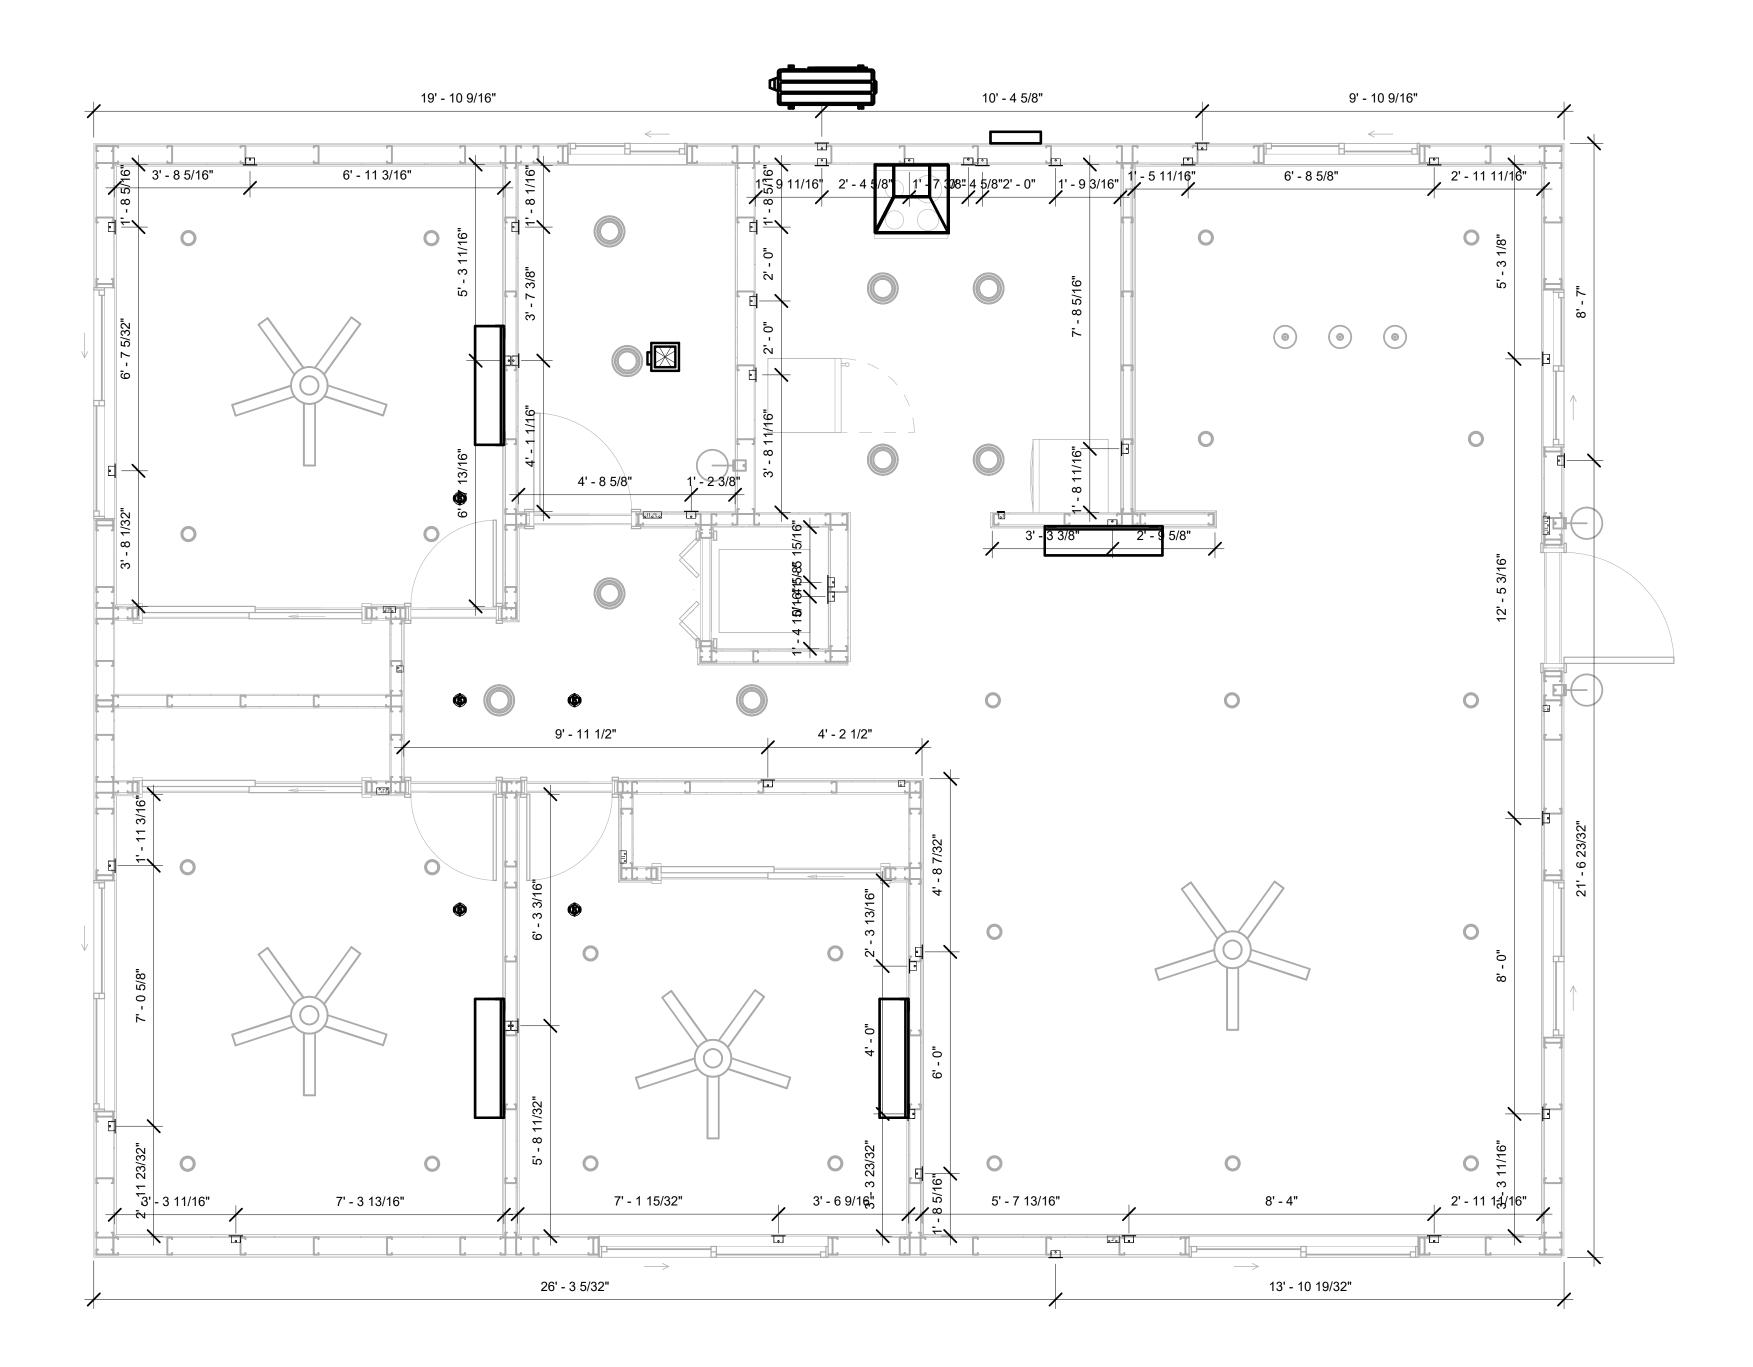

DIMENSION FOR FITTINGS
3/8" = 1'-0"



KEY PLAN

NO. DESCRIPTION DATE

NOTE:

LEGEND:

PROJECT

LA County-1200-3Bd1Ba-550

DRAWING NAME

DIMENSION PLAN FOR FITTINGS

CLIENT NAME:	Owner
PROJECT NUMBER:	0388_13
DATE:	4/7/2025 4:49:51 PM
DESIGNED BY:	Designer
DRAWN BY:	Author
CHECKED BY:	Checker

E105

SHEET LIST

SHEET NUMBER SHEET NAME

P101 NOTE AND SCHEDULE
P102 WATER SUPPLY AND SEWAGE
SYSTEM

DOMESTIC COLD WATER DOMESTIC HOT WATER DOMESTIC HOT WATER SANITARY VENT SANITARY SEWER STORM DRAINAGE GRAY WATER GAS LINE

PLUMBING NOTES

- THE PLUMBING SYSTEM IS DESIGNED TO MEET THE BUILDING'S DOMESTIC WATER SUPPLY, SANITARY DRAINAGE, AND STORM DRAINAGE REQUIREMENTS, AS PER PROJECT SPECIFICATIONS AND APPLICABLE CODES.
- THE SYSTEM INSTALLATION SHALL COMPLY WITH THE LATEST INTERNATIONAL PLUMBING CODE (IPC), INTERNATIONAL RESIDENTIAL CODE (IRC), AND ALL OTHER RELEVANT LOCAL, STATE, AND NATIONAL REGULATIONS.
- ALL PLUMBING WORK SHALL COMPLY WITH THE LATEST EDITION OF THE INTERNATIONAL PLUMBING CODE (IPC) AND THE LOCAL PLUMBING CODE.
- 4. PLUMBING SYSTEMS SHALL BE TESTED AND INSPECTED IN ACCORDANCE WITH THE LOCAL PLUMBING CODE REQUIREMENTS.
- 5. PLUMBING FIXTURES SHALL BE INSTALLED WITH THE APPROPRIATE TRIM, FITTINGS, AND ACCESSORIES, AS RECOMMENDED BY THE MANUFACTURER.
- 6. PIPING SHALL BE PROPERLY SUPPORTED AND SECURED TO PREVENT SAGGING, MOVEMENT, AND VIBRATION.
- 7. SHUT-OFF VALVES SHALL BE PROVIDED AT ALL BRANCH CONNECTIONS AND AT THE
- INLET AND OUTLET OF EACH PIECE OF EQUIPMENT.

 8. BACKFLOW PREVENTION DEVICES SHALL BE INSTALLED AS REQUIRED BY THE LOCAL
- PLUMBING CODE TO PROTECT THE POTABLE WATER SYSTEM.

 9. PLUMBING FIXTURES AND EQUIPMENT SHALL BE ACCESSIBLE FOR MAINTENANCE AND
- 10. EXPOSED PLUMBING PIPING AND FIXTURES SHALL BE INSULATED TO PREVENT CONDENSATION AND ENERGY LOSS.
- 11. DEAD ENDS IN THE DRAINAGE SYSTEM MUST BE AVOIDED, EXCEPT WHERE NECESSARY TO INSTALL A CLEANOUT IN AN ACCESSIBLE LOCATION, AND MUST HAVE A VENTED CONNECTION TO THE OUTSIDE ATMOSPHERE.
- 12. THE VERTICAL DEFLECTION OF PVC PIPE MUST NOT EXCEED 5%, AND NO DEFLECTION IS PERMITTED FOR IRON PIPE.
- 13. WORK MUST BE PROPERLY COORDINATED WITH OTHER TRADES TO AVOID CONFLICTS, REFERRING TO THE ARCHITECTURAL AND STRUCTURAL DRAWINGS FOR INFORMATION REGARDING CEILING ELEVATIONS, SPACE CLEARANCES, WALL AND PARTITION LOCATIONS, ETC.
- 14. ALL FIXTURES SHALL HAVE ACCESSIBLE STOPS.
- 15. DOMESTIC WATER PIPING SHALL BE PEX, AND PVC PIPING IS NOT ACCEPTABLE FOR INTERIOR USE.
- 16. VENT TERMINATIONS SHALL BE LOCATED AT LEAST 10 FEET FROM OR 3 FEET ABOVE ANY OPERABLE WINDOW, DOOR OPENING, AIR INTAKE, OR VENT SHAFT, AND AT LEAST 3 FEET IN EVERY DIRECTION FROM ANY LOT LINE, ALLEY, OR STREET.
- 17. PIPE AND FITTINGS UTILIZED IN THE WATER SUPPLY SYSTEM SHALL HAVE A MAXIMUM OF 8 PERCENT LEAD.
- 18. ACRYLONITRILE BUTADIENE STYRENE (ABS) SHALL BE USED FOR THE SEWERAGE AND VENTILATION SYSTEM.
- 19. CROSS-LINKED POLYETHYLENE (PEX) SHALL BE USED FOR THE WATER SUPPLY SYSTEM.
- 20. POLYVINYL CHLORIDE (PVC) SHALL BE USED FOR THE RAIN WATER SYSTEM.
- 21. THE MIMIMUM WATER SUPPLY DEPTH UNDER FLOOR FINISH SHOUD BE 1/2".
- 22. ANY PIPE INSTALLED UNDERGROUND MUST HAVE AT LEAST 12 INCHES OF CLEARANCE BETWEEN THE OUTSIDE OF THE PIPE AND ANY OTHER UNDERGROUND STRUCTURE.
- 23. THE MINIMUM CLEARANCE BETWEEN COLD AND HOT WATER LINES IN RESIDENTIAL HOMES MAINTAIN A MINIMUM DISTANCE OF 6 INCHES.
- 24. HORIZONTAL SEPARATION BETWEEN WATER AND SEWER LINES: A MINIMUM OF 12 INCHES BETWEEN POTABLE WATER SUPPLY LINES (COLD AND HOT WATER) AND

ABBREVIATIONS

SANITARY SEWER LINES.

Ø	DIAMETER
ABS	ACRYLONITRILE BUTADIENE STYRENE
ABV	ABOVE
AD	AREA DRAIN
AFF	ABOVE FINISHED FLOOR
ALT	ALTERNATE
BFF	BELOW FINISHED FLOOR
BLW	BELOW
CO	CLEAN OUT
CW	COLD WATER
D	DEGREE
DFU	DRANAGE FIXTURE UNIT
DIA	DIAMETER
DN	DOWN
FCO	FLOOR CLEAN OUT
FD	FLOOR DRAIN
FL	FLOOR
FS	FLOOR SINK
FT	FOOT/FEET
HB	HOSE BIB
HW	HOT WATER
IN	INCH
MIN	MINIMUM
NO	NUMBER
NTS	NOT TO SCALE
PEX	CROSS-LINKED POLYETHYLENE
PLBG	PLUMBING
PVC	POLYVINYL CHLORIDE
QTY	QUANTITY
RD	ROOF DRAIN
RED	REDUCER
RM	ROOM
RW	RAIN WATER
SF	SQUARE FOOT
V	VENT
VTR	VENT THROUGH ROOF
W	WASTE
WCO	WALL CLEAN OUT
WSFU	WATER SUPPLY FIXTURE UNIT

PLUMBING LEGEND

D	CAP				
₫	BEND 45 DEG				
U	BEND 90 DEG				
	TEE REDUCING				
	TEE				
	CLEAN TWO-WAY				
	WYE 45 DEG				
	WYE 45 DEG DOUBLE				
	WYE COMBINATION				
	P-TRAP				

PIPE SCHEDULE						
MATERIAL	DIAMETER	LENGTH				
ACRYLONITRILE BUTADIENE STYRENE (ABS)	1 1/2"	36 FT				
ACRYLONITRILE BUTADIENE STYRENE (ABS)	2"	23 FT				
ACRYLONITRILE BUTADIENE STYRENE (ABS)	3"	32 FT				
CROSS-LINKED POLYETHYLENE (PEX)	1/2"	75 FT				
CROSS-LINKED POLYETHYLENE (PEX)	3/4"	22 FT				
CROSS-LINKED POLYETHYLENE (PEX)	1"	0 FT				
POLYVINYL CHLORIDE - RIGID	2"	65 FT				

F	ITTING SCHEDULE	
FITTING	SIZE	QTY
DOMESTIC COLD WATER		
PEX 90 DEGREE ELBOW	1/2"ø-1/2"ø	14
PEX 90 DEGREE ELBOW	3/4"ø-3/4"ø	2
PEX TEE ELBOW	1"ø-1"ø	1
PEX TEE ELBOW	1/2"ø-1/2"ø	4
PEX TEE ELBOW	3/4"ø-3/4"ø-3/4"ø	2
PEX TRANSITION ELBOW	1"ø-1/2"ø	2
PEX TRANSITION ELBOW	1"ø-3/4"ø	5
PEX TRANSITION ELBOW	3/4"ø-1/2"ø	5
DOMESTIC HOT WATER		
PEX 90 DEGREE ELBOW	1/2"ø-1/2"ø	12
PEX 90 DEGREE ELBOW	3/4"ø-3/4"ø	2
PEX TEE ELBOW	1/2"ø-1/2"ø	4
PEX TRANSITION ELBOW	1"ø-1/2"ø	1
PEX TRANSITION ELBOW	1"ø-3/4"ø	1
PEX TRANSITION ELBOW	3/4"ø-1/2"ø	4
PEX TRANSITION ELBOW	3/4"ø-3/4"ø	1
PVC 90 DEG BEND ELBOW	2"ø-2"ø	24
SEWAGE ABS 90 DEGREE BEND ELBOW	1 1/2"ø-1 1/2"ø	3
ABS 90 DEGREE BEND ELBOW	2"ø-2"ø	1
ABS 90 DEGREE BEND ELBOW	3"ø-3"ø	3
ABS P-TRAP	1 1/2"ø-1 1/2"ø	4
ABS P-TRAP	2"ø-2"ø	2
ABS REDUCER ELBOW	2"ø-1 1/2"ø	
ABS TEE ELBOW	1 1/2"ø-1 1/2"ø-1 1/2"ø	2
ABS TEE ELBOW	2"ø-2"ø-2"ø	1
ABS TEE ELBOW	3"ø-3"ø-3"ø	1
ABS TEE REDUCER ELBOW	3"ø-3"ø-1 1/2"ø	3
ABS TEE REDUCER ELBOW	3"ø-3"ø-2"ø	1
WASTE DOUBLE TEE	1 1/2"ø-1 1/2"ø-1 1/2"ø	1
VENT		
ABS 90 DEGREE BEND ELBOW	1 1/2"ø-1 1/2"ø	1
ABS REDUCER ELBOW	3"ø-1 1/2"ø	1
ABS TEE ELBOW	3"ø-3"ø-3"ø	1
ABS VENT CAP ELBOW	1 1/2"ø	1
ADO VEIVI O/ II EEDOVV		
ABS VENT CAP ELBOW	2"ø	1

FIXTURE CONNECTION SCHEDULE											
FAMILY	W	V	TRAP	CW	HW	QTY	DFU	TOT.	WFU	TOT.	NOTES
DISHWASHER	2"	1-1/2"	1-1/2"	1/2"	1/2"	1		0			DRAIN TO SEWER SEE PLANS
DRYER	N/A	N/A	N/A	N/A	N/A	1		0			
HANGING PIPES CLAMP						16		0			
KITCHEN SINK DOUBLE	2"	1-1/2"	1-1/2"	1/2"	1/2"	1		0			
SHOWER TRAY	2"	1-1/2"	1-1/2"	1/2"	1/2"	1		0			
SHOWER TRIM	-	-	-	1/2"	1/2"	1		0			
VANITY SINK	2"	1-1/2"	1-1/2"	1/2"	1/2"	1		0			
WASHER	2"	1-1/2"	2"	1/2"	1/2"	1		0			DRAINS TO GRAY WATER OR SEWER SEE PLANS
WATER CLOSET	3"	2"	3"	1/2"	1/2"	1		0			
WATER HEATER						1		0			

FIXTURE SCHEDULE									
FIXTURE	FIXTURE QTY DESCRIPTION								
DISHWASHER	1	DRAIN TO SEWER SEE PLANS							
DRYER	1								
HANGING PIPES CLAMP	16								
KITCHEN SINK DOUBLE	1								
SHOWER TRAY	1								
SHOWER TRIM	1								
VANITY SINK	1								
WASHER	1	DRAINS TO GRAY WATER OR SEWER SEE PLANS							
WATER CLOSET	1								
WATER HEATER	1								

PLUMBING SCHEDULE								
FIXTURE	TRAP	WASTE	VENT	C.W	H.W			
DIOLIMA OLUED	4.4/01	011	4.4/00	4 (01)	4 /011			
DISHWASHER	1-1/2"	2"	1-1/2"	1/2"	1/2"			
DRYER	N/A	N/A	N/A	N/A	N/A			
KITCHEN SINK DOUBLE	1-1/2"	2"	1-1/2"	1/2"	1/2"			
SHOWER TRAY	1-1/2"	2"	1-1/2"	1/2"	1/2"			
SHOWER TRIM	-	-	-	1/2"	1/2"			
VANITY SINK	1-1/2"	2"	1-1/2"	1/2"	1/2"			
WASHER	2"	2"	1-1/2"	1/2"	1/2"			
WATER CLOSET	3"	3"	2"	1/2"	1/2"			
WATER HEATER								

WATER FIXTURE UNIT SCHEDULE							
FAMILY	QTY	UNIT VALUE	TOTAL				
DISHWASHER	1		0				
DRYER	1		0				
HANGING PIPES CLAMP	16		0				
KITCHEN SINK DOUBLE	1		0				
SHOWER TRAY	1		0				
SHOWER TRIM	1		0				
VANITY SINK	1		0				
WASHER	1		0				
WATER CLOSET	1		0				
WATER HEATER	1		0				

WASTE FIXTURE UNIT SCHEDULE							
FAMILY	QTY	DFU VALUES	TOTAL				
DISHWASHER	1		0				
DRYER	1		0				
HANGING PIPES CLAMP	16		0				
KITCHEN SINK DOUBLE	1		0				
SHOWER TRAY	1		0				
SHOWER TRIM	1		0				
VANITY SINK	1		0				
WASHER	1		0				
WATER CLOSET	1		0				
WATER HEATER	1		0				

ACCESSORIES & FITTINGS SCHEDULE							
FIXTURE	QTY	DESCRIPTIONS					
DISHWASHER CONNECTOR	1						
HOSE BIB	1						
LAUNDRY SWEAT CONNECTOR	1						
SHUTOFF VALVE	4						



Tuscon,AZ, USA 888-864-0184

KEY PLAN

NO. DESCRIPTION DATE

NOTE:

LEGEND:

PROJECT

LA-County-800 3Bd1Ba-550

DRAWING NAME

NOTE AND SCHEDULE

CLIENT NAME:

PROJECT NUMBER:

0388_15

DATE:

4/7/2025 2:47:32 PM

DESIGNED BY:


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CHECKED BY:


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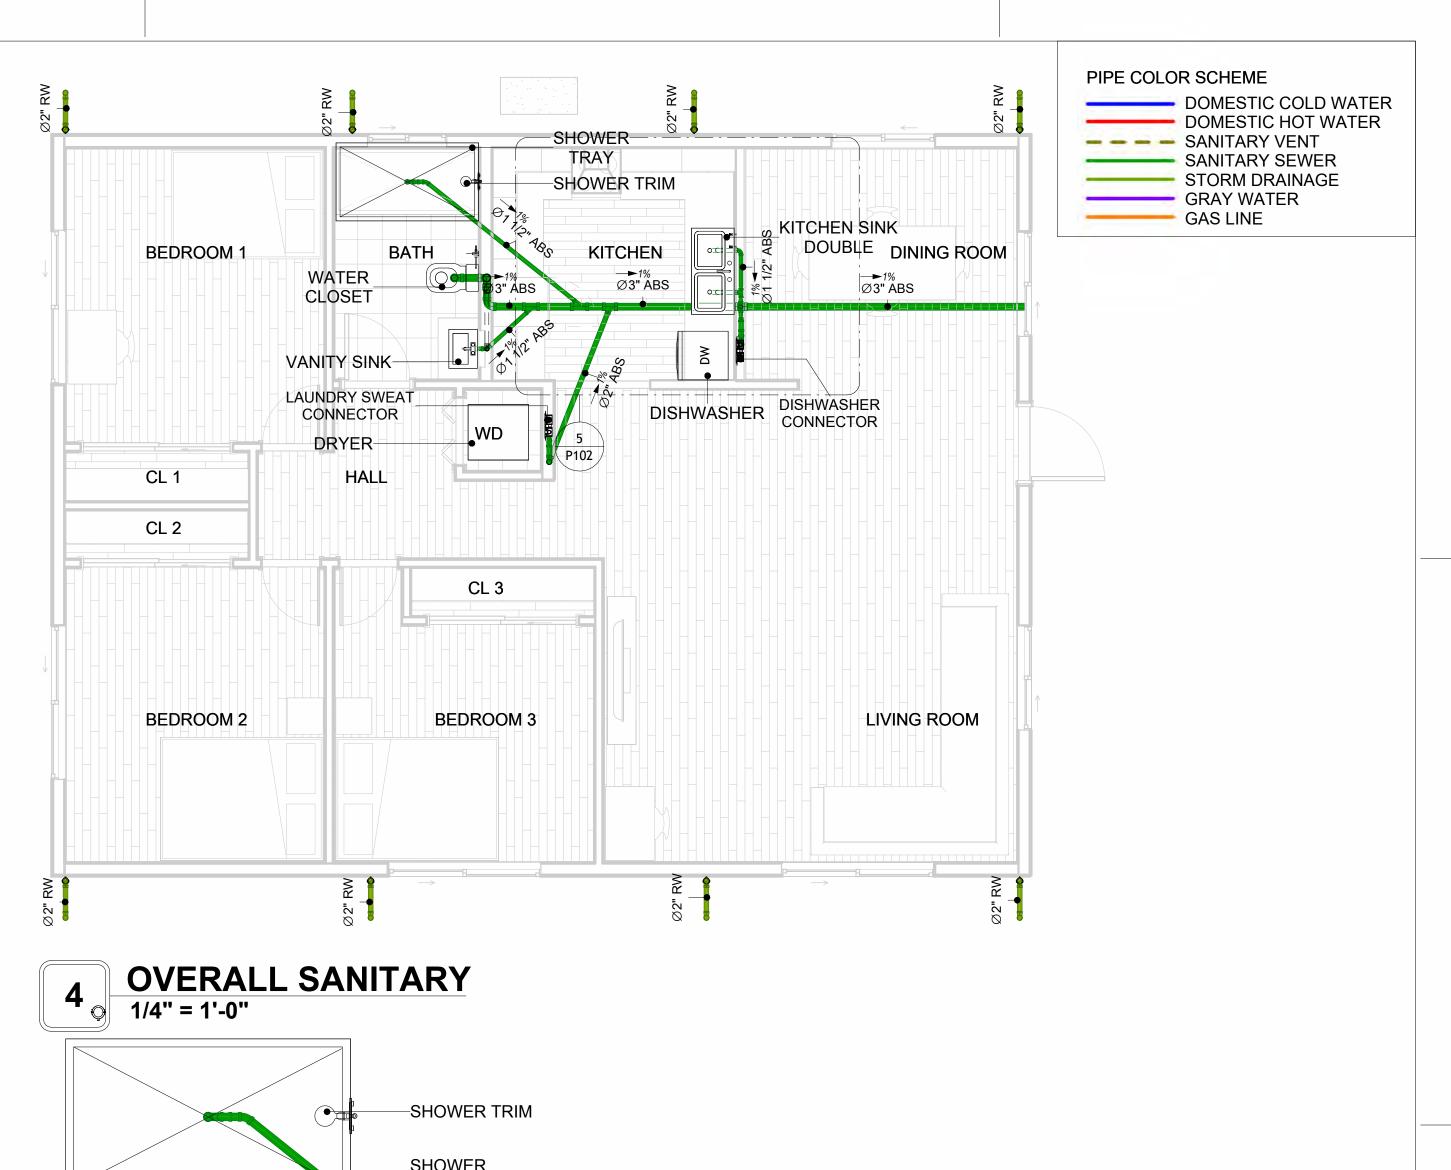
P101


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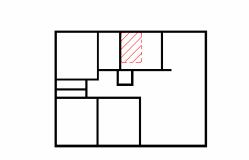




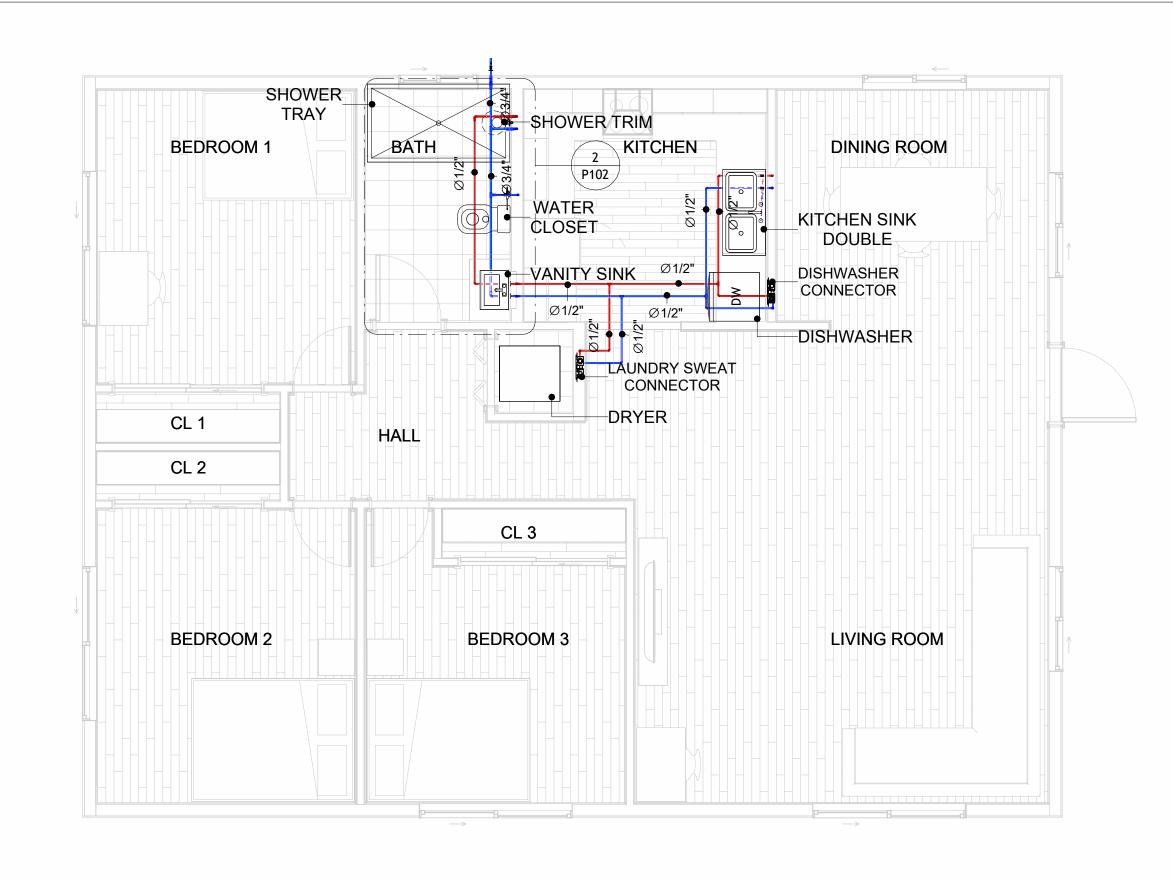

Tuscon,AZ, USA 888-864-0184

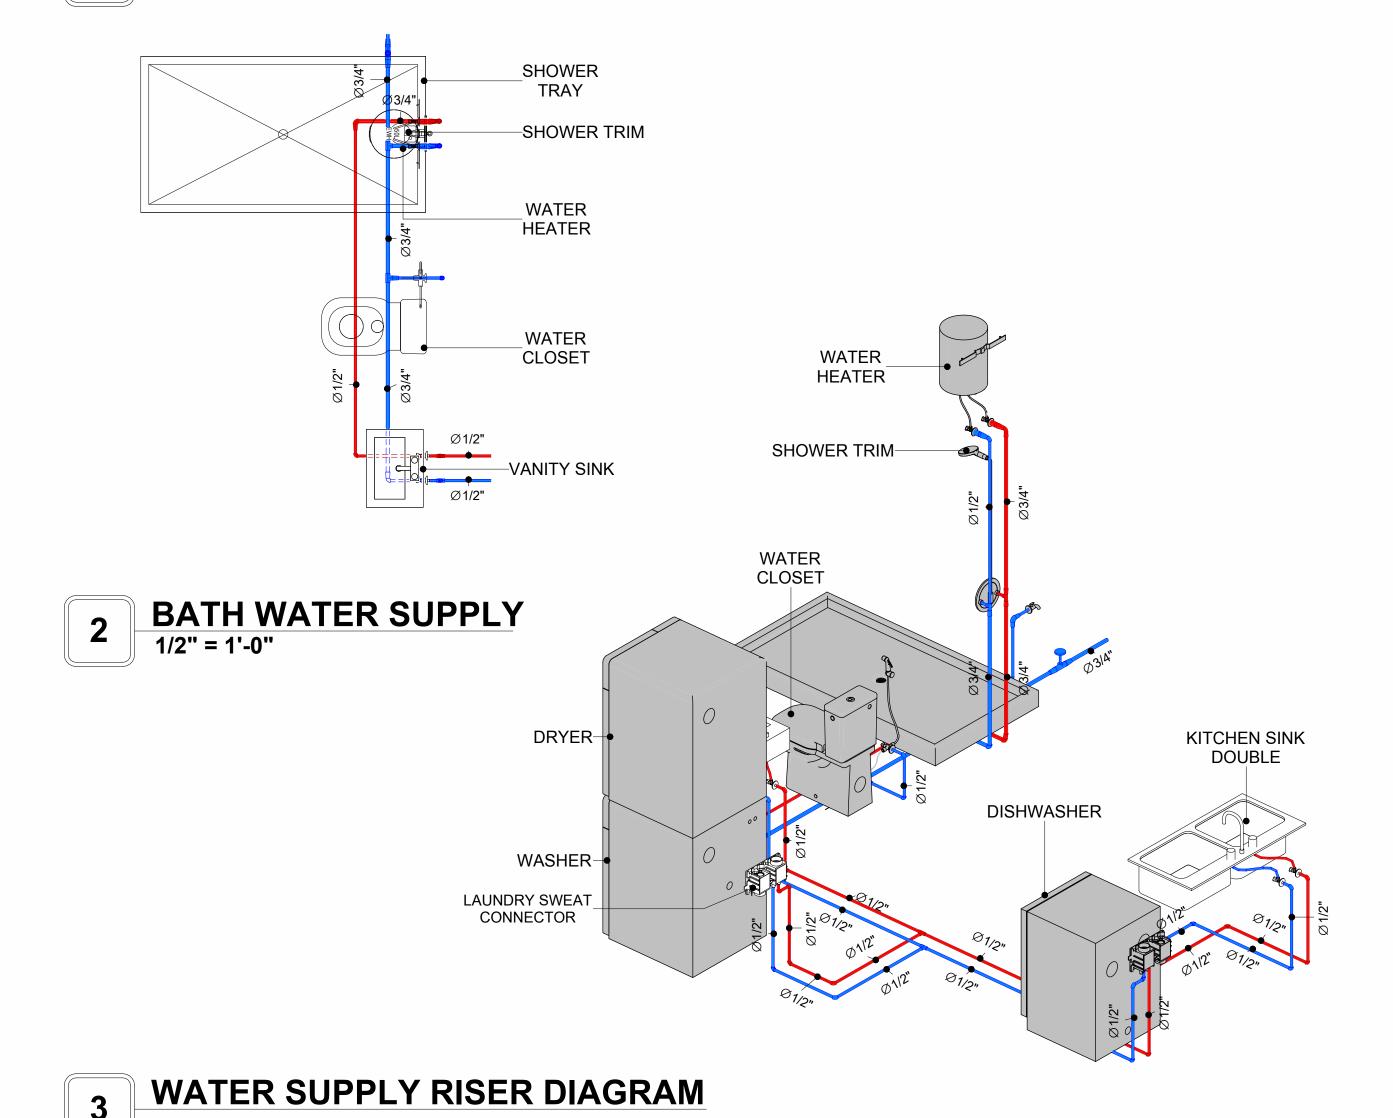KEY PLAN

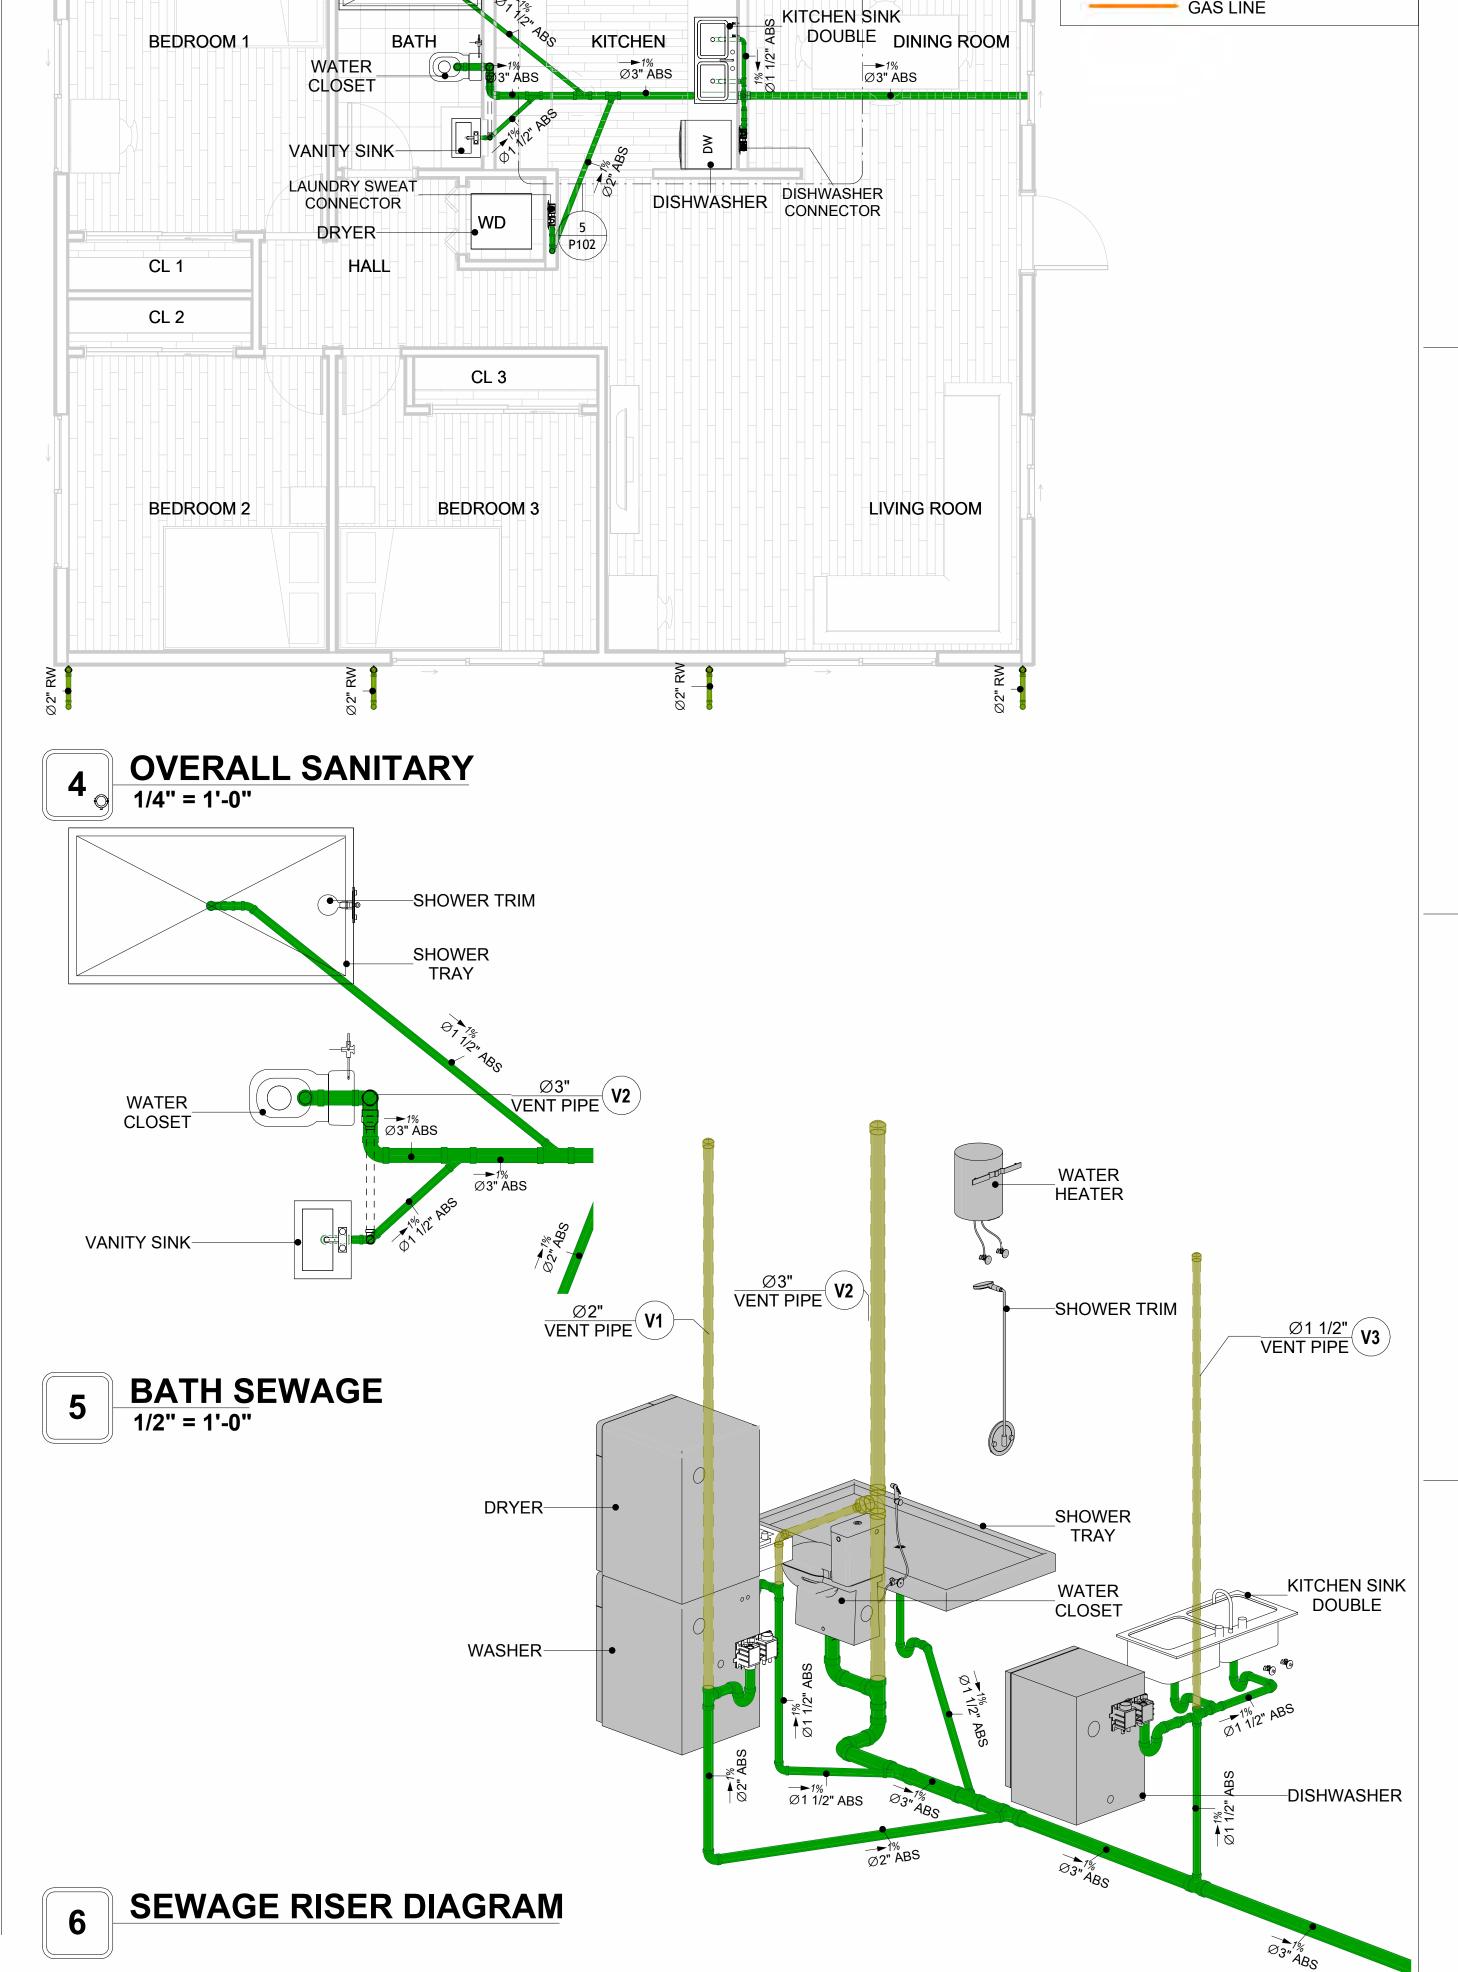

NO.	DESCRIPTION	DATE

NOTE:

LEGEND:

PROJECT

LA-County-800 3Bd1Ba-550

DRAWING NAME

WATER SUPPLY AND **SEWAGE SYSTEM**

CLIENT NAME: 0388_15 PROJECT NUMBER: 4/7/2025 2:48:02 PM Designer DESIGNED BY: DRAWN BY: CHECKED BY: Checker

P102

SCALE: As indicated

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Materials Shopping List

Please print and take this Materials Shopping List to your favorite Home Depot and ask for assistance in selecting the materials, fixtures and fittings to complete your new home.

Record your selection and the price of the item. Then do the math to determine the cost for your selections and the total cost of finishing your home.

Have It Your Way!

The material types listed in this document were selected based on personal preferences. The Customer is encouraged to make changes to the material types in accordance with local customs, regulations, and personal preferences.

Have It Your Way!



20 good reasons to frame a home with metal and not wood



Why build your ADU with metal vs wood	Wood	Metal	Explanation
1 DIY Construction Benefit		~	The wall frames, trusses and beams can be erected in a just a few days
2 Minimal Construction Skills Required		~	Pre-assembled walls and trusses require no specialized skills to errect
3 Build as DIY, Hybrid or by a General Contractor		✓	Do it yourself, Hybrid (involve special contractors) or hire a General Contractor
4 Build It As You Can Afford It		✓	Impervious to Weather - build as you have the time and money
5 Up Front Cost of Framing Materials	~		As to only the framing material, wood is less expensive
6 Total Cost To Build		~	Savings in time, labor, and other areas make light gauge steel LESS expensive
7 Termites and wood boring insects		Y	Termites, carpenter ants and wood boring insects eat wood, not metal
8 Mold resistant		~	Metal does not attract mold
9 Damage caused by exterior and interior flooding		~	Metal needs no reconditioning after a flood
10 Fire Resistant		~	Non-combustible
11 Lower insurance rates		Y	Many insurance underwriters now provide lower rates for metal framed homes
12 Walls, trusses, and beams retain their original form		~	Perfectly straight walls - no shimming of drywall
13 Corners are 90 degrees		✓	No need for templating of countertops to adjust for out of square corners
14 Strength and weight		✓	Metal is stronger than wood and weighs less - no need for crane to lift ADU trusses
15 IBC Engineered Stamp		✓	If an engineering stamp is necessary, months of waiting are saved
16 Complete BOM (Materials Shopping List)		~	Take the materials shopping list to Home Depot and start shopping/pricing
17 Flexible in Seismic Areas - Won't Fracture		~	Light gauge steel is flexible and won't fracture when the earth moves
18 No Waste At Job Site		~	Steel is the most recycled material in the world. A typical wood home has 20-30% waste
19 Environmentally Friendly		~	Trees don't have to be destroyed and the source of most metal is from recycling
20 How-To Videos Included		~	How-to videos provide simple assembly instructions
21 Relationship Counselor		~	Eliminate emotional uphevels - save time, money, and preserve the relationship

Universal Requirements - some or all may be required

- 1 Site plan
- 2 Electrical Supply Connection
- 3 Sewer Connection
- 4 Fresh Water Supply Connection
- 5 Set Backs
- 6 Soils Evaluation

- 7 Earthquake (fault) evaluation
- 8 Foundation Plan subject to soils
- 9 Compliance with local energy codes: insulation home wrap and flashing
- 10 Engineering for wind speed and snow load.
- 11 State and Local ordinances regarding ADUs
- 12 Local Architect and/or Engineer may be necessary





LA County_1200_3Bd1Ba MATERIAL SHOPPING LIST

Have It Your Way!

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TOC



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Have It Your Way!

The material types listed in this document were selected based on personal preferences. The Customer is encouraged to make changes to the material types in accordance with local customs, regulations, and personal preferences. Have It Your Way!

GENERAL NOTES

- 1 This BOM (Bill of Materials) is prepared as a Materials Shopping List to help builders and DIYers gain a complete understanding of most if not all elements required for the complete construction of this structure, according to the original design documents provided by FrameUpNow.
- 2 All quantities and specifications are subject to change based on the final design, field measurements, availability of products and customer preferences. The customer should verify all information prior to purchasing materials.
- 3 All products and elements in the list shall conform to the International Residential Code (IRC), or any other local and international building codes, safety regulations, and standards that are applicable to the location of the structure.
- 4 If any changes are made by the customer to the list of materials specified in this document, the customer is responsible for assuring that the correct type and quantity of materials are utilized in accordance with local building codes.
- FrameUpNow, will not be held responsible for any misuse of this document, the products listed, or for deviations from the content that are made due to changes in specifications, pricing, availability, or customer preferences.
- 6 The customer is advised to consult a qualified professional or technician prior to purchasing materials for specialized construction system items. Some items including but not limited to caseworks, doors and windows may require as built measurements prior to purchase to confirmation of final dimensions.
- 7 If there are additional trim elements or specific installation methods, the total amount of materials needed might vary. Consider any additional trim required for corners, intersections, or other architectural details that might cause this variations before proceeding to purchase and construction.

ARCHITECTURAL BOM



	LA County_1200_3Bd1Ba								
		ARCHITECT	JRAL MATE	RIAL SHOPPING LIST					
No.	Item	Туре	Unit	Quantity Unit Price	Total	Description			
△	APPLIANCES								
1	Refrigerator		PCS	1					
2	Range		PCS	1					
3	Washer		PCS	1					
4	Dryer		PCS	1					
5	Dish Washer		PCS	1					
6	Oven		PCS	0					
7	Microwave		PCS	0					
Δ	CASEWORKS	<u> </u>							
1	Kitchen Cabinet		FT	24.56					
2	Laundry Cabinet		FT	0					
3	Vanity Cabinet		FT	2.5					
4	Medicine Cabinet		PCS	1					
5	Kitchen countertop		SF	43.1					
6	Laundry Countertop		PCS	0					
7	Bathroom Countertop		SF	0					
8	Island	-	FT	0					
9	Peninsula		FT	0	+				
10	Closets		SF	135					
			JSF	130					
<u>^</u>	CEILING	D. Wall	CE	1000					
1	Ceiling Board	Dry Wall	SF	1022					
2	Dry Wall Fastener	Screw	PCS	1788					
3	Vapor Retarder	Polyethylene film	SF	1077					
4	Vapor Retarder Fastener	Nails with washer heads	PCS	3232					
5	Ceiling Board (MRD)	Moisture resistant drywall	SF	55					
6	MRD Fastener		PCS	97					
7	Ceiling Board	Marine Plywood	SF	0					
8	Marine Plywood Fastener	Screw	PCS	0					
9	Dry Wall Tape		FT	539					
△	FLOORING								
1	Main Living Space		SF	607.8					
2	Bathroom		SF	51.2					
3	Bedrooms		SF	413.2					
	STRUCTURE								
1	Foundation		SF	1200					
	WALLS EXTERIOR								
1	Stucco Finish		SF	1111					
2	Wall Shteathing (OSB)		SF	1111					
3	Shteathing Fastener	Self-drilling screws(100/pkt)	PKT	11.11					
4	Wall Homewrap	3	SF	1111					
5	Homewrap Fastener	Stapled fastener (200/pkt)	PKT	4.2218	1				
6	Wall Paint	protection (Essiphity	SF	1111					
7	Stone Copping	Masonry stone	SF	10					
8	Stone Veneer	Masonry stone	SF	0	+ + + + + + + + + + + + + + + + + + + +				
9	Mortar for Stone Veneer	iviasurity storie	SF	0	+				
_			SF	3787.0	+ + + + + + + + + + + + + + + + + + + +				
10	Wall Insulation WALLS INTERIOR	<u> </u>	51	3/8/.0					
<u>_</u>			СГ	222	T T				
	Cementitious Backer Board		SF	333					
2	Kerdi membrane		SF	333					
3	Kerdi membrane Fastener		SF	333					
4	Wall Ceramic Tile		SF	333					
5	Drywall Board		SF	2196					
6	Drywall Fastener	Self-drilling screws(100/pkt)	PKT	21.96					
7	Wall Paint		SF	2196					
8	Drywall Tape		FT	412					
9	Wall Sweep		FT	265					

ARCHITECTURAL BOM



Δ	DOORS				
1	Exterior Swinging	3' - 0" X 6'- 8"	PCS	1	
2	Interior Swinging	2' - 4" X 6'-8"	PCS	3	
3	Interior Swinging	2' - 8" X 6'-8"	PCS	1	
4	Bifold	2' - 8" X 6'- 8"	PCS	1	
5	Interior Sliding	6' - 0" X 6'- 8"	PCS	3	
6	Exterior Door Trim	o o x o o	FT	17	
7	Interior Door Trim		FT	291	
8	Entry Lock set			2	
9	Privacy Lock set			3	
	Passage Lock set			3	
Δ	WINDOWS				-
1	Sliding	3' - 3" X 2'-3"	PCS	1	
2	Sliding	6' - 3" X 4'-3"	PCS	4	
3	Sliding	4' - 3" X 4'-3"	PCS	3	
4	Exterior Window Trim		FT	148	
5	Interior Window Trim		FT	148	
Δ	ROOF				·
1	Roof Covering		SF	1496.0	
2	Roof Covering Fastener		PCS	748	
3	Roof Felt Paper		SF	1496.0	
4	Roof Felt Paper Fastener		PCS	4488.0	
5	Roof Sheathing		SF	1496	
6	Roof Sheathing Fastener		PCS	11968	
7	Batten		FT	774.0	
8	Batten Fastener		PCS	582.0	
9	Soffit		SF	225.0	
10	Soffit Fastener		PCS	112.5	
11	Fascia		FT	156.0	
12	Fascia board fastener		PCS	78	
13	Roof Insulation		SF	1496.0	



	LA County_1200_3Bd1Ba							
	FI	ECTRICAL MATER	PIAL SHOP	PINGLI	ST			
No.	Item	Type	Unit	-	Unit Price	Total	Description	
	LIGHTING FIXTURES	7,1						
1	Kitchen Ceiling Light		PCS	4				
2	Kitchen Wall Mounted Light		PCS	0				
3	Exterior Wall Mounted Light		PCS	2				
4	Livingroom Ceiling Light With Fan		PCS	1				
5	Bedroom Ceiling Light With Fan		PCS	3				
6	Dining Ceiling Light		PCS	7				
7	Bath Wall Mounted Light		PCS	1				
8	Bathroom Ceiling Light		PCS	2				
9	Livingroom Ceiling Light		PCS	8				
	Bedroom Ceiling Light		PCS	12				
	Hall & Entry Ceiling Light		PCS	3				
			PCS	0	-			
	Closet Ceiling Light Smoke Detector		PCS	6	-			
-			Ircs	6				
11	ELECTRICAL FITTINGS	204	BOO			-		
	Standard Receptacle 120V	20A	PCS	23				
	GFCI Receptacle 120V	20 A	PCS	14				
16	GFCI Receptacle 240V	30 A	PCS	2				
17	GFCI Receptacle 240V	50 A	PCS	1				
18	GFCI Receptacle 240V	60 A	PCS	1				
	Fan Switch		PCS	1				
	Single Pole Switch		PCS	3				
	Three Way Switch		PCS	7				
22	Dimmer Switch		PCS	7				
\triangle	ELECTRICAL CONDUITS & WIRING							
23	ROMEX 14 AWG	14/3/W/ground	FT	93				
24	ROMEX 12 AWG	12/3/W/ground	FT	313				
25	ROMEX 12 AWG	12/2/W/ground	FT	0				
26	ROMEX 10 AWG	10/3/W/ground	FT	114				
27	ROMEX 10 AWG	10/2/W/ground	FT	46				
28	Romex 8 AWG	8/3/W/ground	FT	0				
	Romex 8 AWG	8/2/W/ground	FT	12				
	ROMEX 6 AWG	6/3/W/ground	FT	16				
	Bare Copper Ground Wire 6 AWG		FT					
	ELECTRICAL BOXES & CIRCUTES							
	Panelboard -240V 1 Phase MLO	200 AMP	PCS	1				
	Circuit breaker	15 A	PCS	3				
	Circuit breaker	20 A	PCS	12				
	Circuit breaker	30 A	PCS	2				
	Circuit breaker	50 A	PCS	1	 			
	Circuit breaker	60 A	PCS	1				
		UU A	PCS	4				
	Single Gang Switch Box		PCS	4				
	Double Gang Switch Box							
	Triple Gang Switch Box		PCS	2				
	Pull Box	#1/4	PCS	45				
44	Receptacle Box		PCS	41				

PLUMBING BOM



LA County_1200_3Bd1Ba PLUMBING SYSTEM MATERIAL SHOPPING LIST

	P	LUMBING SYSTEM MA	aterial	. Shoppii	NG LIST		
Vo.	Item	Type	Unit	Quantity	Unit Price	Total	Description
Δ	PLUMBING FIXTURES & ACCESSORIES	, ,,		, ,			·
1	Bath Tub (Alcove Tub)		PCS	0			
2	Kitchen Sink		PCS	1			
3	Kitchen Faucets		PCS	1			
4	Vanity Sink		PCS	1			
5	Bath room Faucets		PCS	1			
6	Water Closet		PCS	1			
7	Shower Trim		PCS	1			
8	Shower Tray		PCS	1			
9	Water Heater		PCS	1			
	Hose Bib		PCS	1			
	Shutoff Valve		PCS	6			
_	Hanging pipe clamp		PCS	19			
	Gate Valve						
			PCS PCS	1			
	Dishwasher Supply Single Connector			1			
	Dishwasher Sewage Single Connector		PCS	1			
	Laundry Sweat Connector		PCS	1			
	SANITARY & PLUMBING PIPES			1 .		-	
	ABS (Acrylonitrile Butadiene Styrene) Pipes	ø 1"	FT	0			
	ABS (Acrylonitrile Butadiene Styrene) Pipes	ø 1 1/2"	FT	36			
	ABS (Acrylonitrile Butadiene Styrene) Pipes	ø 2"	FT	23			
	ABS (Acrylonitrile Butadiene Styrene) Pipes	ø 3"	FT	32			
_	PEX (Cross-linked polyethylene) Pipes	ø 1/2"	FT	75			
6	PEX (Cross-linked polyethylene) Pipes	ø 3/4"	FT	22			
	PEX (Cross-linked polyethylene) Pipes	ø 1"	FT	0			
8	PVC Pipes Sch.80 - Rigid	ø 1 1/2"	FT	0			
9	PVC Pipes Sch.80 - Rigid	ø 2"	FT	65			
10	PVC Pipes Sch.80 - Rigid	ø 3"	FT	0			
11	Flex Pipe Round	ø 1/2"	PCS	6			
Δ	PIPE FITTINGS	'					
1	ABS 90 Degree Bend Elbow	1 1/2"ø-1 1/2"ø	PCS	4			
2	ABS 90 Degree Bend Elbow	2"ø-2"ø	PCS	1			
	ABS 90 Degree Bend Elbow	3"ø-3"ø	PCS	3			
	ABS P-Trap	1 1/2"ø-1 1/2"ø	PCS	4			
	ABS P-Trap	2"ø-2"ø	PCS	2			
	ABS Reducer Elbow	2"ø-1 1/2"ø	PCS	1			
7	ABS Reducer Elbow	3"ø-1 1/2"ø	PCS	1			
8	ABS TEE Elbow	1 1/2"ø-1 1/2"ø-1 1/2"ø	PCS	2			
9	ABS TEE Elbow	2"ø-2"ø-2"ø	PCS	1			
	ABS TEE Elbow	3"ø-3"ø-3"ø	PCS	2			
	ABS Tee Reducer Elbow	3"ø-3"ø-1 1/2"ø	PCS	3			
	ABS Tee Reducer Elbow	3"ø-3"ø-2"ø	PCS	1			
	ABS Vent Cap Elbow	1 1/2"ø	PCS	1 1			
	ABS Vent Cap Elbow	2"ø					
			PCS PCS	1			
	ABS Vent Cap Elbow	3"ø		1			
	PEX 90 Degree Elbow	1/2"ø-1/2"ø	PCS	26			
	PEX 90 Degree Elbow	3/4"ø-3/4"ø	PCS	4			
	PEX Tee Elbow	1"ø-1"ø	PCS	1			
	PEX Tee Elbow	1/2"ø-1/2"ø-1/2"ø	PCS	8			
	PEX Tee Elbow	3/4"ø-3/4"ø-3/4"ø	PCS	2			
	PEX Transition Elbow	1"ø-1/2"ø	PCS	3			
	PEX Transition Elbow	1"ø-3/4"ø	PCS	6			
23	PEX Transition Elbow	3/4"ø-1/2"ø	PCS	9			
24	PEX Transition Elbow	3/4"ø-3/4"ø	PCS	1			
25	PVC 90 Deg Bend Elbow	2"ø-2"ø	PCS	24			
	WASTE DOUBLE TEE	1 1/2"ø-1 1/2"ø-1 1/2"ø-1	PCS	1			

	LA County_1200_3Bd1Ba								
HVAC SYSTEM MATERIAL SHOPPING LIST									
No.	Item	Туре	Unit	Quantity	Unit Price	Total	Description		
	HVAC_DUCTS								
1	PIPE (REFRIGERANT LINE)	3/8" Ø	FT	75.89					
2	PIPE (REFRIGERANT LINE)	3/4" Ø	FT	131.4					
3	DRAYER HOSE	5" Ø	FT	9.3					
4	FLEX DUCT ROUND	4"	FT	8.19					
	DUCT FITTINGS & ACCESSORIES								
	CROSS (REFRIGERANT LINE)	3/4"(Ø)-3/4" Ø)-3/4" Ø)-3/4" Ø)		1					
6	CROSS (REFRIGERANT LINE)	3/8"(Ø)-3/8"(Ø)-3/8"(Ø)-3/8"(Ø)		1					
7	ELBOW (REFRIGERANT LINE)	1/2" (Ø)-1/2" (Ø)	PCS	2					
8	ELBOW (REFRIGERANT LINE)	3/4" (Ø)-3/4" (Ø)	PCS	34					
9	ELBOW (REFRIGERANT LINE)	3/8" (Ø)-3/8" (Ø)	PCS	22					
10	TEE (REFRIGERANT LINE)	3/4" (Ø)-3/4" (Ø)-3/4" (Ø	PCS	1					
11	TEE (REFRIGERANT LINE)	3/8" (Ø)-3/8" (Ø)-3/8" (Ø)	PCS	1					
12	TRANSITION (REFRIGERANT	3/4" (Ø)-1/2" (Ø)	PCS	9					
13	TRANSITION (REFRIGERANT	3/4" (Ø)-5/8" (Ø)	PCS	4					
14	TRANSITION (REFRIGERANT	3/8" (Ø)-1/4" (Ø)	PCS	1					
\triangle	HVAC_EQUIPMENTS								
15	AIR HANDLING UNIT	WALL MOUNTED	PCS	5					
16	CONDENSER	OUTDOOR UNIT	PCS	1					
17	EXHAUST FAN	75 CFM	PCS	1					
18	EXHAUST HOOD	WALL MOUNTED	PCS	1					
19	HOOD-WALL: VENT	HOOD-WALL: VENT	PCS	1					
20	DRAYER: VENT	DRAYER: VENT	PCS	1					
21	ROOF VENT	3"(Ø)	PCS	1					



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Have It Your Way!

The material types listed in this document were selected based on personal preferences. The Customer is encouraged to make changes to the material types in accordance with local customs, regulations, and personal preferences. Have It Your Way!

GENERAL NOTES

- This BOM (Bill of Materials) is prepared as a Materials Shopping List to help builders and DIYers gain a complete understanding of most if not all elements required for the complete construction of this structure, according to the original design documents provided by FrameUpNow.
- 2 All quantities and specifications are subject to change based on the final design, field measurements, availability of products and customer preferences. The customer should verify all information prior to purchasing materials.
- 3 All products and elements in the list shall conform to the International Residential Code (IRC), or any other local and international building codes, safety regulations, and standards that are applicable to the location of the structure.
- 4 If any changes are made by the customer to the list of materials specified in this document, the customer is responsible for assuring that the correct type and quantity of materials are utilized in accordance with local building codes.
- FrameUpNow, will not be held responsible for any misuse of this document, the products listed, or for deviations from the content that are made due to changes in specifications, pricing, availability, or customer preferences.
- The customer is advised to consult a qualified professional or technician prior to purchasing materials for specialized construction system items. Some items including but not limited to caseworks, doors and windows may require as built measurements prior to purchase to confirmation of final dimensions.
- 7 If there are additional trim elements or specific installation methods, the total amount of materials needed might vary. Consider any additional trim required for corners, intersections, or other architectural details that might cause this variations before procedding to purchase and construction.



			LIGHTING FIXTURES				
#	Item	Туре	Description, Manufacturer, SKU	Unit	Quantity	Jnit Price	Total
1	Kitchen Ceiling Light			PCS	4		
3	Kitchen Wall Mounted Light			PCS	0		
4	Exterior Wall Mounted Light			PCS	2		
5	Livingroom Ceiling Light With Fan			PCS	1		
6	Bedroom Ceiling Light With Fan			PCS	3		
7	Dining Ceiling Light			PCS	7		
8	Bath Wall Mounted Light			PCS	1		
9	Bathroom Ceiling Light			PCS	2		
10	Livingroom Ceiling Light			PCS	8		
11	Bedroom Ceiling Light			PCS	12		
12	Hall & Entry Ceiling Light			PCS	3		
12	Closet Ceiling Light			PCS	0		
13	Smoke Detector			PCS	6		
14							
15							



			ELECTRICAL FITTINGS				
#	Item	Туре	Description, Manufacturer, SKU	Unit	Quantity	Unit Price	Total
1	Standard Receptacle 120V	20A		PCS	23		
2	GFCI Receptacle 120V	20 A		PCS	14		
3	GFCI Receptacle 240V	30 A		PCS	2		
1	GFCI Receptacle 240V	50 A		PCS	1		
5	GFCI Receptacle 240V	60 A		PCS	1		
ĵ.	Fan Switch			PCS	1		
7	Single Pole Switch			PCS	3		
3	Three Way Switch			PCS	7		
9	Dimmer Switch			PCS	7		
10		'		'			
l1							
12							
L3							
14							
15							



		ELECTR	ICAL CONDUITS & WIRING				
#	Item	Туре	Description, Manufacturer, SKU	Unit	Quantity	Unit Price	Total
1	ROMEX 14 AWG	14/3/W/ground		FT	93		
3	ROMEX 12 AWG	12/3/W/ground		FT	313		
4	ROMEX 12 AWG	12/2/W/ground		FT	0		
6	ROMEX 10 AWG	10/3/W/ground		FT	114		
8	ROMEX 10 AWG	10/2/W/ground		FT	46		
9	Romex 8 AWG	8/3/W/ground		FT	0		
10	Romex 8 AWG	8/2/W/ground		FT	12		
11	ROMEX 6 AWG	6/2/W/ground		FT	16		
12	Bare Copper Ground Wire 6 AWG			FT			
13							
14							
15							
16							



		ELEC	CTRICAL BOXES & CIRCUTES				
#	Item	Туре	Description, Manufacturer, SKU	Unit	Quantity	Unit Price	Total
1	Panelboard -240V 1 Phase MLO	200 AMP		PCS	1		
2	Circuit breaker	15 A		PCS	3		
3	Circuit breaker	20 A		PCS	12		
1	Circuit breaker	30 A		PCS	2		
5	Circuit breaker	50 A		PCS	1		
5	Circuit breaker	60 A		PCS	1		
7	Single Gang Switch Box			PCS	4		
3	Double Gang Switch Box			PCS	4		
)	Triple Gang Switch Box			PCS	2		
LO	Pull Box	#1/4		PCS	45		
11	Receptacle Box			PCS	41		
L2							
L3							
14							
L5							

			HVAC_DUCTS 01				
#	Item	Туре	Description, Manufacturer, SKU	Unit	Quantity	Unit Price	Total
1	PIPE (REFRIGERANT LINE)	3/8" (Ø)		FT	75.89		
2	PIPE (REFRIGERANT LINE)	3/4"' (Ø)		FT	131.4		
3	DRAYER HOSE	4" (Ø)		FT	9.3		
4	FLEX DUCT ROUND	4" (Ø)		FT	8.19		
5							
6							
7							
8							
9							
10							
11							
12							
13							
14							
15							
16							

			OUCT FITTINGS & ACCESSORIES				
#	Item	Туре	Description, Manufacturer, SKU	Unit	Quantity	Unit Price	Total
1	CROSS (REFRIGERANT LINE)	3/4"(Ø)-3/4" Ø)-3/4" Ø)-3/4" Ø)		PCS	1		
2	CROSS (REFRIGERANT LINE)	3/8"(Ø)-3/8"(Ø)-3/8"(Ø)-3/8"(Ø)		PCS	1		
3	ELBOW (REFRIGERANT LINE)	1/2" (Ø)-1/2" (Ø)		PCS	2		
4	ELBOW (REFRIGERANT LINE)	3/4" (Ø)-3/4" (Ø)		PCS	34		
5	ELBOW (REFRIGERANT LINE)	3/8" (Ø)-3/8" (Ø)		PCS	22		
6	TEE (REFRIGERANT LINE)	3/4" (Ø)-3/4" (Ø)-3/4" (Ø		PCS	1		
7	TEE (REFRIGERANT LINE)	3/8" (Ø)-3/8" (Ø)-3/8" (Ø)		PCS	1		
8	TRANSITION (REFRIGERANT LINE)	3/4" (Ø)-1/2" (Ø)		PCS	9		
9	TRANSITION (REFRIGERANT LINE)	3/4" (Ø)-5/8" (Ø)		PCS	4		
10	TRANSITION (REFRIGERANT LINE)	3/8" (Ø)-1/4" (Ø)		PCS	1		
11							
12							
13							
14							
15							
16							

			HVAC_EQUIPMENTS				
#	Item	Туре	Description, Manufacturer, SKU	Unit	Quantity	Unit Price	Total
1	AIR HANDLING UNIT	WALL MOUNTED		PCS	5		
2	CONDENSER	OUTDOOR UNIT		PCS	1		
3	EXHAUST FAN	75 CFM		PCS	1		
4	EXHAUST HOOD	WALL MOUNTED		PCS	1		
5	HOOD-WALL: VENT	HOOD-WALL: VENT		PCS	1		
6	DRAYER: VENT	DRAYER: VENT		PCS	1		
7	ROOF VENT	3"(Ø)		PCS	1		
8							
9							
10							
11							
12							
13							
14							



		PLUMBIN	NG FIXTURES & ACCESSORIES				
#	Item	Туре	Description, Manufacturer, SKU	Unit	Quantity	Unit Price	Total
1	Bath Tub (Alcove Tub)			PCS	C		
2	Kitchen Sink Double			PCS	1		
3	Kitchen faucets			PCS	1		
4	Vanity Sink			PCS	1		
5	Bath room faucets			PCS	1		
6	Water Closet			PCS	1		
7	Shower Trim			PCS	1		
8	Shower Tray			PCS	1		
9	Water Heater			PCS	1		
10	Hose Bib			PCS	1		
11	Shutoff Valve			PCS	6		
12	Hanging pipe clamp			PCS	20		
13	Gate Valve			PCS	1		
14	Dishwasher Supply Single Connector			PCS	1		
15	Dishwasher Sewage Single Connector			PCS	1		
16	Laundry Sweat Connector			PCS	1		



		SAN	ITARY & PLUMBING PIPES				
#	Item	Туре	Description, Manufacturer, SKU	Unit	Quantity	Unit Price	Total
1	ABS (Acrylonitrile Butadiene Styrene) Pipes	ø 1"		FT	0		
2	ABS (Acrylonitrile Butadiene Styrene) Pipes	ø 1 1/2"		FT	36		
3	ABS (Acrylonitrile Butadiene Styrene) Pipes	ø 2"		FT	23		
4	ABS (Acrylonitrile Butadiene Styrene) Pipes	ø 3"		FT	32		
5	PEX (Cross-linked polyethylene) Pipes	ø 1/2"		FT	75		
6	PEX (Cross-linked polyethylene) Pipes	ø 3/4"		FT	22		
7	PEX (Cross-linked polyethylene) Pipes	ø 1"		FT	0		
8	PVC Pipes Sch.80 - Rigid	ø 1 1/2"		FT	0		
9	PVC Pipes Sch.80 - Rigid	ø 2"		FT	65		
10	PVC Pipes Sch.80 - Rigid	ø 3"		FT	0		
11	Flex Pipe Round	ø 1/2"		PCS	6		
12							
13							
14							
15							



		PIPE	FITTINGS 01				
#	Item	Туре	Description, Manufacturer, SKU	Unit	Quantity	Unit Price	Total
1	ABS 90 Degree Bend Elbow	1 1/2"ø-1 1/2"ø		PCS	4		
2	ABS 90 Degree Bend Elbow	2"ø-2"ø		PCS	1		
3	ABS 90 Degree Bend Elbow	3"ø-3"ø		PCS	3		
4	ABS P-Trap	1 1/2"ø-1 1/2"ø		PCS	4		
5	ABS P-Trap	2"Ø-2"Ø		PCS	2		
6	ABS Reducer Elbow	2"ø-1 1/2"ø		PCS	1		
7	ABS Reducer Elbow	3"ø-1 1/2"ø		PCS	1		
8	ABS TEE Elbow	1 1/2"ø-1 1/2"ø-1 1/2"ø		PCS	2		
9	ABS TEE Elbow	2"ø-2"ø-2"ø		PCS	1		
10	ABS TEE Elbow	3"ø-3"ø-3"ø		PCS	2		
11	ABS Tee Reducer Elbow	3"ø-3"ø-1 1/2"ø		PCS	3		
12	ABS Tee Reducer Elbow	3"ø-3"ø-2"ø		PCS	1		
13	ABS Vent Cap Elbow	1 1/2"ø		PCS	1		
14	ABS Vent Cap Elbow	2"ø		PCS	1		
15	ABS Vent Cap Elbow	3"ø		PCS	1		



		PIPE FI	TTINGS 02				
#	Item	Туре	Description, Manufacturer, SKU	Unit	Quantity	Unit Price	Total
	PEX 90 Degree Elbow	1/2"ø-1/2"ø		PCS	26		
	PEX 90 Degree Elbow	3/4"ø-3/4"ø		PCS	4		
	PEX Tee Elbow	1"Ø-1"Ø		PCS	1		
	PEX Tee Elbow	1/2"ø-1/2"ø-1/2"ø		PCS	8		
	PEX Tee Elbow	3/4"ø-3/4"ø-3/4"ø		PCS	2		
	PEX Transition Elbow	1"ø-1/2"ø		PCS	3		
	PEX Transition Elbow	1"ø-3/4"ø		PCS	6		
	PEX Transition Elbow	3/4"ø-1/2"ø		PCS	9		
	PEX Transition Elbow	3/4"ø-3/4"ø		PCS	1		
0	PVC 90 Deg Bend Elbow	2"Ø-2"Ø		PCS	24		
1	WASTE DOUBLE TEE	1 1/2"ø-1 1/2"ø-1 1/2"ø-1 1/2"ø		PCS	1		
2							
3							
4							
5							



			APPLIANCES				
#	Item	Туре	Description, Manufacturer, SKU	Unit	Quantity	Unit Price	Total
1	Refrigerator			PCS			
2	Range			PCS			
3	Washer Front Load	Stackable		PCS			
4	Dryer Front Load	Stackable		PCS			
5	Dish Washer			PCS			
6	Oven			PCS	(
7	Microwave			PCS	(
8							
9							
10							
11							
12							
13							
14							
15							
16							



			CASEWORKS 01				
#	Item	Туре	Description, Manufacturer, SKU	Unit	Quantity	Unit Price	Total
1	Kitchen Cabinet			FT	24.56		
2	Laundry Cabinet			FT	0		
3	Vanity Cabinet			FT	2.5		
4	Medicine Cabinet			PCS	1		
5	Kitchen countertop			SF	43.1		
6	Laundry Countertop			PCS	0		
7	Bathroom Countertop			SF	0		
8	Island			FT	0		
9	Peninsula			FT	0		
10	Closets			SF	135		
11							
12							
13							
14							
15							



			CEILING 01				
‡	Item	Туре	Description, Manufacturer, SKU	Unit	Quantity	Unit Price	Total
	LIVING ROOM + KITCHEN + I	DINING		SF	543.2	2	
1	Ceiling Board	Drywall		SF	543	}	
	Drywall Fastener	Screw		PCS	951		
}	Vapor Retarder	Polyethylene film		SF	543		
1	Vapor Retarder Fastener	Nails with washer heads		PCS	1630		
	BATH ROOM			SF	55.5	,	
5	Ceiling Board	MRD (Moisture resistant drywall)		SF	55		
5	MRD Fastener	Screw		PCS	97	,	
	BEDROOM 1			SF	127.1		
7	Ceiling Board	Drywall		SF	127	,	
3	Drywall Fastener	Screw		PCS	222		
)	Vapor Retarder	Polyethylene film		SF	127	,	
.0	Vapor Retarder Fastener	Nails with washer heads		PCS	381		
	BEDROOM 2			SF	127.1		
l1	Ceiling Board	Drywall		SF	127		
12	Drywall Fastener	Screw		PCS	222		
13	Vapor Retarder	Polyethylene film		SF	127		
L4	Vapor Retarder Fastener	Nails with washer heads		PCS	381		



			CEILING 02				
#	Item	Туре	Description, Manufacturer, SKU	Unit	Quantity	Unit Price	Total
	BEDROOM 3			SF	109.2		
15	Ceiling Board	Drywall		SF	109		
16	Drywall Fastener	Screw		PCS	191		
17	Vapor Retarder	Polyethylene film		SF	109		
18	Vapor Retarder Fastener	Nails with washer heads		PCS	328		
	HALL			SF	60.5		
19	Ceiling Board	Drywall		SF	61		
20	Drywall Fastener	Screw		PCS	106		
21	Vapor Retarder	Polyethylene film		SF	61		
22	Vapor Retarder Fastener	Nails with washer heads		PCS	182		
	CLOSET 1			SF	15.0		
23	Ceiling Board	Drywall		SF	15		
24	Drywall Fastener	Screw		PCS	26		
25	Vapor Retarder	Polyethylene film		SF	15		
26	Vapor Retarder Fastener	Nails with washer heads		PCS	45		



			CEILING 03				
#	Item	Туре	Description, Manufacturer, SKU	Unit	Quantity	Unit Price	Total
	CLOSET 2			SF	14.7		
27	Ceiling Board	Drywall		SF	15		
28	Drywall Fastener	Screw		PCS	26		
29	Vapor Retarder	Polyethylene film		SF	15		
30	Vapor Retarder Fastener	Nails with washer heads		PCS	44		
	CLOSET 3			SF	14.7		
31	Ceiling Board	Drywall		SF	15		
32	Drywall Fastener	Screw		PCS	26		
33	Vapor Retarder	Polyethylene film		SF	15		
34	Vapor Retarder Fastener	Nails with washer heads		PCS	44		
	W/D			SF	10.3		
35	Ceiling Board	Drywall		SF	10		
36	Drywall Fastener	Screw		PCS	18		
37	Vapor Retarder	Polyethylene film		SF	10		
38	Vapor Retarder Fastener	Nails with washer heads		PCS	31		



			FLOORING INTERIOR 01				
#	Item	Туре	Description, Manufacturer, SKU	Unit	Quantity	Unit Price	Total
	BEDROOM #1						
1	Bedroom Flooring			SF	128		
2	Wood underlay	Foam Pad Polyethylene		SF	128		
3	Vapor Retarder	Vapor Barrier Polyethylene		SF	128		
	BEDROOM#2						
4	Bedroom Flooring			SF	129		
5	Wood underlay	Foam Pad Polyethylene		SF	129		
6	Vapor Retarder	Vapor Barrier Polyethylene		SF	129		
	BEDROOM#3						
7	Bedroom Flooring			SF	111		
8	Wood underlay	Foam Pad Polyethylene		SF	111		
9	Vapor Retarder	Vapor Barrier Polyethylene		SF	111		
	CL#1						
10	Closet Flooring			SF	16		
11	Wood underlay	Foam Pad Polyethylene		SF	16		
12	Vapor Retarder	Vapor Barrier Polyethylene		SF	16		



			FLOORING INTERIOR 02				
#	Item	Туре	Description, Manufacturer, SKU	Unit	Quantity	Unit Price	Total
	CL#2						
13	Closet Flooring			SF	15		
14	Wood underlay	Foam Pad Polyethylene		SF	15		
15	Vapor Retarder	Vapor Barrier Polyethylene		SF	15		
	CL#3						
16	Closet Flooring			SF	16		
17	Wood underlay	Foam Pad Polyethylene		SF	16		
18	Vapor Retarder	Vapor Barrier Polyethylene		SF	16		
	KITCHEN						
19	Kitchen Flooring			SF	95		
20	Wood underlay	Foam Pad Polyethylene		SF	95		
21	Vapor Retarder	Vapor Barrier Polyethylene		SF	95		
	LIVING ROOM AND DINNIN	NG					
22	Living Area Flooring			SF	513		
23	Wood underlay	Foam Pad Polyethylene		SF	513		
24	Vapor Retarder	Vapor Barrier Polyethylene		SF	513		



			FLOORING INTERIOR 03				
#	Item	Туре	Description, Manufacturer, SKU	Unit	Quantity	Unit Price	Total
	BATHROOM						
25	Tile Finish			SF	40		
26	Adhesive	1/2" Thin set Mortar		SF	40		
27	Vapor Retarder	Vapor Barrier Polyethylene		SF	40		
	W/D						
28	Tile Finish			SF	11		
29	Adhesive	1/2" Thin set Mortar		SF	11		
30	Vapor Retarder	Vapor Barrier Polyethylene		SF	11		



			FLOORING EXTERIOR				
#	Item	Туре	Description, Manufacturer, SKU	Unit	Quantity	Unit Price	
	STRUCTURE			SF	1200.0		
1	Concrete Slab	4"concrete cast in situ		CF	400		
2	Insulation	Rigid insulation		SF	280		
3	Hard core	Compacted soil		CF	325		
4	Re-bar	#4 re-bar		Ton	1		
5	Concrete Pad	4"concrete cast in situ		CF	2		
6	Slab edge	Turndown		CF	296		



			WALLS: EXTERIOR				
#	Item	Туре	Description, Manufacturer, SKU	Unit	Quantity	Unit Price	Total
1	Stucco Finish			SF	1111		
2	Wall Shteathing (OSB)			SF	1111		
3	Shteathing Fastener	Self-drilling screws(100/pkt)		PKT	11.11		
4	Wall Homewrap			SF	1111.0		
5	Homewrap Fastener	Stapled fastener (200/pkt)		PKT	4.2		
6	Wall Paint			SF	1111		
7	Stone Copping	Masonry stone		SF	10		
8	Stone Veneer	Masonry stone		SF	0		
9	Mortar for Stone Veneer			SF	0		
10	Wall Insulation			SF	3787		



			WALLS: INTERIOR 01				
#	Item	Туре	Description, Manufacturer, SKU	Unit	Quantity	Unit Price	Total
	BATHROOM			SF	62.0		
1	Cementitious Backer Board			SF	218		
2	Kerdi membrane			SF	218		
3	Kerdi membrane Fastener			SF	218	3	
4	Wall Ceramic Tile			SF	218		
	BEDROOM 1			SF	105.0		
5	Drywall Board			SF	277	,	
6	Drywall Fastener	Self-drilling screws(100/pkt)		PKT	2.77	,	
7	Wall Paint			SF	277	,	
8	Drywall Tape			FT	51.9		
	BEDROOM 2			SF	164.0		
9	Drywall Board			SF	277		
10	Drywall Fastener	Self-drilling screws(100/pkt)		PKT	2.77	,	
11	Wall Paint			SF	277		
12	Drywall Tape			FT	51.9		



			WALLS: INTERIOR 02				
#	Item	Туре	Description, Manufacturer, SKU	Unit	Quantity	Unit Price	Total
	BEDROOM 3			SF	164.0		
13	Drywall Board			SF	277		
14	Drywall Fastener	Self-drilling screws(100/pkt)		PKT	2.77		
15	Wall Paint			SF	277		
16	Drywall Tape			FT	51.9		
	KITCHEN			SF	108.0		
17	Cementitious Backer Board			SF	30		
18	Drywall Board			SF	242		
19	Drywall Fastener	Self-drilling screws(100/pkt)		PKT	2.42		
20	Kerdi membrane			SF	30		
21	Kerdi membrane Fastener			SF	30		
22	Wall Ceramic Tile			SF	30		
23	Wall Paint			SF	242		
24	Drywall Tape			FT	45.7		



			WALLS: INTERIOR 03				
#	Item	Туре	Description, Manufacturer, SKU	Unit	Quantity	Unit Price	Total
	CL 1			SF	14.0		
25	Drywall Board			SF	111		
26	Drywall Fastener	Self-drilling screws(100/pkt)		PKT	1.11		
27	Wall Paint			SF	111		
28	Drywall Tape			FT	20.8		
	CL 2			SF	13.0		
29	Drywall Board			SF	110		
30	Drywall Fastener	Self-drilling screws(100/pkt)		PKT	1.1		
31	Wall Paint			SF	110		
32	Drywall Tape			FT	20.6		
	CL 3			SF	416.0		
33	Drywall Board			SF	110		
34	Drywall Fastener	Self-drilling screws(100/pkt)		PKT	1.1		
35	Wall Paint			SF	110		
36	Drywall Tape			FT	20.6		



			WALLS: INTERIOR 04				
#	Item	Туре	Description, Manufacturer, SKU	Unit	Quantity	Unit Price	Total
	WD			SF	13.0		
37	Cementitious Backer Board			SF	85		
38	Kerdi membrane			SF	85		
39	Kerdi membrane Fastener			SF	85		
40	Wall Ceramic Tile			SF	85		
	HALL			SF	89.0		
41	Drywall Board			SF	204		
42	Drywall Fastener	Self-drilling screws(100/pkt)		PKT	2.04		
43	Wall Paint			SF	204		
44	Drywall Tape			FT	38		
	LIVING ROOM			SF	416.0		
45	Drywall Board			SF	401		
46	Drywall Fastener	Self-drilling screws(100/pkt)		PKT	4.01		
47	Wall Paint			SF	401		
48	Drywall Tape			FT	75.2		



			WALLS: INTERIOR 04				
#	Item	Туре	Description, Manufacturer, SKU	Unit	Quantity	Unit Price	Total
	DINING ROOM			SF	101.0		
49	Drywall Board			SF	187		
50	Drywall Fastener	Self-drilling screws(100/pkt)		PKT	1.87		
51	Wall Paint			SF	187		
52	Drywall Tape			FT	35.1		
1		Ceramic					
	Wall Skilling	Ceramic		FT	265		



			DOORS				
#	Item	Туре	Description, Manufacturer, SKU	Unit	Quantity	Unit Price	Total
1	Exterior Swinging	3' - 0" X 6'- 8"		PCS	1		
2	Interior Swinging	2' - 4" X 6'-8"		PCS	3		
3	Interior Swinging	2' - 8" X 6'-8"		PCS	1		
4	Bifold	2' - 8" X 6'- 8"		PCS	1		
5	Interior Sliding	6' - 0" X 6'- 8"		PCS	3		
6	Exterior Door Trim			FT	17		
7	Interior Door Trim			FT	291		
8	Entry Lock set			PCS	2		
9	Privacy Lock set			PCS	3		
10	Passage Lock set			PCS	3		



			WINDOWS				
#	Item	Туре	Description, Manufacturer, SKU	Unit	Quantity	Unit Price	Total
1	Sliding	3' - 3" X 2'-3"		PCS	1		
2	Sliding	6' - 3" X 4'-3"		PCS	4		
3	Sliding	4' - 3" X 4'-3"		PCS	3		
4	Exterior Window Trim			FT	148		
5	Interior Window Trim			FT	148		



			ROOF 01				
#	Item	Туре	Description, Manufacturer, SKU	Unit	Quantity	Unit Price	Total
1	Roof Covering			SF	1496.0		
2	Roof Covering Fastener			PCS	748		
3	Roof Felt Paper			SF	1496.0		
4	Roof Felt Paper Fastener			PCS	4488.0		
5	Roof Sheathing			SF	1496.0		
6	Roof Sheathing Fastener			PCS	11968		
7	Batten			FT	774.0		
8	Batten Fastener			PCS	582.0		
9	Soffit			SF	225.0		
10	Soffit Fastener			PCS	112.5		
11	Fascia			FT	156.0		
12	Fascia board fastener			PCS	78		
13	Roof Insulation			SF	1496.0		
14							
15							