
# Acoustic+ UltraWall©

Product Specification Sheet



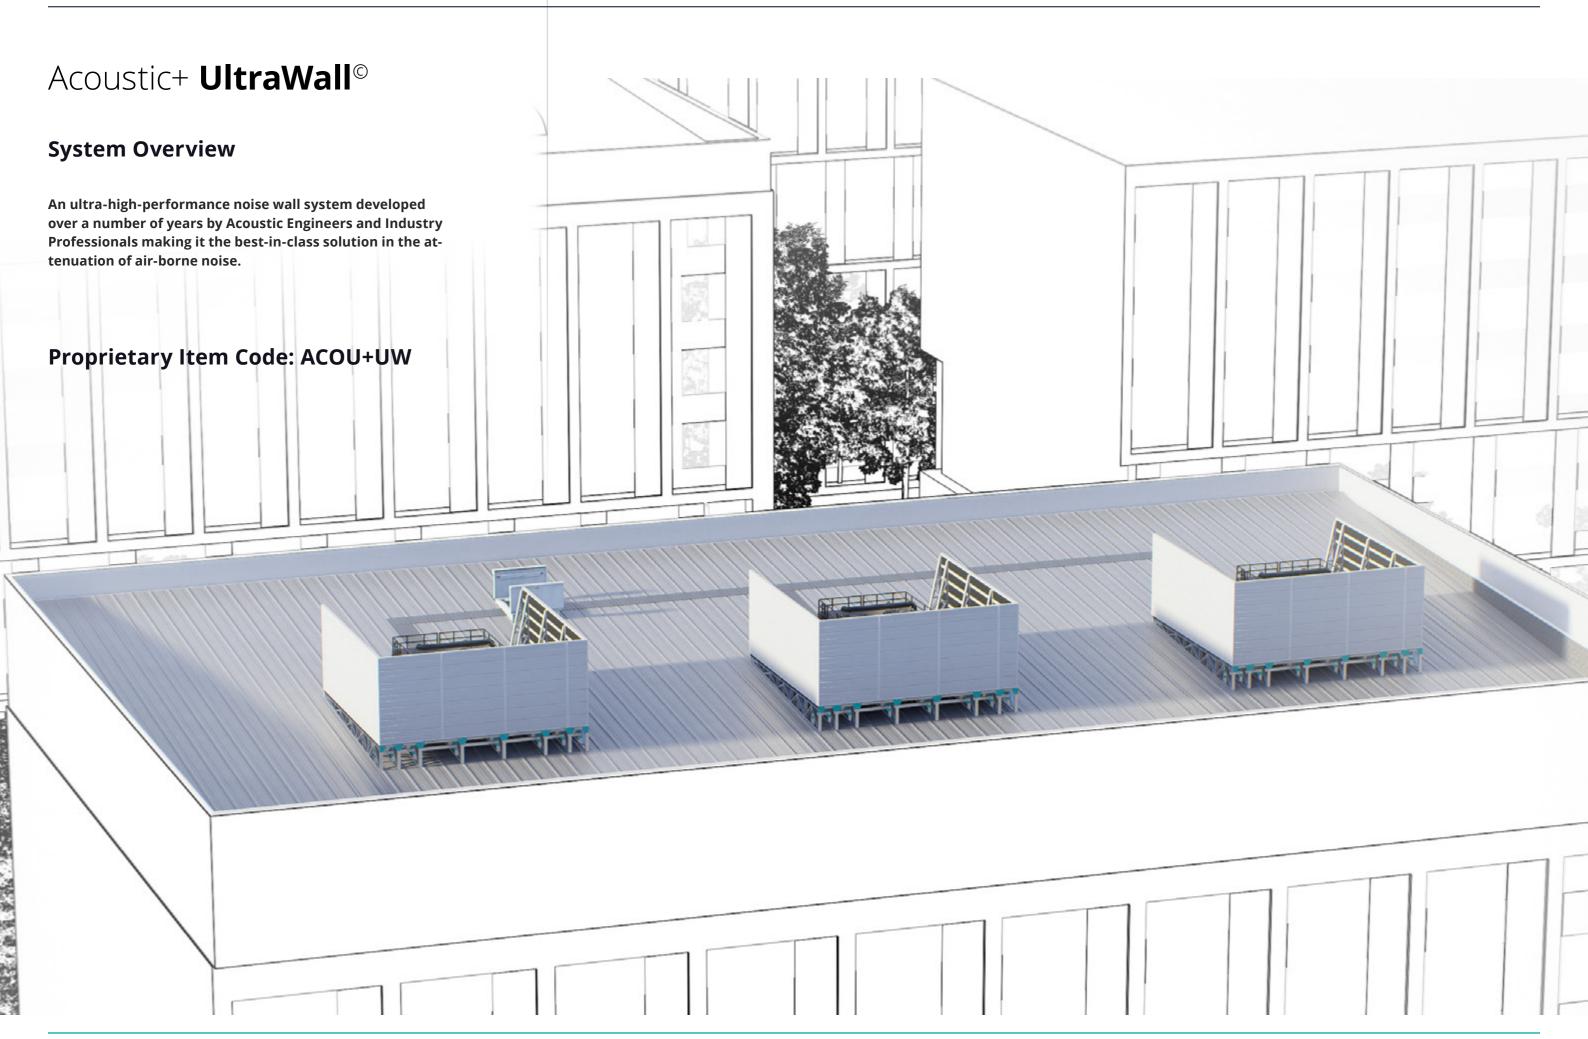

# Acoustic+ UltraWall©

#### **Applications and Advantages**


- > Large format stores Shopping Centres Supermarkets
- > Large condenser platform screening.
- > General architectural screening.
- > Compressor enclosures and screening.
- > Other mechanical plant equipment enclosures.
- > Acoustic+ is Australia's leading external acoustic wall system in performance, design and value.
- > Con-form Group's most effective system at reducing sound energy due to its three phase operation (absorbing reflecting absorbing).
- > Non-invasive perfect to retrofit.
- > Can be fitted directly to existing metal deck roofs.
- > Structural components provide highly durable, long-term stability and performance.
- > Built to withstand all weather conditions.
- > Absorptive barrier is moisture resistant, UV resistant and fire retardant.
- > Easy assembly, design reduces the need for additional structural requirements.
- > System remains flexible during and after project design, allowing for changes late into the construction stage.

#### **Technical Data**

- > Weight's vary depending on selected screen solution.
- > Heights include 1200mm, 1600mm, 2000mm 2400mm (custom heights also available).
- > Our screening solutions can be sized to suit any plant equipment allowing sufficient area around the units for access (available in any length to suit your needs).
- > Standard Heights: 1200mm, 1600mm, 2000mm, & 2400mm

#### Fire Resistance:

- > When tested in accordance with AS1530.3 (1999), "Early Fire Hazard Properties of Materials", PSB exhibit the following characteristics:
  - Ignitability Index: 0
  - · Spread of Flame Index: 0
  - · Heat Evolved: 0
  - Smoke Developed Index: 0 3

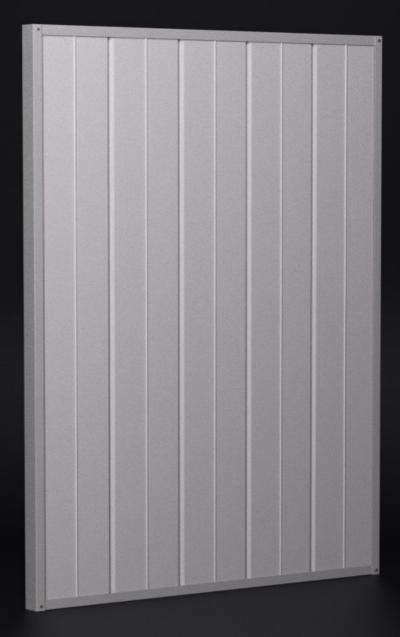

#### **Acoustic Performance**

- > Acoustic Performance: Available in five density options to suite your site-specific needs:
- > All options have a noise absorbative surface as a standard.
- > Option A =  $14.5 \text{ kg/m}^2$
- > Option B = 20 kg/m2
- > Option C = 25.5kg/m2
- > Option D = 30kg/m2
- > Option E = 36kg/m2
- > NRC (Noise Reduction Coefficient) = 1.05

#### **Environmental & Health Benefits:**

- > Recycled Fibre Content: 80% minimum.
- > Volatile Organic Compounds (VOC's): No harmful VOC's.
  - Formaldehyde Content: Nil
  - · Phenol Content: Nil
  - Ammonia Content: Nil
  - Ozone Depleting Potential (ODP): Nil
  - Chloride Content
  - Total Recyclable Content: 100%



#### **Moisture Resistance:**

> Exposure to an atmosphere of 50°C and 95% relative humidity for 4 days results in less than 0.2% by vol moisture absorption.

#### **Maximum Service Temperature:**

- > The maximum temperature to which Acoustic+ should be exposed in service is 150°C.
  - PET (polyethylene terephthalate)is made from 80% recycled materials and unaffected my moisture making it ideal for

#### Warranty

- > All steel components are backed by a 25 year warranty.
- > Replaceable items are covered by a 10-Year Warranty.



#### Maintenance

- > Visual inspection for any damage or loose fittings is recommended annually. Report any damage or loose fixings to asset manager or building owner for correction.
- > No certified maintenance is required that effects lifespan or performance of product.

#### **Colour Options**

> Available in three popular Colorbond colour choices.







#### Certification

- > Australian Standards: AS1170.1, AS1170.2, AS1657 & AS1664.1 & Relevant Clauses of the Building Code of Australia
- > Wind loads in accordance with AS/NZS 1170.2, and based on the following parameters: VR,500 = as listed below; and Ms = 1.00, Mt = 1.00, Md, =1.00, and Mz,cat.
- > Wind Loads: Con-form products have been certified for wind regions A, B and C.
  - V500 = 45m/s Region A Tc 2.5
  - V500 = 57m/s Region B Tc 2.5
  - V500 = 66m/s Region C Tc 2.5




8 | EasyScreen - Acoustic+ UltraWall v1

# **Project examples**

# **Versatile system options**

Acoustic+ UltraWall© captures unwanted noise with its three-way absorb-reflect-absorb operation. At its core is a polyethylene material made from recycled products. The panel was developed for Con-form Group by a team including our engineers and acoustic industry professionals. Acoustic+ UltraWall© can be tuned to suit the noise output of each individual site

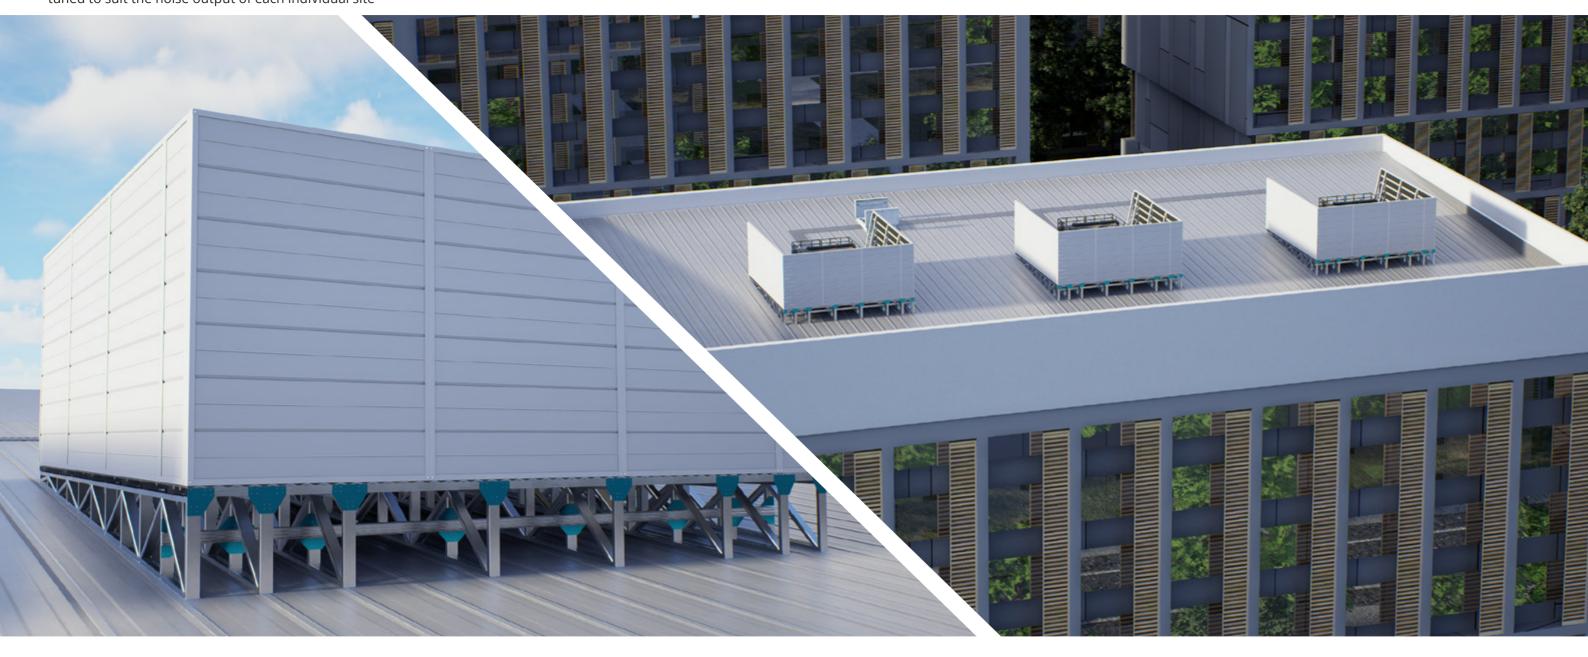









PARTS LIST						
ITEM	ITEM QTY	QTY	PART NUMBER	DESCRIPTION		
1	1	1	CFG-403-039-01	Acoustic+ DC, Side Channel, 1200H, LH A		
2	1	1	CFG-403-039-02	Acoustic+ DC, Side Channel, 1200H, RH A		
3	2	2	CFG-403-039-03	Acoustic+ DC, Top & Bottom Channel, 1800W, A		
4	5	5	CFG-403-043	Acoustic+ LouvreWall, Blade, 1200W, Option C, Asm , B		

REVISION HISTORY						
REV	DESCRIPTION	DATE	APPROVED			
Α	CREATED	03/06/2024	DW			

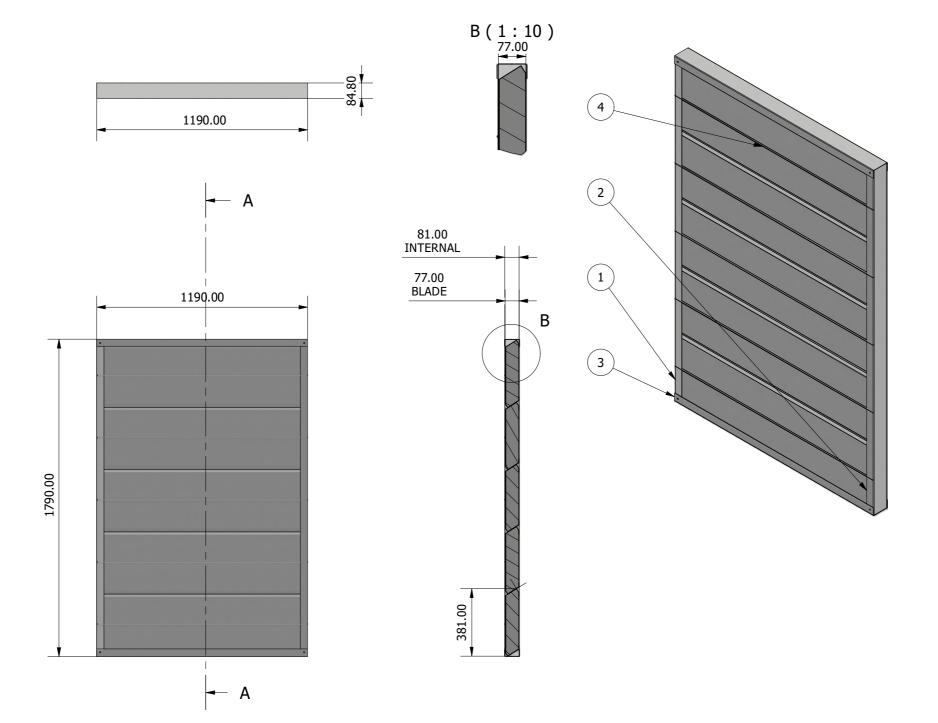

A-A (1:20)

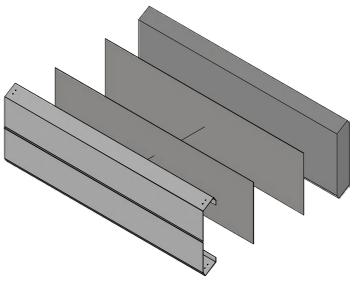

### **Design Notes:**

Partition Surface Mass: 25.5kg/m2 (Theoretical) NRC (Noise Reduction Coefficient) :10.5

Cassette Full MFG Dim. Refer Design: CFG-600-069

#### Material:



Making it **Easy** BATHURST NSW 2795,

19 CORPORATION AVE ,BATHURST NSW 2795, info@conformgroup.com.au 1300 882 490 ALL DIMS. GIVEN IN MM

Scale: 1:20 REV: A

Product

Acoustic+ UltraWall, Panel, 1800W, 1200H, Option C, Asm, A

Drawing Title

CFG-403-047

Sheet 1 OF 1



## **Our Capability Brands**











